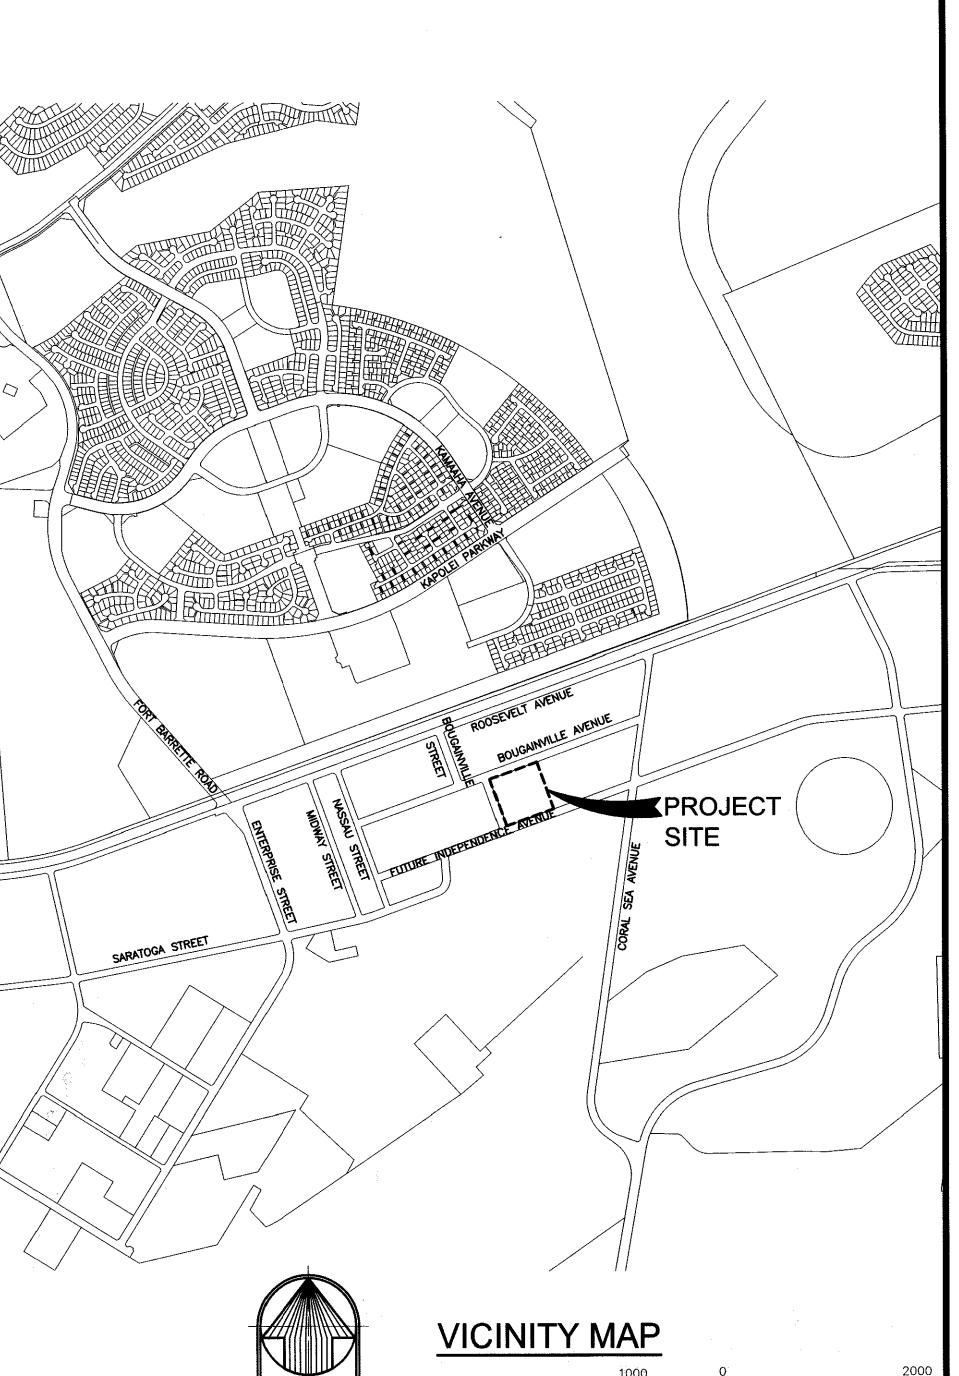


SITE AMENITIES IMPROVEMENTS KALAELOA RENTAL HOMES SITE

LOCATED AT: 4285 INDEPENDENCE ROAD KAPOLEI, OAHU, HAWAII, 96707 TMK: FIRST DIVISION, 9-1-013:014

PREPARED FOR:

DINAPOLI CAPITAL PARTNERS 5532 LILLEHAMMER LANE, SUITE 200 PARK CITY, UT 84098



SCALE IN FEET

INDEX OF D	DRAWINGS					ABI	BREVIATIONS	-
	OUEET NO	DECODIDITION				AC	ASPHALT CONCRETE ACRE	
<u>DRWG NO.</u>	SHEET NO.	DESCRIPTION				AC ADA	AMERICAN DISABILITY ACT	
CIVIL						BC BL	BOTTOM OF CURB BASE LINE	1.1
		TITLE OLIFET DOOLEOT LOOATION MADO DOAMING INDEV AND	D ADDDEVIATIONS			BWS	BOARD OF WATER SUPPLY	
1	T-1	TITLE SHEET, PROJECT LOCATION MAPS, DRAWING INDEX ANI	D ARRENIATION2			CL CONC	CENTERLINE CONCRETE	
2	C-1	CONSTRUCTION NOTES				COTG	CLEANOUT TO GRADE	
2a	C-1a	CONSTRUCTION NOTES 1a				CY D	CUBIC YARDS DRAIN	
3	C-2	GENERAL SITE PLAN DEMOLITION AND EROSION CONTROL PLAN				DI	DRAIN INLET DEPARTMENT OF PUBLIC WORKS (CITY)	
4	C-3 C-4	SITE AND UTILITY PLAN				DPW DS	DOWNSPOUT	
6	C-5	GRADING AND DRAINAGE PLAN				DTL DWGS	DETAIL DRAWINGS	
7	C-6	POOL DECK ENLARGEMENT				EG	EXISTING GRADE	
8	C-7	PARKING LOT AND WALKWAY DETAILS				ELECT EL, ELEV	ELECTRICAL / ELEVATION	
9	C-8	DRAINAGE AND DOG PARK DETAILS				EXIST	EXISTING	
10	C-9	WATER AND SEWER DETAILS				FF FG	FINISH FLOOR FINISH GRADE	
11	C-10	FENCE DETAILS				FH	FIRE HYDRANT	
12	C-11	EROSION CONTROL AND MISCELLANEOUS DETAILS				G GPM	GAS LINE GALLONS PER MINUTE	
12a	CS-1	SITE SECTION KEY PLAN				GV	GATE VALVE INVERT	_
12b	CS-2	SITE SECTIONS 1				INV IRR	IRRIGATION	
12c	CS-3	SITE SECTIONS 2	DRWG NO.	SHEET NO.	DESCRIPTION	MIN OC	MINIMUM ON CENTER	
			VALATED EEATH			o/s	OFFSET	
<u>LANDSCAPE</u>			WATER FEATU	<u>KE</u>		PAVT PSI	PAVEMENT POUNDS PER SQUARE INCH	ſ
13	L100	OVERALL LANDSCAPE PLAN	25	WF-001	GENERAL NOTES & DRAWING INDEX	S	SEWER	-
14	L201	TREE DISPOSITION PLAN AND SCHEDULE	26	WF-002	OVERALL SITE PLAN	SB SHT	SPLASH BLOCK SHEET	
15	L202	TREE DISPOSITION DETAILS	27	WF-101	SWIMMING POOL PLAN	STA	STATION	-
16	L301	OVERALL IRRIGATION PLAN	28	WF-102	SWIMMING POOL SHELL PLAN	STD TC	STANDARD TOP OF CURB	
17	L302	IRRIGATION EQUIPMENT SCHEDULE, DETAILS AND NOTES	29	WF-103	SWIMMING POOL DEPTH MARKER PLAN	TP	TOP OF PAVEMENT	-
18	L303	IRRIGATION DETAILS	30	WF-104	CHILDREN'S POOL PLAN	TS TYP	TOP OF SIDEWALK TYPICAL	
19	L400	LANDSCAPE SOIL PLACEMENT PLAN	31	WF-105	CHILDREN'S POOL SHELL PLAN	W	WATER WITH	
20	L401	LANDSCAPE PLAN - 1	32	WF-106	CHILDREN'S POOL DEPTH MARKER PLAN	W/ V	VAN	•
21	L402	LANDSCAPE PLAN - 2	33	WF-201	SECTIONS			
22	L403	LANDSCAPE PLAN - 3	34	WF-202	SECTIONS			1
23	L404	LANDSCAPE PLAN - 4	35	WF-203	SECTIONS			-
24	L405	PLANT MATERIAL SCHEDULE AND NOTES	36	WF-204	SECTIONS			
25	L406	PLANTING DETAILS	37	WF-300	SWIMMING POOLS PIPE RUNS PLAN			
			38	WF-301	SWIMMING POOL FITTINGS PLAN			ļ
:			39	WF-302	SWIMMING POOL PIPING SCHEMATIC			•
			40 41	WF-303 WF-304	CHILDREN'S POOL FITTINGS PLAN CHILDREN'S POOL PIPING SCHEMATIC			
			42	WF-401	EQUIPMENT LAYOUT, LIST AND SYSTEM ANALYS	10		
			43	WF-501	TYPICAL DETAILS	10		
			44	WF-502	TYPICAL DETAILS			
1			45	WF-503	TYPICAL DETAILS			ļ
			46	WF-504	TYPICAL DETAILS			
			47	WF-601	SWIMMING POOL LIGHTING PLAN		I	J
		·	48	WF-602	CHILDREN'S POOL LIGHTING PLAN		I	i
			49	WF-701	EQUIPMENT PAD ELECTRICAL PLAN, SINGLE LIN	_		1
					DIAGRAM PANEL SCHEDULE, ENERGY BUDGET		1	
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BELT COLLINS

Planning • Civil Engineering Environmental Consulting

Consultant

Client & Project

Kalaeloa

Site Amenities Improvements

Kalaeloa Rental Homes Site Kalaeloa, Oahu, Hawaii

BE UNDER MY OBSERVATION.

Revisions REVISED SHEET NUMBERS AND

Sheet

TITLE SHEET, PROJECT LOCATION MAP, DRAWING INDEX AND ABBREVIATIONS

Project No. 2015.33.0601 Designed by:

Drawn by:

6/5/2017

MAY 2017

GENERAL CIVIL NOTES:

- 1. DIMENSIONS TAKE PRECEDENCE OVER SCALE.
- 2. NOTIFY THE ENGINEER PRIOR TO THE START OF CONSTRUCTION ACTIVITY.
- 3. VERIFY AND CHECK ALL DIMENSIONS AND DETAILS SHOWN ON THE DRAWINGS PRIOR TO THE START OF CONSTRUCTION. ANY DISCREPANCY SHALL BE IMMEDIATELY BROUGHT TO THE ATTENTION OF THE ENGINEER FOR CLARIFICATION.
- 4. THE CONTRACTOR SHALL OBSERVE AND COMPLY WITH ALL FEDERAL, AND LOCAL LAWS REQUIRED FOR THE PROTECTION OF PUBLIC HEALTH, SAFETY AND ENVIRONMENTAL QUALITY.
- 5. THE CONTRACTOR SHALL REMOVE ALL SILT AND DEBRIS RESULTING FROM HIS WORK DEPOSITED IN DRAINAGE FACILITIES, ROADWAYS AND OTHER AREAS. THE COSTS INCURRED FOR ANY NECESSARY REMEDIAL ACTION BY THE OWNER OR GOVERNMENT SHALL BE PAYABLE BY THE CONTRACTOR.
- THE EXISTENCE AND LOCATION OF UNDERGROUND UTILITIES AND STRUCTURES AS SHOWN ON THE PLANS ARE BASED ON THE LATEST AVAILABLE DATA. THE CONTRACTOR SHALL VERIFY THE LOCATIONS AND DEPTHS OF THE EXISTING UTILITIES SHOWN AND EXERCISE PROPER CARE IN EXCAVATING IN THE AREA.
- 7. WHEREVER CONNECTIONS OF NEW UTILITIES TO EXISTING UTILITIES ARE SHOWN, THE CONTRACTOR SHALL EXPOSE THE EXISTING LINES AT THE PROPOSED CONNECTIONS TO VERIFY THEIR LOCATIONS AND DEPTHS PRIOR TO EXCAVATION FOR THE NEW LINES. IF UTILITIES NOT SHOWN ARE ENCOUNTERED, OR IF POTENTIAL UTILITY CONFLICTS ARISE, NOTIFY THE ENGINEER IMMEDIATELY. THE CONTRACTOR SHALL PROVIDE STRUCTURAL SUPPORT FOR ALL EXISTING UTILITY LINES UNCOVERED IN THE TRENCHES.
- 8. PRIOR TO COMMENCING EXCAVATION, THE CONTRACTOR SHALL NOTIFY THE ENGINEER. THE CONTRACTOR SHALL COORDINATE, BE HELD RESPONSIBLE AND SHALL PAY FOR ALL DAMAGE TO EXISTING UTILITIES AND STRUCTURES. PERSONAL INJURY RESULTING FROM CONTACT WITH THE EXISTING UTILITIES SHALL BE THE CONTRACTOR'S RESPONSIBILITY.
- 9. UTILITIES SHALL REMAIN IN-SERVICE AND IN PLACE UNLESS NOTED OTHERWISE. INTERRUPTION OF SERVICE SHALL BE KEPT TO A MINIMUM AND SHALL BE DONE AT THE CONTRACTOR'S EXPENSE AND ONLY WITH THE APPROVAL OF THE ENGINEER.
- THE CONTRACTOR SHALL BE RESPONSIBLE FOR PROPERLY SHEETING AND BRACING THE EXCAVATION AND STABILIZING THE EXISTING GROUND TO RENDER IT SAFE AND SECURE FROM POSSIBLE SLIDES, CAVE-INS AND SETTLEMENT AND FOR PROPERLY SUPPORTING EXISTING STRUCTURES AND FACILITIES WITH BEAMS, STRUTS OR UNDERPINNING TO FULLY PROTECT THEM FROM DAMAGE. THE CONTRACTOR SHALL PROVIDE AN EXCAVATION SHORING PLAN PREPARED AND STAMPED BY A LICENSED PROFESSIONAL ENGINEER COMPETENT IN STRUCTURAL ENGINEERING AND A LICENSED CIVIL ENGINEER COMPETENT IN GEOTECHNICAL ENGINEERING.
- 11. THE CONTRACTOR SHALL PROVIDE SAFE ACCESS TO AND FROM ALL PARKING LOTS, SIDEWALKS, DRIVEWAYS, AND STREETS.
- 12. THE CONTRACTOR SHALL RESTORE TO THEIR ORIGINAL CONDITION ALL IMPROVEMENTS DAMAGED AS A RESULT OF THE CONSTRUCTION, INCLUDING PAVEMENTS, EMBANKMENTS, CURBS, SIGNS, LANDSCAPING, STRUCTURES, UTILITIES, WALLS, FENCES, ETC.
- 13. THE CONTRACTOR SHALL ENSURE THAT THE SEWER LINES AND DRAIN LINES ARE FREE OF DEBRIS OR OTHER OBSTRUCTIONS PRIOR TO MAKING ANY ON-LINE FLOW CONNECTION.
- 14. FINISHED GRADE INDICATED IS INCLUSIVE OF TOPSOIL.
- 15. HYDROSEED ALL CUT AND FILL SLOPES 3 HORIZONTAL TO 1 VERTICAL (AND GREATER) AS AN EROSION CONTROL MEASURE.
- 16. THE CONTRACTOR SHALL EXPOSE ALL UTILITY CROSSINGS TO VERIFY THE EXISTING UTILITY LOCATION, SIZE, ELEVATION, AND DIMENSIONS.
- 17. WHEN WORK ON EXISTING SEWER LINES AND MANHOLES IS REQUIRED, THE CONTRACTOR SHALL PROVIDE EQUIPMENT NECESSARY TO REDIRECT. SEWAGE AROUND THESE SEWER LINES AND MANHOLES.
- 18. THE CONTRACTOR SHALL PLAN OPERATIONS TO MINIMIZE THE AMOUNT OF EXCAVATED TRENCHES LEFT WITHOUT BACKFILL AT THE END OF EACH WORK DAY WITH THE TOTAL LENGTH OF TRENCHES WITHOUT BACKFILL NOT TO EXCEED 300 FEET. TRENCHES WITHOUT BACKFILL SHALL BE COVERED BY NONSKID STEEL PLATES CAPABLE OF CARRYING H-20 VEHICLES IN TRAFFIC AREAS AND 100 LBS/SF IN NONTRAFFIC AREAS. PROVIDE ANCHORING OF THE PLATES IN NONTRAFFIC AREAS. PROVIDE FLASHING BARRICADES TO DELINEATE COVERED TRENCHES IN NONTRAFFIC AREAS AND ALL STOCK/SPOIL PILES.
- 19. IN PAVED AREAS, THE TOP OF MANHOLES SHALL MATCH THE FINISHED PAVEMENT GRADE.
- 20. ALL GRADING WORK SHALL CONFORM TO THE REQUIREMENTS OF THE "PRELIMINARY RECOMMENDATIONS FOR KALAELOA RENTAL HOMES MEMORANDUM, DATED MARCH 20, 2017, PREPARED BY GEOLABS, INC."

TRAFFIC NOTES:

- 1. THE CONTRACTOR SHALL PROVIDE, INSTALL AND MAINTAIN ALL NECESSARY SIGNS AND OTHER PROTECTIVE FACILITIES, WHICH SHALL CONFORM TO THE "HAWAII ADMINISTRATION RULES GOVERNING THE USE OF TRAFFIC CONTROL DEVICES AT WORK SITE ON OR ADJACENT TO PUBLIC STREETS AND HIGHWAYS" ADOPTED BY THE DIRECTOR OF TRANSPORTATION, AND THE CURRENT U.S. FEDERAL HIGHWAY ADMINISTRATION'S "MANUAL ON UNIFORM TRAFFIC CONTROL DEVICES FOR STREETS AND HIGHWAYS, PART VI TRAFFIC CONTROLS FOR STREET AND HIGHWAY CONSTRUCTION AND MAINTENANCE OPERATIONS."
- DURING WORKING HOURS, THE CONTRACTOR SHALL PROVIDE FOR THROUGH TRAFFIC.
 DURING NON-WORKING HOURS, ALL TRENCHES SHALL BE COVERED WITH A SAFE NON-SKID BRIDGING MATERIAL AND ALL LANES SHALL BE OPEN TO TRAFFIC.
- WHERE PEDESTRIAN WALKWAYS EXIST, THEY SHALL BE MAINTAINED IN PASSABLE CONDITION
 OR OTHER FACILITIES SHALL BE PROVIDED. PASSAGE BETWEEN WALKWAYS AT
 INTERSECTIONS SHALL LIKEWISE BE PROVIDED.
- 4. DRIVEWAYS SHALL BE KEPT OPEN UNLESS THE OWNERS OF THE PROPERTY USING THESE RIGHTS-OF-WAY ARE OTHERWISE PROVIDED FOR SATISFACTORILY.

EROSION/TEMPORARY DUST CONTROL NOTES

- 1. DRAINAGE SYSTEMS AS SHOWN ON THE CONSTRUCTION PLANS SHALL BE CONSTRUCTED AS EARLY AS PRACTICALLY POSSIBLE.
- 2. ALL FILL, SUBBASE AND BASE MATERIAL PLACED WITHIN THE ROAD PAVEMENT PRISM SHALL BE SUBSTANTIALLY COMPACTED BY THE END OF THE DAY.
- 3. THE CONTRACTOR SHALL CONDUCT HIS GRADING OPERATIONS SO THAT EXCAVATION, EMBANKMENT AND IMPORTED MATERIAL SHALL BE DAMPENED WITH WATER DURING HIS GRADING OPERATIONS AT ALL TIMES.
- 4. WATER TRUCK AND/OR TEMPORARY SPRINKLERS SHALL BE AVAILABLE ON THE JOB SITE AT ALL TIMES TO ENSURE BARE EARTH DOES NOT CREATE A DUST PROBLEM.
- 5. FUGITIVE DUST AND SOLID WASTE DISPOSAL DURING GRUBBING AND GRADING ACTIVITIES SHALL MEET REQUIREMENTS OF ADMINISTRATIVE RULES, TITLE 11, CHAPTER 60, AIR POLLUTION CONTROL, AND CHAPTER 58, SOLID WASTE MANAGEMENT CONTROL.

PUBLIC HEALTH, SAFETY AND

CONVENIENCE NOTES

- 1. THE CONTRACTOR SHALL OBSERVE AND COMPLY WITH ALL FEDERAL, STATE, AND LOCAL LAWS REQUIRED FOR THE PROTECTION OF THE PUBLIC HEALTH AND SAFETY AND ENVIRONMENTAL QUALITY.
- 2. THE CONTRACTOR, AT HIS OWN EXPENSE SHALL KEEP THE PROJECT AND ITS SURROUNDING AREAS FREE FROM DUST NUISANCE. THE WORK SHALL BE IN CONFORMANCE WITH THE AIR POLLUTION CONTROL STANDARDS AND REGULATIONS OF THE STATE DEPARTMENT OF HEALTH. THE CITY MAY REQUIRE SUPPLEMENTARY MEASURES AS NECESSARY.
- 3. NO CONTRACTOR SHALL PERFORM ANY CONSTRUCTION ACTIVITY SO AS TO CAUSE FALLING ROCK, SOIL OR DEBRIS IN ANY FORM TO FALL, SLIDE OR FLOW ONTO ADJOINING PROPERTIES, STREETS OR NATURAL WATERCOURSES. SHOULD SUCH VIOLATIONS OCCUR, THE CONTRACTOR SHALL IMMEDIATELY MAKE ALL REMEDIAL ACTIONS NECESSARY.
- I. THE CONTRACTOR SHALL PROVIDE, INSTALL AND MAINTAIN ALL NECESSARY SIGNS, LIGHTS, FLARES, BARRICADES, MARKERS, CONES AND OTHER PROTECTIVE FACILITIES AND SHALL TAKE ALL NECESSARY PRECAUTIONS FOR THE PROTECTION, CONVENIENCE AND SAFETY OF THE PUBLIC.

EROSION CONTROL AND BEST MANAGEMENT PRACTICE (BMP) NOTES:

- MEASURES TO CONTROL EROSION AND OTHER POLLUTANTS SHALL BE IN PLACE BEFORE ANY DEMOLITION OR EARTH MOVING WORK IS INITIATED. THESE MEASURES SHALL BE PROPERLY CONSTRUCTED AND MAINTAINED THROUGHOUT THE CONSTRUCTION PERIOD.
- 2. INSTALL PERIMETER PROTECTION (COMPOST FILTER SOCK) AS SHOWN ON THE EROSION CONTROL PLAN. PERIMETER PROTECTION MAY BE ADJUSTED TO FIT THE CONTRACTOR'S OPERATIONS.
- 3. CONSTRUCT TEMPORARY STABILIZED CONSTRUCTION ENTRANCE/EXIT AT LOCATION SHOWN ON THE EROSION CONTROL PLAN. ALL VEHICLES EXITING THE SITE ARE TO BE SUFFICIENTLY CLEANED OFF SO THAT DIRT OR DEBRIS IS NOT TRACKED OFF THE CONSTRUCTION SITE. CONSTRUCTION ENTRANCE/EXIT MAY BE ADJUSTED TO FIT THE CONTRACTOR'S OPERATIONS.
- 4. LOCATE STOCKPILES, INCLUDING WASTE AND SOIL, AWAY FROM CONCENTRATED DRAINAGE FLOWS, DRAINAGE SWALES AND INLETS. INSTALL PERIMETER PROTECTION (SILT FENCE, FIBER ROLLS, COMPOST FILTER SOCK, OR SNAKE BAG), BERMS OR TRENCHES AROUND ERODIBLE MATERIAL STOCKPILES.
- 5. ALL EROSION CONTROL MEASURES SHALL BE CHECKED AND REPAIRED AS NECESSARY, FOR EXAMPLE, WEEKLY IN DRY PERIODS AND WITHIN 24-HOURS AFTER ANY RAINFALL OF 0.5 INCHES OR GREATER WITHIN A 24-HOUR PERIOD. DURING PROLONGED RAINFALL, DAILY CHECKING IS NECESSARY. THE CONTRACTOR SHALL MAINTAIN RECORDS OF CHECKS AND REPAIRS.
- 6. IF HEAVY RAINS ARE PREDICTED DURING A WORKDAY, ALL CONTROL MEASURES WILL BE INSPECTED IMMEDIATELY AND REINFORCED AS NECESSARY.
- 7. CONTRACTOR SHALL REMOVE SEDIMENT FILTERS DURING ABOVE-NORMAL RAINFALL EVENTS AND REPLACE FILTER AFTER THE EVENT HAS PASSED.
- 8. CLEARING, GRUBBING AND GRADING SHALL BE HELD TO THE MINIMUM NECESSARY. GRADING AND
- 9. THE FINAL LIFT OF EACH DAY'S WORK SHALL BE COMPACTED TO PREVENT EROSION OF FILL MATERIAL.

GRUBBING SHALL BE SEQUENCED TO MINIMIZE THE EXPOSURE TIME OF THE CLEARED SURFACE AREA.

- 10. DUST CONTROL WITH WATER SPRAY (BY TRUCK OR TEMPORARY SPRINKLERS) SHALL BE APPLIED AS NEEDED. DO NOT OVERWATER.
- 11. A SPECIFIC INDIVIDUAL SHALL BE DESIGNATED TO BE RESPONSIBLE FOR EROSION AND SEDIMENT CONTROLS ON THE PROJECT SITE.
- 12. GOOD HOUSE KEEPING BEST MANAGEMENT PRACTICES:
- A. MATERIAL MANAGEMENT PRACTICES SHALL BE USED TO REDUCE THE RISK OF SPILLS OR OTHER ACCIDENTAL EXPOSURE OF MATERIALS AND SUBSTANCES TO STORM WATER RUNOFF. AN EFFORT SHALL BE MADE TO STORE ONLY ENOUGH PRODUCT AS IS REQUIRED TO DO THE JOB.
- B. ALL MATERIALS STORED ONSITE SHALL BE STORED IN A NEAT, ORDERLY MANNER IN THEIR APPROPRIATE CONTAINERS AND IF POSSIBLE, UNDER COVER OR IN AN ENCLOSURE.
- C. PRODUCTS SHALL BE KEPT IN THEIR ORIGINAL CONTAINERS WITH THE ORIGINAL MANUFACTURER'S LABEL.
- D. SUBSTANCES SHALL NOT BE MIXED WITH ONE ANOTHER UNLESS RECOMMENDED BY THE MANUFACTURER.
- E. WHENEVER POSSIBLE, THE ENTIRE CONTAINER CONTENTS WILL BE USED UP PRIOR TO DISPOSAL OF THE CONTAINER.
- F. MANUFACTURER'S RECOMMENDATION FOR PROPER USE AND DISPOSAL SHALL BE FOLLOWED.
- G. ALL HAZARDOUS MATERIALS, FUEL, OIL AND CHEMICAL SPILLS SHALL BE STOPPED AND CLEANED UP WITH PROPER ABSORBENT MATERIALS. ABSORBENT MATERIAL SPILL KITS SHALL BE MAINTAINED ON-SITE.
- H. THE CONTRACTOR SHALL CONDUCT A DAILY INSPECTION TO ENSURE PROPER USE AND DISPOSAL OF MATERIALS ONSITE.
- CONCRETE TRUCK CHUTE WASH WATER WILL BE DISCHARGED TO A DESIGNATED AREA WHERE COMMINGLING WITH STORM WATER WILL BE PREVENTED BY LOCATING OUTSIDE OF DRAINAGEWAYS, CUT-OFF DITCH OR PERIMETER BERM. WATER SHALL NOT BE DISCHARGED INTO DRAINAGE SYSTEMS OR WATERS OF THE UNITED STATES. THE CONTRACTOR SHALL CLEAN THE DISPOSAL SITE AS REQUIRED.
- 14. SANITARY AND SEPTIC WASTES SHALL BE COLLECTED FROM ON-SITE FACILITIES ON A REGULAR BASIS BY A LICENSED HAULER. SANITARY AND SEPTIC FACILITIES SHALL NOT BE LOCATED IN OR NEAR WATERCOURSES.
- 15. VEHICLE AND EQUIPMENT MAINTENANCE AND FUELING SHALL BE DONE OFF-SITE (WHERE AT ALL
- 16. THE CONTRACTOR AND SUBCONTRACTORS SHALL BE TRAINED ON THE BEST MANAGEMENT PRACTICES.

 17. PERIMETER PROTECTION (COMPOST EILTER SOCK) SHALL BE CLEARED OF SILT IMMEDIATELY.
- 17. PERIMETER PROTECTION (COMPOST FILTER SOCK,) SHALL BE CLEARED OF SILT IMMEDIATELY FOLLOWING THE END OF ANY RAINFALL THAT CAUSES SILT BUILDUP OR WHEN DEPTH REACHES 1/3 OF PERIMETER PROTECTION HEIGHT.
- 18. STABILIZATION SHALL BE ACCOMPLISHED BY PROTECTING THE DISTURBED SOIL SURFACE FROM RAINFALL IMPACTS AND RUNOFF WITH PLANTING, PAVING ON CONCRETE. FOR STABILIZATION WITH PLANTING, IRRIGATION SHALL BE INSTALLED TO FACILITATE GROWTH. DO NOT OVERWATER.
- 19. FERTILIZER AND PESTICIDE APPLICATION SHALL NOT OCCUR IF HEAVY RAINS ARE ANTICIPATED DURING THE WORKDAY, OR DURING HEAVY RAINS.
- 20. EROSION CONTROL AND BMPS ARE THE MINIMUM REQUIREMENTS FOR THE PROJECT. CONTRACTOR MAY INSTALL AND IMPLEMENT NEW/BETTER PRODUCTS TO CONTROL AND PREVENT EROSION AND POLLUTANTS FROM THE SITE. CONTRACTOR CHANGES TO BMPS SHALL BE SUBMITTED TO THE CITY FOR APPROVAL
- 21. STOCKPILING OF MATERIALS WITHIN ROADWAY PAVEMENT IS NOT PERMITTED.
- 22. INSTALL INLET PROTECT AT NEW DRAIN INLETS AFTER CONSTRUCTED.

GRADING NOTES

- 1. ALL GRADING WORK SHALL BE DONE IN ACCORDANCE WITH CHAPTER 14, ARTICLES 13, 14, 15 AND 16, AS RELATED TO GRADING, SOIL EROSION AND SEDIMENT CONTROL OF THE REVISED ORDINANCES OF HONOLULU, 1990, AS AMENDED.
- NO CONTRACTOR SHALL PERFORM ANY GRADING OPERATION SO AS TO CAUSE FALLING ROCKS, SOIL OR DEBRIS IN ANY FORM TO FALL, SLIDE OR FLOW ONTO ADJOINING PROPERTIES, STREETS OR NATURAL WATERCOURSES. SHOULD SUCH VIOLATIONS OCCUR, THE CONTRACTOR MAY BE CITED AND THE CONTRACTOR SHALL IMMEDIATELY MAKE ALL REMEDIAL ACTIONS NECESSARY.
- 3. THE CONTRACTOR, AT HIS OWN EXPENSE, SHALL KEEP THE PROJECT AREA AND SURROUNDING AREA FREE FROM DUST NUISANCE. THE WORK SHALL BE IN CONFORMANCE WITH THE AIR POLLUTION CONTROL STANDARDS CONTAINED IN THE HAWAII ADMINISTRATIVE RULES, TITLE 11, CHAPTER 60.1, "AIR POLLUTION CONTROL".
- 4. THE UNDERGROUND PIPES, CABLES OR DUCTLINES KNOWN TO EXIST BY THE ENGINEER FROM HIS SEARCH OF RECORDS ARE INDICATED ON THE PLANS. THE CONTRACTOR SHALL VERIFY THE LOCATIONS AND DEPTHS OF THE FACILITIES AND EXERCISE PROPER CARE IN EXCAVATING IN THE AREA. WHEREVER CONNECTIONS OF NEW UTILITIES ARE SHOWN ON THE PLANS, THE CONTRACTOR SHALL EXPOSE THE EXISTING LINES AT THE PROPOSED CONNECTIONS TO VERIFY THEIR LOCATIONS AND DEPTHS PRIOR TO EXCAVATION FOR THE NEW LINES.
- 5. ADEQUATE PROVISIONS SHALL BE MADE TO PREVENT SURFACE WATERS FROM DAMAGING THE CUT FACE OF AN EXCAVATION OR THE SLOPED SURFACES OF A FILL. FURTHERMORE, ADEQUATE PROVISIONS SHALL BE MADE TO PREVENT SEDIMENT-LADEN RUNOFF FROM LEAVING THE SITE.
- 6. ALL SLOPES AND EXPOSED AREAS SHALL BE STABILIZED USING SODDING, PLANTING, GRAVEL, GEOTEXTILE FABRICS, OR COMPOST BLANKETS AS SOON AS FINAL GRADES HAVE BEEN ESTABLISHED. PLANTING SHALL NOT BE DELAYED UNTIL ALL GRADING WORK HAS BEEN COMPLETED. GRADING TO FINAL GRADE SHALL BE COMPUSED, AND ANY AREA WITHIN WHICH WORK HAS BEEN INTERRUPTED OR DELAYED SHALL BE PLANTED.
- 7. FILLS ON SLOPES STEEPER THAN 5:1 SHALL BE KEYED.
- 8. THE CITY SHALL BE INFORMED OF THE LOCATION OF THE BORROW/DISPOSAL SITE FOR THE PROJECT WHEN THE APPLICATION FOR A GRADING PERMIT IS MADE. THE BORROW/DISPOSAL SITE MUST ALSO FULFILL THE REQUIREMENTS OF THE GRADING ORDINANCE.
- 9. NO GRADING WORK SHALL BE DONE ON SATURDAYS, SUNDAYS AND HOLIDAYS AT ANY TIME WITHOUT PRIOR NOTICE TO THE DIRECTOR, D.P.P., PROVIDED SUCH GRADING WORK IS ALSO IN CONFORMANCE WITH THE COMMUNITY NOISE CONTROL STANDARDS CONTAINED IN THE HAWAII ADMINISTRATIVE RULES, TITLE 11. CHAPTER 46, "COMMUNITY NOISE CONTROL".
- 10. THE LIMITS OF THE AREA TO BE GRADED SHALL BE FLAGGED BEFORE THE COMMENCEMENT OF THE GRADING WORK.
- 11. THE GENERAL CONTRACTOR/DEVELOPER/OWNER OF THE PROJECT SHALL BE RESPONSIBLE FOR ALL GRADING OPERATIONS TO BE PERFORMED IN CONFORMANCE WITH APPLICABLE PROVISIONS OF THE HAWAII ADMINISTRATIVE RULES, TITLE 11, CHAPTER 54, "WATER QUALITY STANDARDS," AND TITLE 11, CHAPTER 55, "WATER POLLUTION CONTROL", AS WELL AS CHAPTER 14 OF THE REVISED ORDINANCES OF HONOLULU, AS AMENDED. BEST MANAGEMENT PRACTICES SHALL BE EMPLOYED AT ALL TIMES DURING CONSTRUCTION.

THE GENERAL CONTRACTOR/DEVELOPER/OWNER OF THE PROJECT SHALL OBTAIN NATIONAL POLLUTANT DISCHARGE ELIMINATION SYSTEM (NPDES) PERMIT COVERAGE(S) FOR THE FOLLOWING:

- I. STORM WATER DISCHARGES ASSOCIATED WITH CONSTRUCTION ACTIVITIES THAT DISTURB ONE (1) ACRE OR MORE, AND
- II. DISCHARGES OF HYDROTESTING EFFLUENT, DEWATERING EFFLUENT, AND WELL DRILLING EFFLUENT TO STATE WATERS.

IN ACCORDANCE WITH STATE LAW, ALL DISCHARGES RELATED TO PROJECT CONSTRUCTION OR OPERATIONS ARE REQUIRED TO COMPLY WITH STATE WATER QUALITY STANDARDS (HAWAII ADMINISTRATIVE RULES, CHAPTER 11-54). BEST MANAGEMENT PRACTICES SHALL BE USED TO MINIMIZE OR PREVENT THE DISCHARGE OF SEDIMENT, DEBRIS, AND OTHER POLLUTANTS TO STATE WATERS. PERMIT COVERAGE IS AVAILABLE FROM THE DEPARTMENT OF HEALTH, CLEAN WATER BRANCH AT http://health.hawaii.gov/cwb. THE OWNER/DEVELOPER/CONTRACTOR IS RESPONSIBLE FOR OBTAINING OTHER FEDERAL, STATE, OR LOCAL AUTHORIZATIONS AS REQUIRED BY LAW.

- 12. WHERE APPLICABLE AND FEASIBLE THE MEASURES TO CONTROL EROSION AND OTHER POLLUTANTS SHALL BE IN PLACE BEFORE ANY EARTH MOVING PHASE OF THE GRADING IS INITIATED.
- 13. TEMPORARY EROSION CONTROLS SHALL NOT BE REMOVED BEFORE PERMANENT EROSION CONTROLS ARE IN-PLACE AND ESTABLISHED.
- 14. TEMPORARY EROSION CONTROL PROCEDURES SHALL BE SUBMITTED FOR APPROVAL PRIOR TO APPLICATION FOR GRADING PERMIT.
- 15. IF THE GRADING WORK INVOLVES CONTAMINATED SOIL, THEN ALL GRADING WORK SHALL BE DONE IN CONFORMANCE WITH APPLICABLE STATE AND FEDERAL REQUIREMENTS.
- 16. FOR NON-CITY PROJECTS, THE CONTRACTOR SHALL NOTIFY THE CIVIL ENGINEERING BRANCH, D.P.P. AT 768-8084 TO ARRANGE FOR INSPECTIONAL SERVICES AND SUBMIT TWO (2) SETS OF APPROVED CONSTRUCTION PLANS SEVEN (7) DAYS PRIOR TO COMMENCEMENT OF CONSTRUCTION WORK. FOR CITY PROJECTS, THE CONTRACTOR SHALL COORDINATE INSPECTIONAL SERVICES WITH THE RESPONSIBLE CITY
- 17. PURSUANT TO CHAPTER 6E, HRS, IN THE EVENT ANY ARTIFACTS OR HUMAN REMAINS ARE UNCOVERED DURING CONSTRUCTION OPERATIONS, THE CONTRACTOR SHALL IMMEDIATELY SUSPEND WORK AND NOTIFY THE HONOLULU POLICE DEPARTMENT, THE STATE DEPARTMENT OF LAND AND NATURAL RESOURCES-HISTORIC PRESERVATION DIVISION (692-8015). IN ADDITION, FOR NON-CITY PROJECTS, THE CONTRACTOR SHALL INFORM THE CIVIL ENGINEERING BRANCH, D.P.P. (768-8084); AND FOR CITY PROJECTS, NOTIFY THE RESPONSIBLE CITY AGENCY.
- 18. FOR ALL PROJECTS, WHICH WILL DISTURB ONE (1) ACRE OR MORE OF LAND, THE CONTRACTOR SHALL NOT START CONSTRUCTION UNTIL A NOTICE OF GENERAL PERMIT COVERAGE (NGPC) IS RECEIVED FROM THE DEPARTMENT OF HEALTH, STATE OF HAWAII, AND HAS SATISFIED ANY OTHER APPLICABLE REQUIREMENTS OF THE NPDES PERMIT PROGRAM. ALSO, FOR NON-CITY AND OTHER NON-GOVERNMENTAL AGENCY PROJECTS, THE CONTRACTOR SHALL PROVIDE A WRITTEN COPY OF THE NGPC TO THE PERMITTING AND INSPECTION SECTION, CIVIL ENGINEERING BRANCH, D.P.P., AT LEAST SEVEN (7) CALENDAR DAYS BEFORE THE START OF THE CONSTRUCTION. FOR CITY OR OTHER GOVERNMENTAL PROJECTS, THE CONTRACTOR SHOULD PROVIDE A WRITTEN COPY OF THE NGPC TO THE APPROPRIATE CITY DEPARTMENT OR GOVERNMENTAL AGENCY PER THEIR REQUIREMENTS.
- 19. ALL GRADING AND CONSTRUCTION WORK SHALL IMPLEMENT MEASURES TO ENSURE THAT THE DISCHARGE OF POLLUTANTS FROM THE CONSTRUCTION SITE WILL BE REDUCED TO THE MAXIMUM EXTENT PRACTICABLE AND WILL NOT CAUSE OR CONTRIBUTE TO AN EXCEEDANCE OF WATER QUALITY STANDARDS.
- 20. NON-COMPLIANCE TO ANY OF THE ABOVE REQUIREMENTS SHALL MEAN IMMEDIATE SUSPENSION OF ALL WORK, AND REMEDIAL WORK SHALL COMMENCE IMMEDIATELY. ALL COSTS INCURRED SHALL BE BILLED TO THE VIOLATOR. FURTHERMORE, VIOLATORS SHALL BE SUBJECTED TO ADMINISTRATIVE, CIVIL AND/OR CRIMINAL PENALTIES.
- 21. FOR BENCHMARK SEE SHEET C-3.



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Revisions

ADDED GRADING NOTES, REVISED NOTES

CITY COMMENTS

OF THE LICENSE

Sheet

CONSTRUCTION NOTES

Project No.
2015.33.0601
Designed by:
CKK
Drawn by:
BHK
Date:
MAY 2017

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UTILITY NOTES:

- CONSTRUCTION SHALL CONFORM TO THE NAVFAC HAWAII UTILITY STANDARD CONTAINED IN THE NAVAL FACILITIES ENGINEERING COMMAND, HAWAII PUBLIC WORKS UTILITIES CRITERIA FOR DESIGN AND CONSTRUCTION: ELECTRICAL, SEWER AND WATER.
- THE EXISTENCE AND LOCATION OF UNDERGROUND UTILITIES. APPURTENANCES AND STRUCTURES SHOWN ARE BASED ON THE TOPOGRAPHIC SURVEY INDICATED AND APPLICABLE UTILITY MAPS, VERIFIED WHENEVER POSSIBLE BY FIELD SURVEYS. THE CONTRACTOR SHALL VERIFY THE LOCATION, SIZE AND INVERTS OF ALL EXISTING UTILITIES (BY TONING & STAKING PRIOR TO EXCAVATION) AND SHALL PROTECT ALL SUCH UTILITIES AT ALL TIMES, EXISTING UTILITIES WHETHER SHOWN OR NOT, WHICH HAVE BEEN DAMAGED AS A RESULT OF THE CONSTRUCTION WORK, SHALL BE RESTORED IMMEDIATELY TO ITS ORIGINAL OR BETTER CONDITION AT THE CONTRACTOR'S EXPENSE.
- WHENEVER NEW UTILITIES CONNECT TO OR CROSS EXISTING UTILITIES, THE CONTRACTOR SHALL CAREFULLY EXPOSE THE UTILITY BY HAND EXCAVATION TO VERIFY THEIR LOCATIONS AND DEPTHS PRIOR TO EXCAVATING TRENCHES FOR THE NEW UTILITY
- THE CONTRACTOR SHALL SCHEDULE HIS WORK TO MINIMIZE UTILITY OUTAGES. THE CONTRACTOR SHALL NOTIFY THE ENGINEER IN WRITING 30 DAYS PRIOR TO ANY OUTAGES. THE CONTRACTOR SHALL ALSO COORDINATE ALL UTILITY OUTAGES WITH NAVFAC AND NATIONAL PARK SERVICE (NPS), AND GIVE NAVFAC AND NPS ADEQUATE ADVANCE NOTICE PRIOR TO ALL OUTAGES. THE CONTRACTOR SHALL COORDINATE WATER OUTAGES WITH THE FIRE DEPARTMENT.
- UTILITY PROFILES SHALL BE USED TO DETERMINE WATER AND SEWER LINE ELEVATIONS. ANY EXISTING UTILITY LINES OR LINES NOT SHOWN ON THE UTILITY PROFILES THAT PROHIBITS THE INSTALLATION OF THESE LINES AS INDICATED SHALL BE BROUGHT TO THE ATTENTION OF ENGINEER FOR RESOLUTION. ALL NEW ELECTRICAL/COMMUNICATION LINES/MECHANICAL LINES SHALL BE ADJUSTED ABOVE OR BELOW THE NEW WATER/SEWER LINE PROFILE PROVIDED ALL REQUIREMENTS SHOWN ON TRENCH RESTORATION DETAILS AND ALL ELECTRICAL, COMMUNICATION AND MECHANICAL UTILITY REQUIREMENTS ARE MET AND SHALL BE DONE AT NO ADDITIONAL COST TO THE OWNER OR GOVERNMENT.
- ALL PIPE CONNECTIONS TO EXISTING MANHOLES SHALL BE DONE BY CAREFULLY CHIPPING & REMOVING SUFFICIENT AREA FOR PIPE CONNECTION. BEND REBARS MIN 2 INCHES AWAY FROM PIPE CONNECTION. GROUT WITH 3650 PSI MORTAR. PROVIDE SMOOTH FINISH.
- THE CONTRACTOR SHALL SAWCUT & REMOVE EXISTING UTILITY LINES AS INDICATED ON DEMOLITION PLANS. CONTRACTOR SHALL ENSURE ALL LINES TO REMAIN (THOSE NOT INDICATED TO BE REMOVED) SHALL BE CAPPED OR PLUGGED TO ENSURE CONTINUATION OF SERVICE. REMOVED SEWER LINES CONNECTED TO EXISTING SEWER MANHOLES SHALL BE PLUGGED AT THE SMH AFTER SEWER LINE IS REMOVED. ALL ABANDONED UTILITIES SHALL BE REMOVED.

WATER NOTES (NAVY)

- 1. THE NAVFAC HAWAII WATER UTILITIES BRANCH (CODE OPC61, PHONE NO. 473-0037) SHALL BE INFORMED 60 DAYS IN ADVANCE OF ANY WORK ON THE NAVY'S WATER LINE.
- 2. THE CONTRACTOR SHALL NOTIFY THE NAVFAC HAWAII WATER UTILITIES BRANCH IN WRITING ANY REQUEST FOR WATER OUTAGE AT LEAST 30 CALENDAR DAYS PRIOR TO THE PLANNED OUTAGE. SUCH REQUEST SHALL BE SUBJECT TO THE APPROVAL OF THE NAVY. THE CONTRACTOR SHALL ALSO NOTIFY THE NAVFAC HAWAII WATER UTILITIES BRANCH (CODE 652, PHONE 473-0037) 3 DAYS IN ADVANCE OF CONNECTIONS INTO THE EXISTING WATER SYSTEM AND PRIOR TO PERFORMING ANY TESTS ON THE NEW NAVY LINE.
- WATER OUTAGES SHALL BE LIMITED TO A 1-DAY DURATION. CONTRACTOR SHALL ENSURE ADEQUATE THRUST RESTRAINT AT FITTINGS THROUGH USE OF STRUCTURAL STRUTS, SATISFACTORILY CURED CONCRETE THRUST BLOCKS, OR OTHER MEANS PRIOR TO RESUMING SERVICE. CONTRACTOR SHALL HAVE ALL MATERIALS ON HAND FOR THE CONNECTION PRIOR TO THE OUTAGE PERIOD.
- OUTAGES ON AND TAPS TO THE EXISTING NAVY LINE WILL NOT BE GRANTED UNTIL THE NEW LINE HAS BEEN CONSTRUCTED, TESTED, AND DISINFECTED, WITH LETTER REQUEST FOR SHUT-DOWN PROVIDED IN ADVANCE TO NAVFAC HAWAII WATER UTILITIES BRANCH (CODE PW652, PHONE NO. 473-0037). BOTH DISINFECTION AND HYDROTEST RESULTS SHALL BE SUBMITTED TO NAVFAC HAWAII WATER UTILITIES AT LEAST 24 HOURS IN ADVANCE OF THE TAP OR TIE-IN TO THE EXISTING NAVY WATER SYSTEM.
- 5. OUTAGES AND TAPS ON THE EXISTING NAVY WATER SYSTEM WILL BE DONE ONLY BY NAVY PW652 PERSONNEL. THE WORK WILL BE DONE ON A COST REIMBURSABLE BASIS. THE GENERAL CONTRACTOR WILL SET UP AN ACCOUNT WITH THE NAVFAC HI COMPTROLLER'S OFFICE (PHONE 471-1587).
- 6. THE CONTRACTOR SHALL TONE TO DETERMINE THE EXACT LOCATION OF THE NAVY LINE PRIOR TO PERFORMING EXCAVATION WORK IN THE AREA.
- ALL NAVY VALVE BOX FRAMES AND COVERS SHALL BE PAINTED YELLOW.
- 8. PROVIDE VALVE ID TAG SIMILAR TO BWS DETAILS V17 FOR ALL VALVES INSTALLED.
- 9. THE CONTRACTOR SHALL MEASURE THE OUTSIDE DIAMETER OF THE EXISTING NAVY LINE AT BOTH CONNECTION POINTS BEFORE ORDERING THE CONNECTION PIECES.
- 10. ALL GATE VALVES SHALL CONFORM TO AWWA C-509 AND BE EPOXY COATED ON THE INTERIOR AND EXTERIOR. INTERIOR COATING SHALL BE SUITABLE FOR POTABLE WATER USAGE.
- 11. TEST PRESSURE SHALL BE 200 PSI FOR 2 HOUR DURATION.
- 12. CHLORINATION SHALL BE BY THE CONTINUOUS FEED METHOD, PER AWAA C651, AS AMENDED.
- 13. RECORD DRAWINGS OF WATER LINE SHALL BE PROVIDED TO NAVFAC HAWAII; ONE COPY TO CODE CI41 (PHONE NO. 474-2253), AND ONE (1) COPY TO CODE PW652 (PHONE NO. 473-0037).
- 14. DISINFECTION OF WATER LINES, INCLUDING FLUSHING AND BACTERIOLOGICAL TESTING, SHALL BE IN ACCORDANCE WITH AWWA C651 (LATEST EDITION) EXCEPT AS OTHERWISE INDICATED BELOW.
- A. ALL CONNECTIONS TO EXISTING WATER LINES SHALL BE DONE IN THE "DRY". WHEN THE EXISTING WATER LINE HAS TO BE DEWATERED, THE CONTRACTOR SHALL ACCOMPLISH THE DEWATERING OF THE LINE IN A MANNER SUCH THAT THE CONNECTION TO THE EXISTING SYSTEM CAN BE DONE IN THE "DRY". THE CONTRACTOR SHALL SUBMIT A DEWATERING PLAN FOR APPROVAL.
- B. FOR NEW PIPE SECTIONS, CHLORINE SHALL BE APPLIED BY THE CONTINUOUS FEED METHOD UNLESS PRIOR APPROVAL HAS BEEN OBTAINED TO USE A DIFFERENT METHOD.
- 1) CALCIUM HYPOCHLORITE GRANULES SHALL BE PLACED IN NEW PIPE SECTIONS (EXCEPT SOLVENT-WELDED PLASTIC AND SCREWED JOINT STEEL PIPE) DURING CONSTRUCTION AS SPECIFIED IN AWWA C651
- 2) WHEN THE LINE IS CHLORINATED. WATER ENTERING THE LINE SHALL RECEIVE A DOSE OF CHLORINE FED AT A CONSTANT RATE SUCH THAT THE WATER WILL HAVE NOT LESS THAN 50 MG/I OF FREE CHLORINE.
- 3) AT THE END OF A 24-HOUR PERIOD THE TREATED WATER SHALL HAVE A RESIDUAL OF NOT LESS THAN 25 MG/I FREE CHLORINE.
- 4) DURING THE CHLORINATION PERIOD ALL VALVES AND HYDRANTS IN THE SECTION BEING TREATED SHALL BE OPERATED A SUFFICIENT NUMBER OF TIMES TO THOROUGHLY DISINFECT THE APPURTENANCES.
- C. DISINFECTION PROCEDURES FOR REPAIRS/CONNECTION WORK SHALL BE AS INDICATED IN AWWA C651 UNDER THE PARAGRAPH TITLED "DISINFECTION PROCEDURES WHEN CUTTING INTO OR REPAIRING EXISTING MAINS" EXCEPT THAT 5% HYPOCHLORITE SOLUTION SHALL BE USED.
- D. ALL TAPPING SLEEVES SHALL BE DISINFECTED AS FOLLOWS:
- 1) THOROUGHLY CLEAN THE EXTERIOR SURFACE OF THE MAIN TO BE TAPPED, THE SURFACES OF THE TAPPING SLEEVE AND THE SURFACE OF THE TAPPING EQUIPMENT THAT WILL COME INTO CONTACT WITH THE WATER.
- 2) THROUGHLY SWAB THE MAIN, THE TAPPING SLEEVE AND THE TAPPING EQUIPMENT WITH A 5% SODIUM HYPOCHLORITE SOLUTION.
- 3) ANY SURFACE THAT BECOMES CONTAMINATED AFTER BEING DISINFECTED, SHALL BE RECLEANED AND RESWABBED AS INDICATED ABOVE.
- E. AFTER FINAL FLUSHING AND PRIOR TO PLACING NEW LINES IN SERVICE, BACTERIOLOGICAL

TESTS SHALL BE PERFORMED AS INDICATED IN AWWA C651 AND AS FOLLOWS:

- 1) STANDARD CONDITIONS: AT LEAST ONE SAMPLE SHALL BE COLLECTED FROM THE END OF EACH NEW MAIN AND ONE FROM THE END OF EACH NEW BRANCH LINE. IN ADDITION, ONE ADDITIONAL SAMPLE SHALL BE COLLECTED FOR EACH 4,000 FEET OF MAIN OR BRANCH LINE. FOR EXAMPLE: FOR A 9,000 FEET MAIN, 3 SAMPLES ARE REQUIRED (I.E. 2 ADDITIONAL SAMPLES AND ONE SAMPLE AT THE END). THE LOCATION OF THE ADDITIONAL SAMPLES SHALL BE DETERMINED BY THE CONTRACTOR AND APPROVED BY THE NAVY INSPECTOR (CODE PW352, PHONE NO. 473-0037).
- 2) SPECIAL CONDITIONS: IF DURING CONSTRUCTION. TRENCH WATER HAS ENTERED THE LINE OR IF IN THE OPINION OF THE NAVY INSPECTOR EXCESSIVE QUANTITIES OF DIRT OR DEBRIS HAVE ENTERED THE LINE, SAMPLES SHALL BE TAKEN AT INTERVAL OF APPROXIMATELY 200 FEET AND SHALL BE IDENTIFIED BY LOCATION.
- F. DISINFECTION OF MAINS AND BRANCH LINES SHALL BE REPEATED UNTIL SAMPLES SHOW THE ABSENCE OF COLIFORM ORGANISMS.
- G. FINAL BACTERIOLOGICAL TEST RESULTS, THAT SHOW THE ABSENCE OF COLIFORM ORGANISMS, SHALL BE PROVIDED TO THE PWC UTILITIES DEPARTMENT REPRESENTATIVE AT THE FINAL INSPECTION OF THE PROJECT OR PRIOR TO PLACING THE LINE IN SERVICE WHICHEVER OCCURS FIRST. THE LOCATION WHERE THE BACTERIOLOGICAL SAMPLES WERE TAKEN SHALL BE IDENTIFIED.

SEWER NOTES

- 1. ALL SEWER CONSTRUCTION SHALL BE PERFORMED IN ACCORDANCE WITH THE STANDARD SPECIFICATIONS FOR PUBLIC WORKS CONSTRUCTION, SEPTEMBER 1986, STANDARD DETAILS FOR PUBLIC WORKS CONSTRUCTION, SEPTEMBER 1984, AS AMENDED, OF THE DEPARTMENT OF PUBLIC WORKS, CITY AND COUNTY OF HONOLULU AND THE COUNTIES OF KAUAI, MAUI AND HAWAII, CURRENT CITY PRACTICES, THE REVISED ORDINANCES OF HONOLULU, 1990, AS AMENDED, AND THE DESIGN STANDARDS OF THE DEPARTMENT OF WASTEWATER MANAGEMENT, VOL. 1, JULY 1993.
- 2. THE NAVFAC HAWAII WASTEWATER BRANCH (CODE PW64, PHONE NO. 473-0037) SHALL BE INFORMED 60 DAYS IN ADVANCE OF ANY WORK ON THE NAVY'S SEWER LINE.
- 3. IN THE EVENT THAT ANY CHANGE IN ALIGNMENT OR GRADE FOR THE PROPOSED SEWERS IS REQUIRED DUE TO UNFORESEEN CONFLICT WITH OTHER UTILITIES. THE ENGINEER IN CHARGE OR THE MAKER OF THE PLANS SHALL BE RESPONSIBLE FOR THE REQUIRED CHANGES.
- 4. CRUSHED ROCK CRADLE IS PERMITTED WHERE SOIL IS STABLE. IN AREAS OF UNSTABLE SOIL, THE MAKER OF THE PLANS AND THE CONSTRUCTION ENGINEER WILL DETERMINE THE PIPE SUPPORT REQUIRED.
- 5. THE UNDERGROUND PIPES, CABLES OR DUCTLINES KNOWN TO EXIST BY THE ENGINEER FROM HIS RESEARCH OF RECORDS ARE INDICATED ON THE PLANS. THE CONTRACTOR SHALL VERIFY THE LOCATION AND DEPTH OF THE FACILITIES, INCLUDING AND AFFECTING SEWER LINES, AND EXERCISE PROPER CARE IN EXCAVATING THE AREA. THE CONTRACTOR SHALL BE RESPONSIBLE AND SHALL PAY FOR ALL DAMAGED UTILITIES.
- 6. SEWER LATERAL LOCATION MEASURED ALONG THE FRONT PROPERTY LINE SHALL BE SIX (6) FEET FROM THE PROPERTY CORNER UNLESS OTHERWISE NOTED ON THE PLANS AND SHOULD NOT STRADDLE ELECTRICAL TRANSFORMER PAD.
- 7. MINIMUM SLOPE FOR SEWER LATERALS SHALL BE 1.00% UNLESS OTHERWISE NOTED.
- 8. BUILDING PLUMBING FACILITIES SHALL BE CONTROLLED BY SEWER LATERAL INVERTS.
- 9. THE CONTRACTOR SHALL BE RESPONSIBLE FOR MAINTAINING CONTINUOUS SEWER SERVICE TO ALL AFFECTED AREAS DURING CONSTRUCTION. CONTRACTOR SHALL BE RESPONSIBLE FOR DIVERTING SEWAGE IF NECESSARY, INCLUDING THE PROVISION OF ALL LABOR, TANK TRUCKS, PUMPS, TEMPORARY PIPING, HOSES AND ANY OTHER ITEMS REQUIRED FOR PROVIDING UNINTERRUPTED SERVICE.
- 10. UPON COMPLETION OF THE SEWER CONSTRUCTION, MAKE ADVANCE ARRANGEMENTS (3 WORKING DAYS MINIMUM), WITH NAVFAC HAWAII PW64 FOR FINAL ACCEPTANCE INSPECTION OF THE NEW SEWER CONSTRUCTION.
- 11. UPON COMPLETION OF THE CONSTRUCTION, NAVFAC HAWAII PW64 WILL REQUIRE SEWER SYSTEM AS-BUILT DRAWINGS.
- 12. THE CONTRACTOR SHALL BE RESPONSIBLE FOR ANY SEWAGE SPILLS CAUSED DURING CONSTRUCTION. THE CONTRACTOR SHALL NOTIFY THE STATE DEPARTMENT OF HEALTH AND UTILIZE APPROPRIATE SAMPLING AND ANALYZING PROCEDURES. THE CONTRACTOR SHALL BE RESPONSIBLE FOR ALL PUBLIC NOTIFICATIONS AND PRESS RELEASES.
- 13. ALL SEWER PIPE JOINTS WITHIN EASEMENTS SHALL BE WRAPPED WITH GEOTEXTILE ROOT
- 14. GEOTEXTILE FABRIC TO ENVELOP THE PIPE CRADLE AND SELECT BACKFILL MATERIAL SHALL BE PROVIDED WHERE WATER OR UNSTABLE SOIL CONDITIONS ARE ENCOUNTERED.
- 15. POTENTIALLY LETHAL LEVELS OF HYDROGEN SULFIDE (H2S) GAS MAY DEVELOP IN THE GRAVITY SEWER COLLECTION SYSTEM.
- 16. ALL SEWER LINES SHALL BE PLACED ON A UNIFORM STRAIGHT GRADE. ALL SEWER PIPES SHALL BE PROVIDED WITH METALLIC-BACKED WARNING TAPE OR NON-METALLIC-BACKED WARNING TAPE WITH TRACER WIRE.
- 17. CONSTRUCTION DEWATERING INTO THE NAVY'S SEWER COLLECTION SYSTEM IS PROHIBITED.
- 18. ANY SEWER MANHOLE TO BE ABONDONED SHALL HAVE ITS CONE SECTION REMOVED AND DISPOSED OF, PIPE PENETRATIONS PLUGGED WITH CLASS "C" CONCRETE AND THE REMAINING RISER STRUCTURE BACKFILLED AND COMPACTED TO FINISH GRADE.
- 19. CLEANOUTS ON ANY ABANDONED SERVICE LATERAL SHALL BE PLUGGED AND TERMINATED A MINIMUM OF 12 INCHES BELOW FINISH GRADE.
- 20. PRIOR TO ABANDONMENT, PIPE SHALL BE FILLED WITH FLOWABLE FILL AS NOTED.
- 21. ADJUST ALL MANHOLE FRAMES AND COVERS TO THE NEW FINISH GRADE
- 22. THE CONTRACTOR SHALL ENSURE THAT LOOSE MATERIAL, TOOLS AND EQUIPMENT FROM CONSTRUCTION OPERATIONS ARE APPROPRIATELY REMOVED FROM THE SEWER COLLECTION SYSTEM. ANY DAMAGE TO DOWNSTREAM LIFT STATION EQUIPMENT RESULTING FROM NEGLIGENCE WILL BE ASSESSED TO THE CONTRACTOR.



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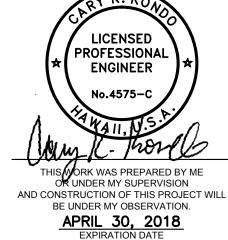
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OF THE LICENSE Revisions ADDED SHEET, MOVED NOTES

Sheet

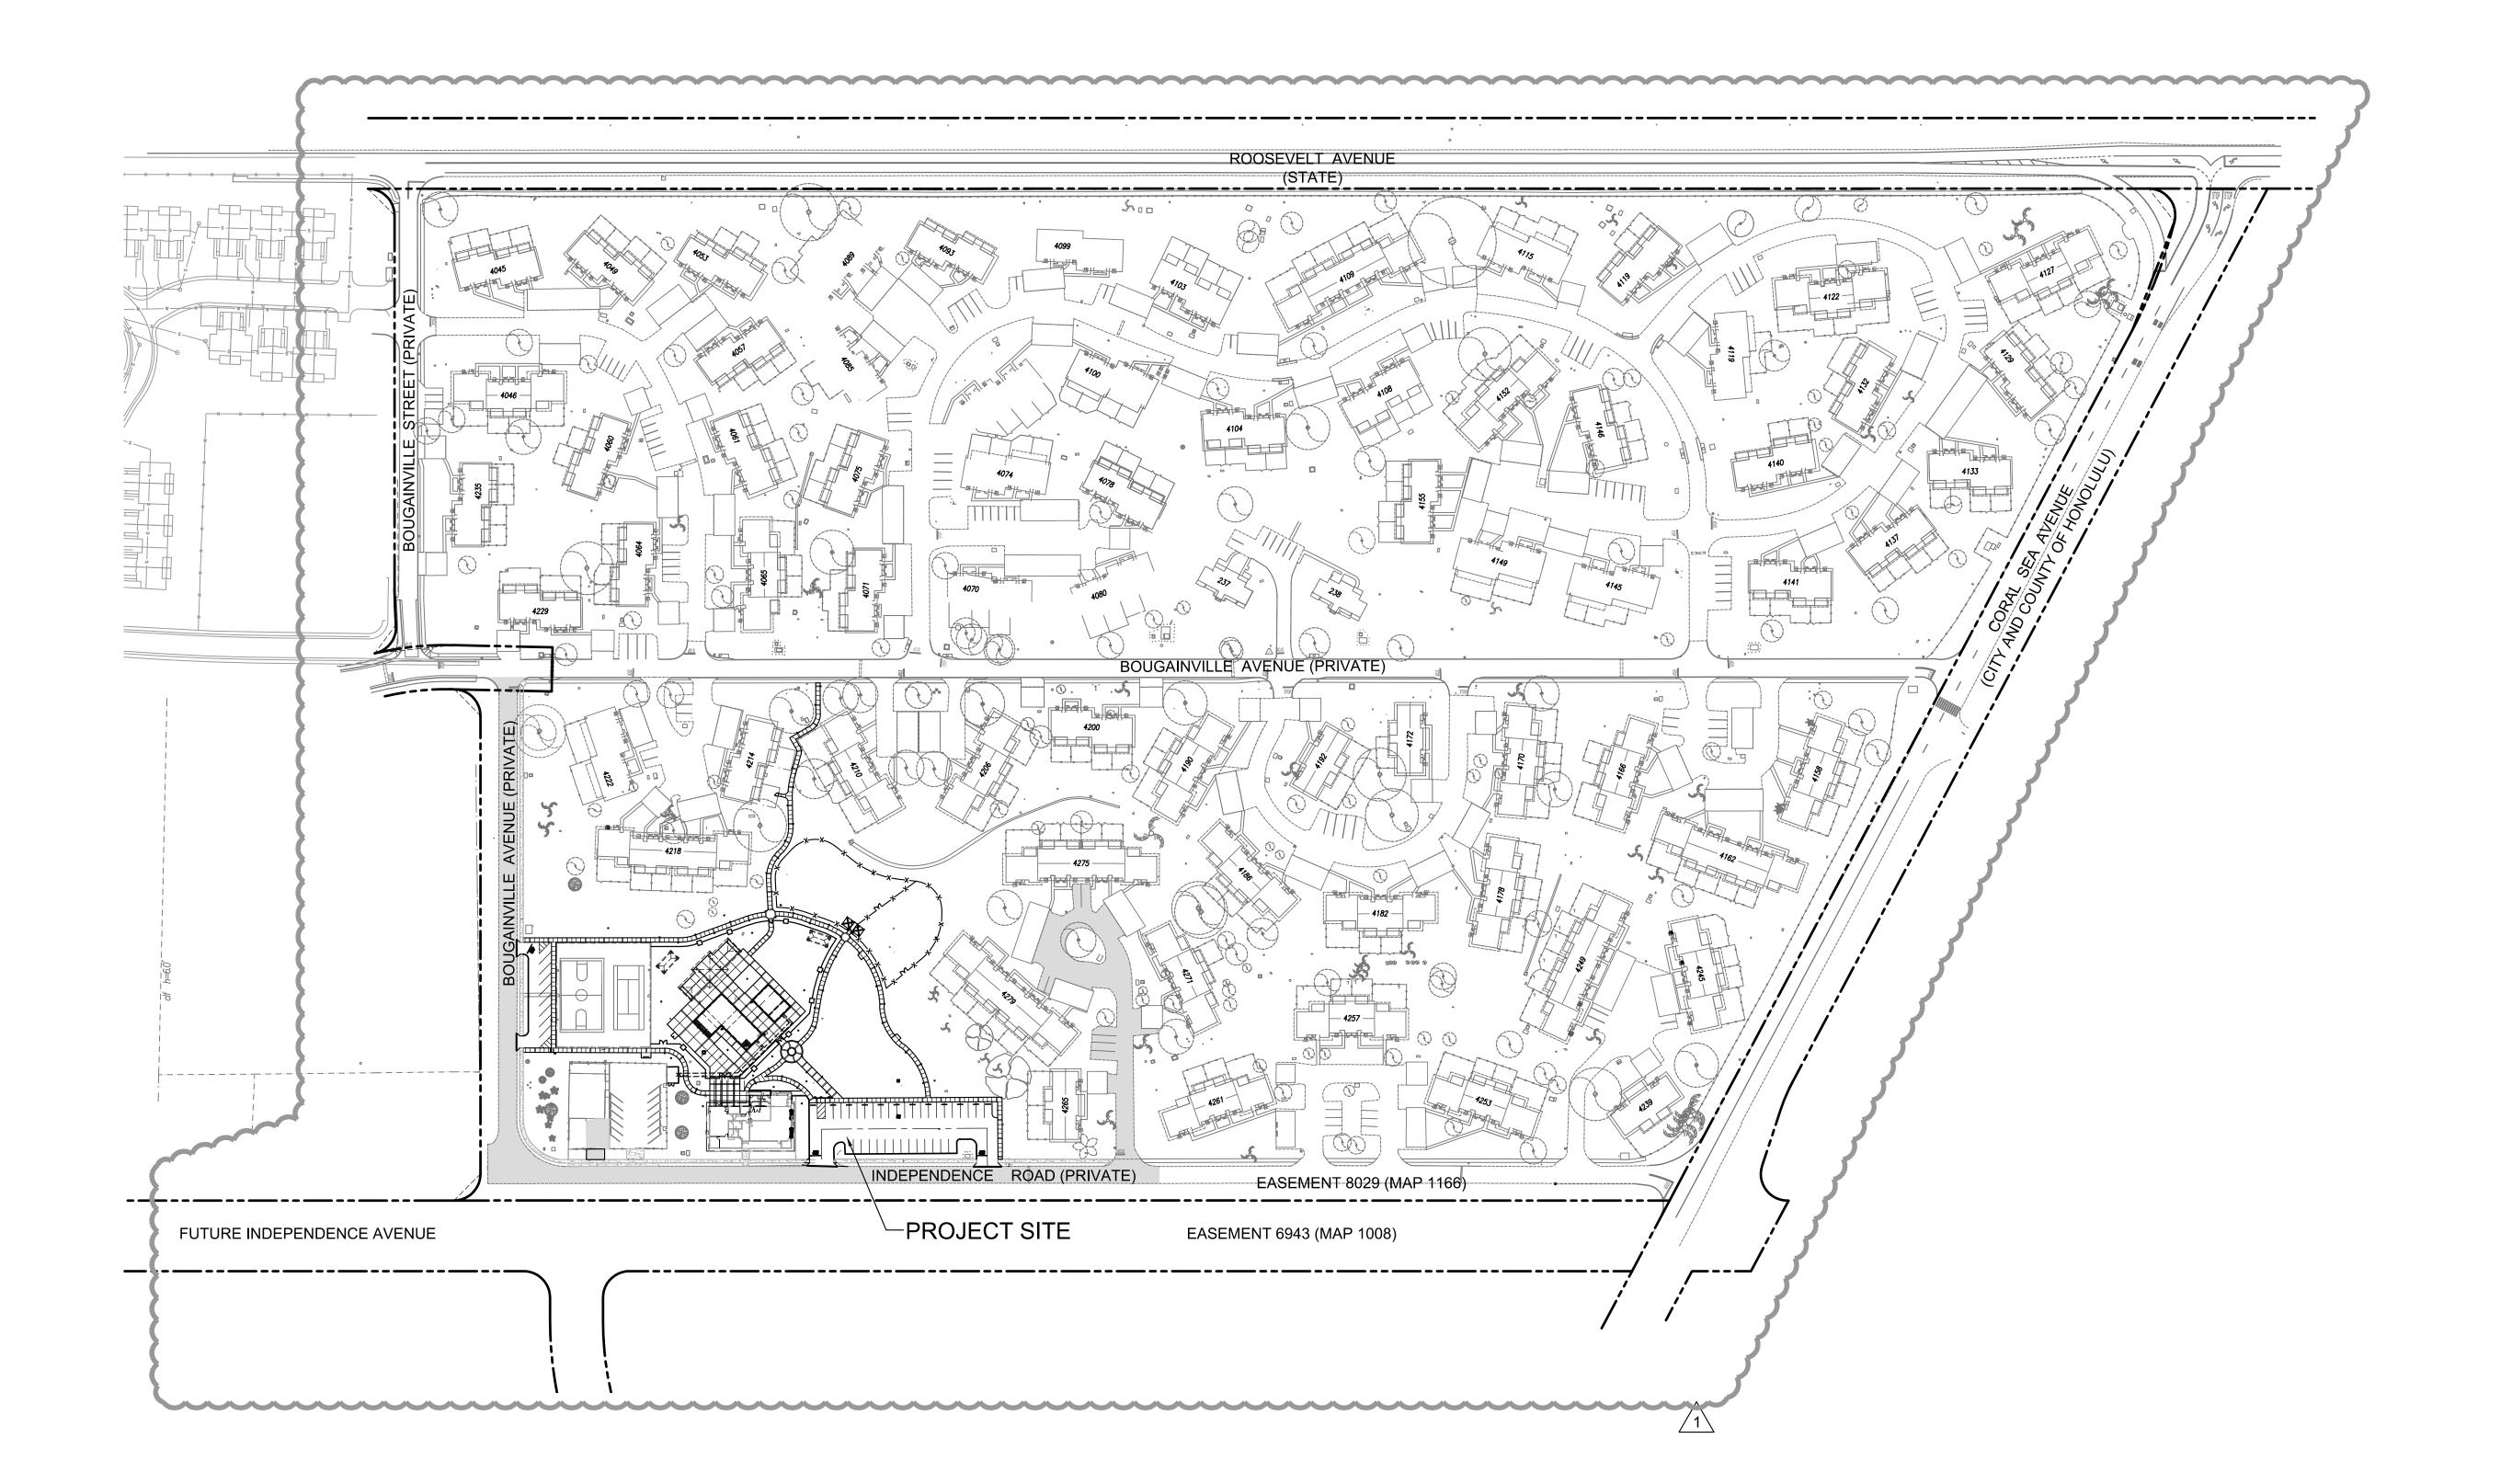
CONSTRUCTION NOTES - 1a

Project No. 2015.33.0601 Designed by: CKK

Date:

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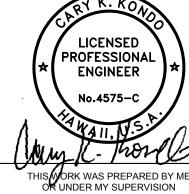
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APRIL 30, 2018

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Revisions

ADDED EASEMENT AND PROPERTY LINES

Sheet

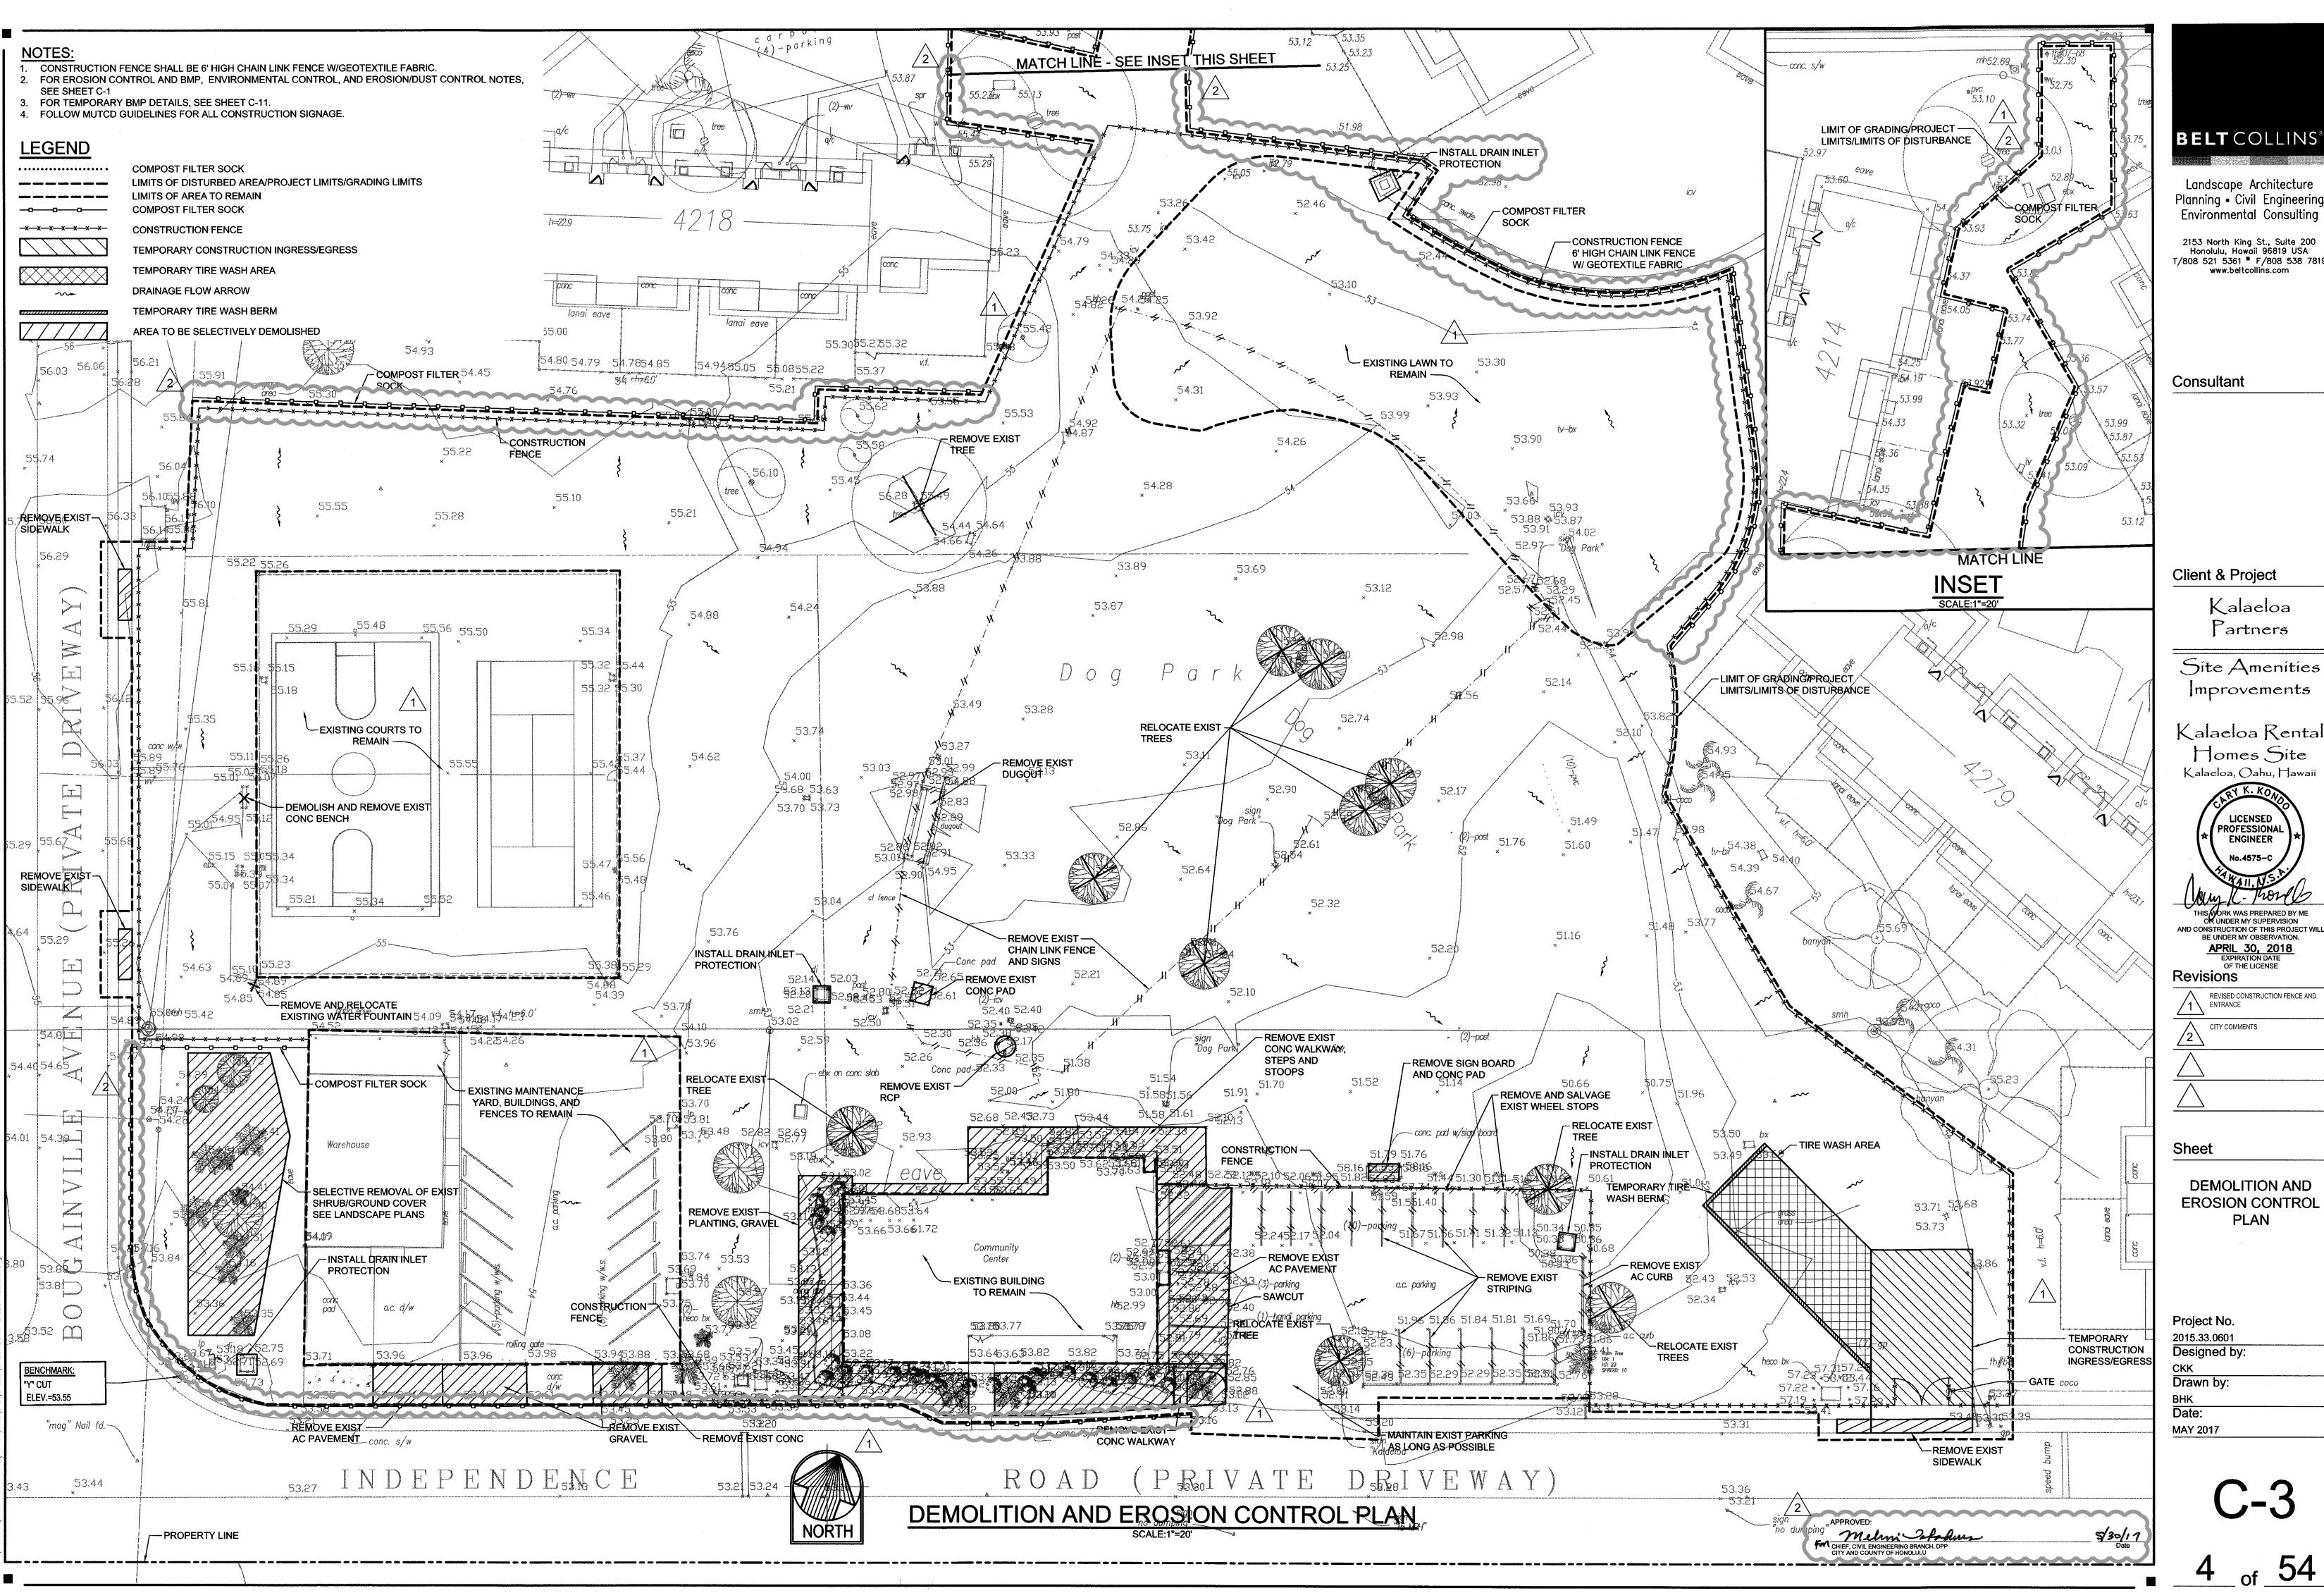
GENERAL SITE PLAN

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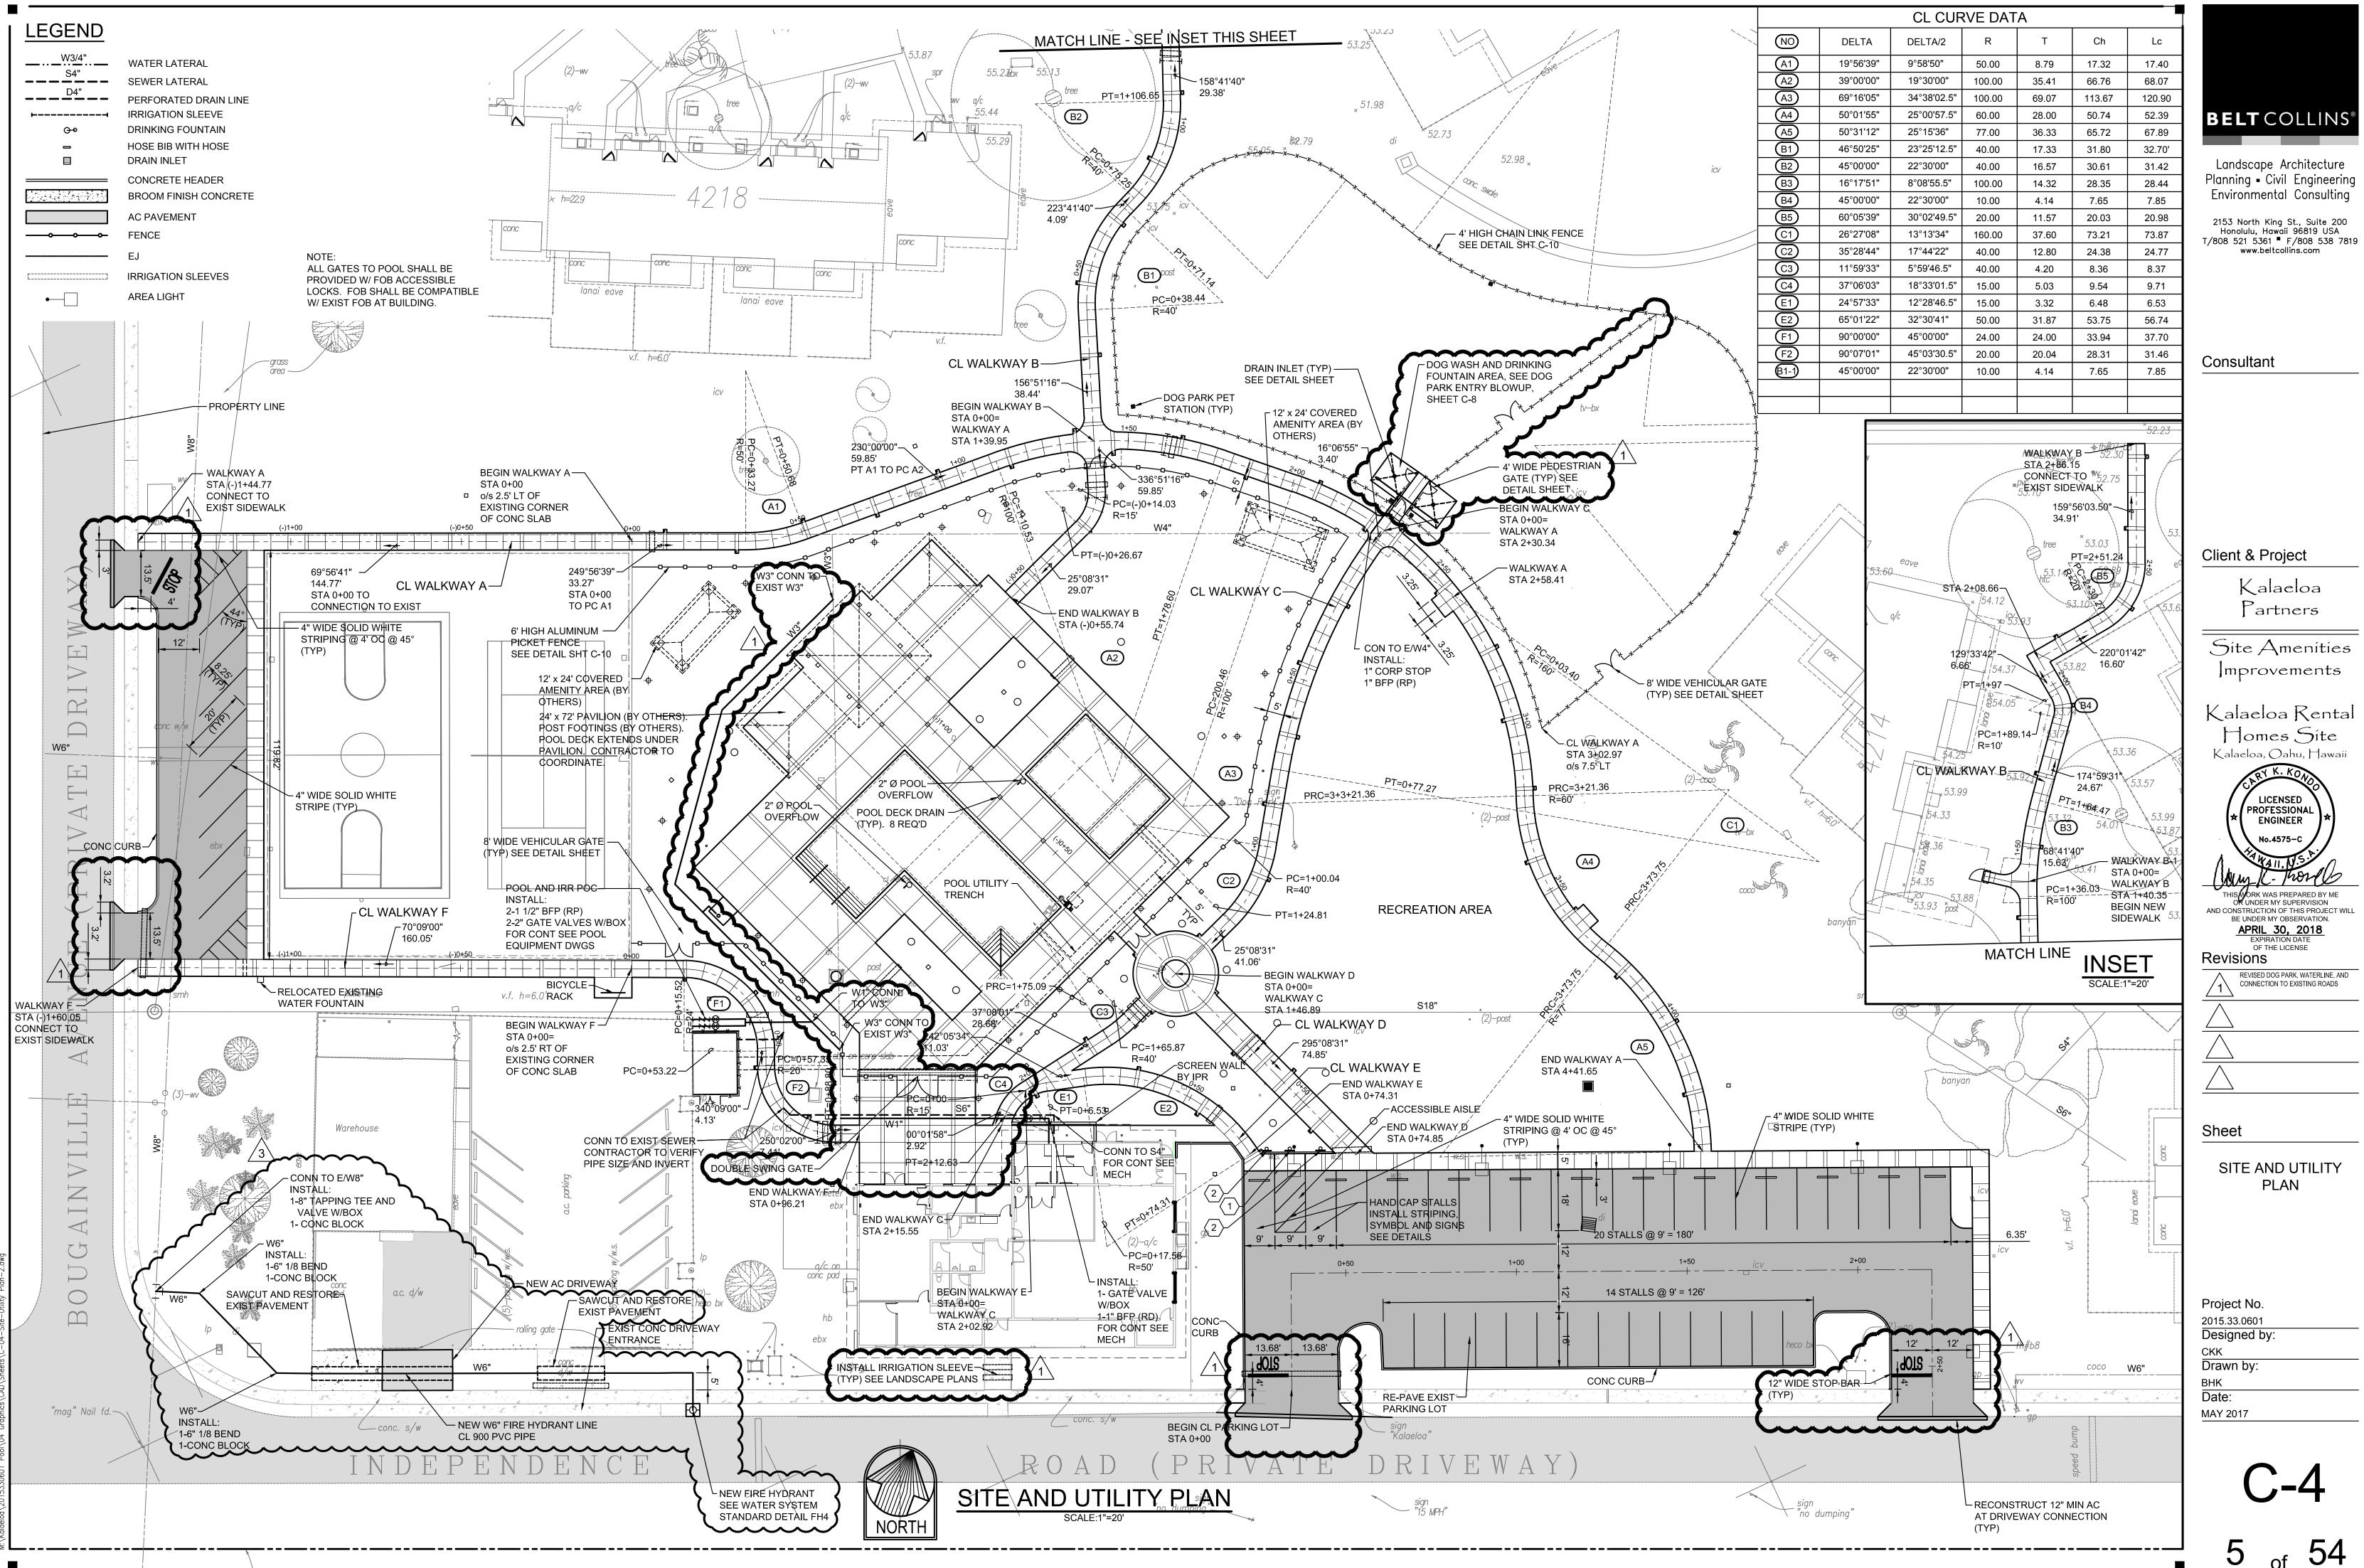
Site Amenities mprovements


Homes Site Kalaeloa, Oahu, Hawaii




REVISED CONSTRUCTION FENCE AND

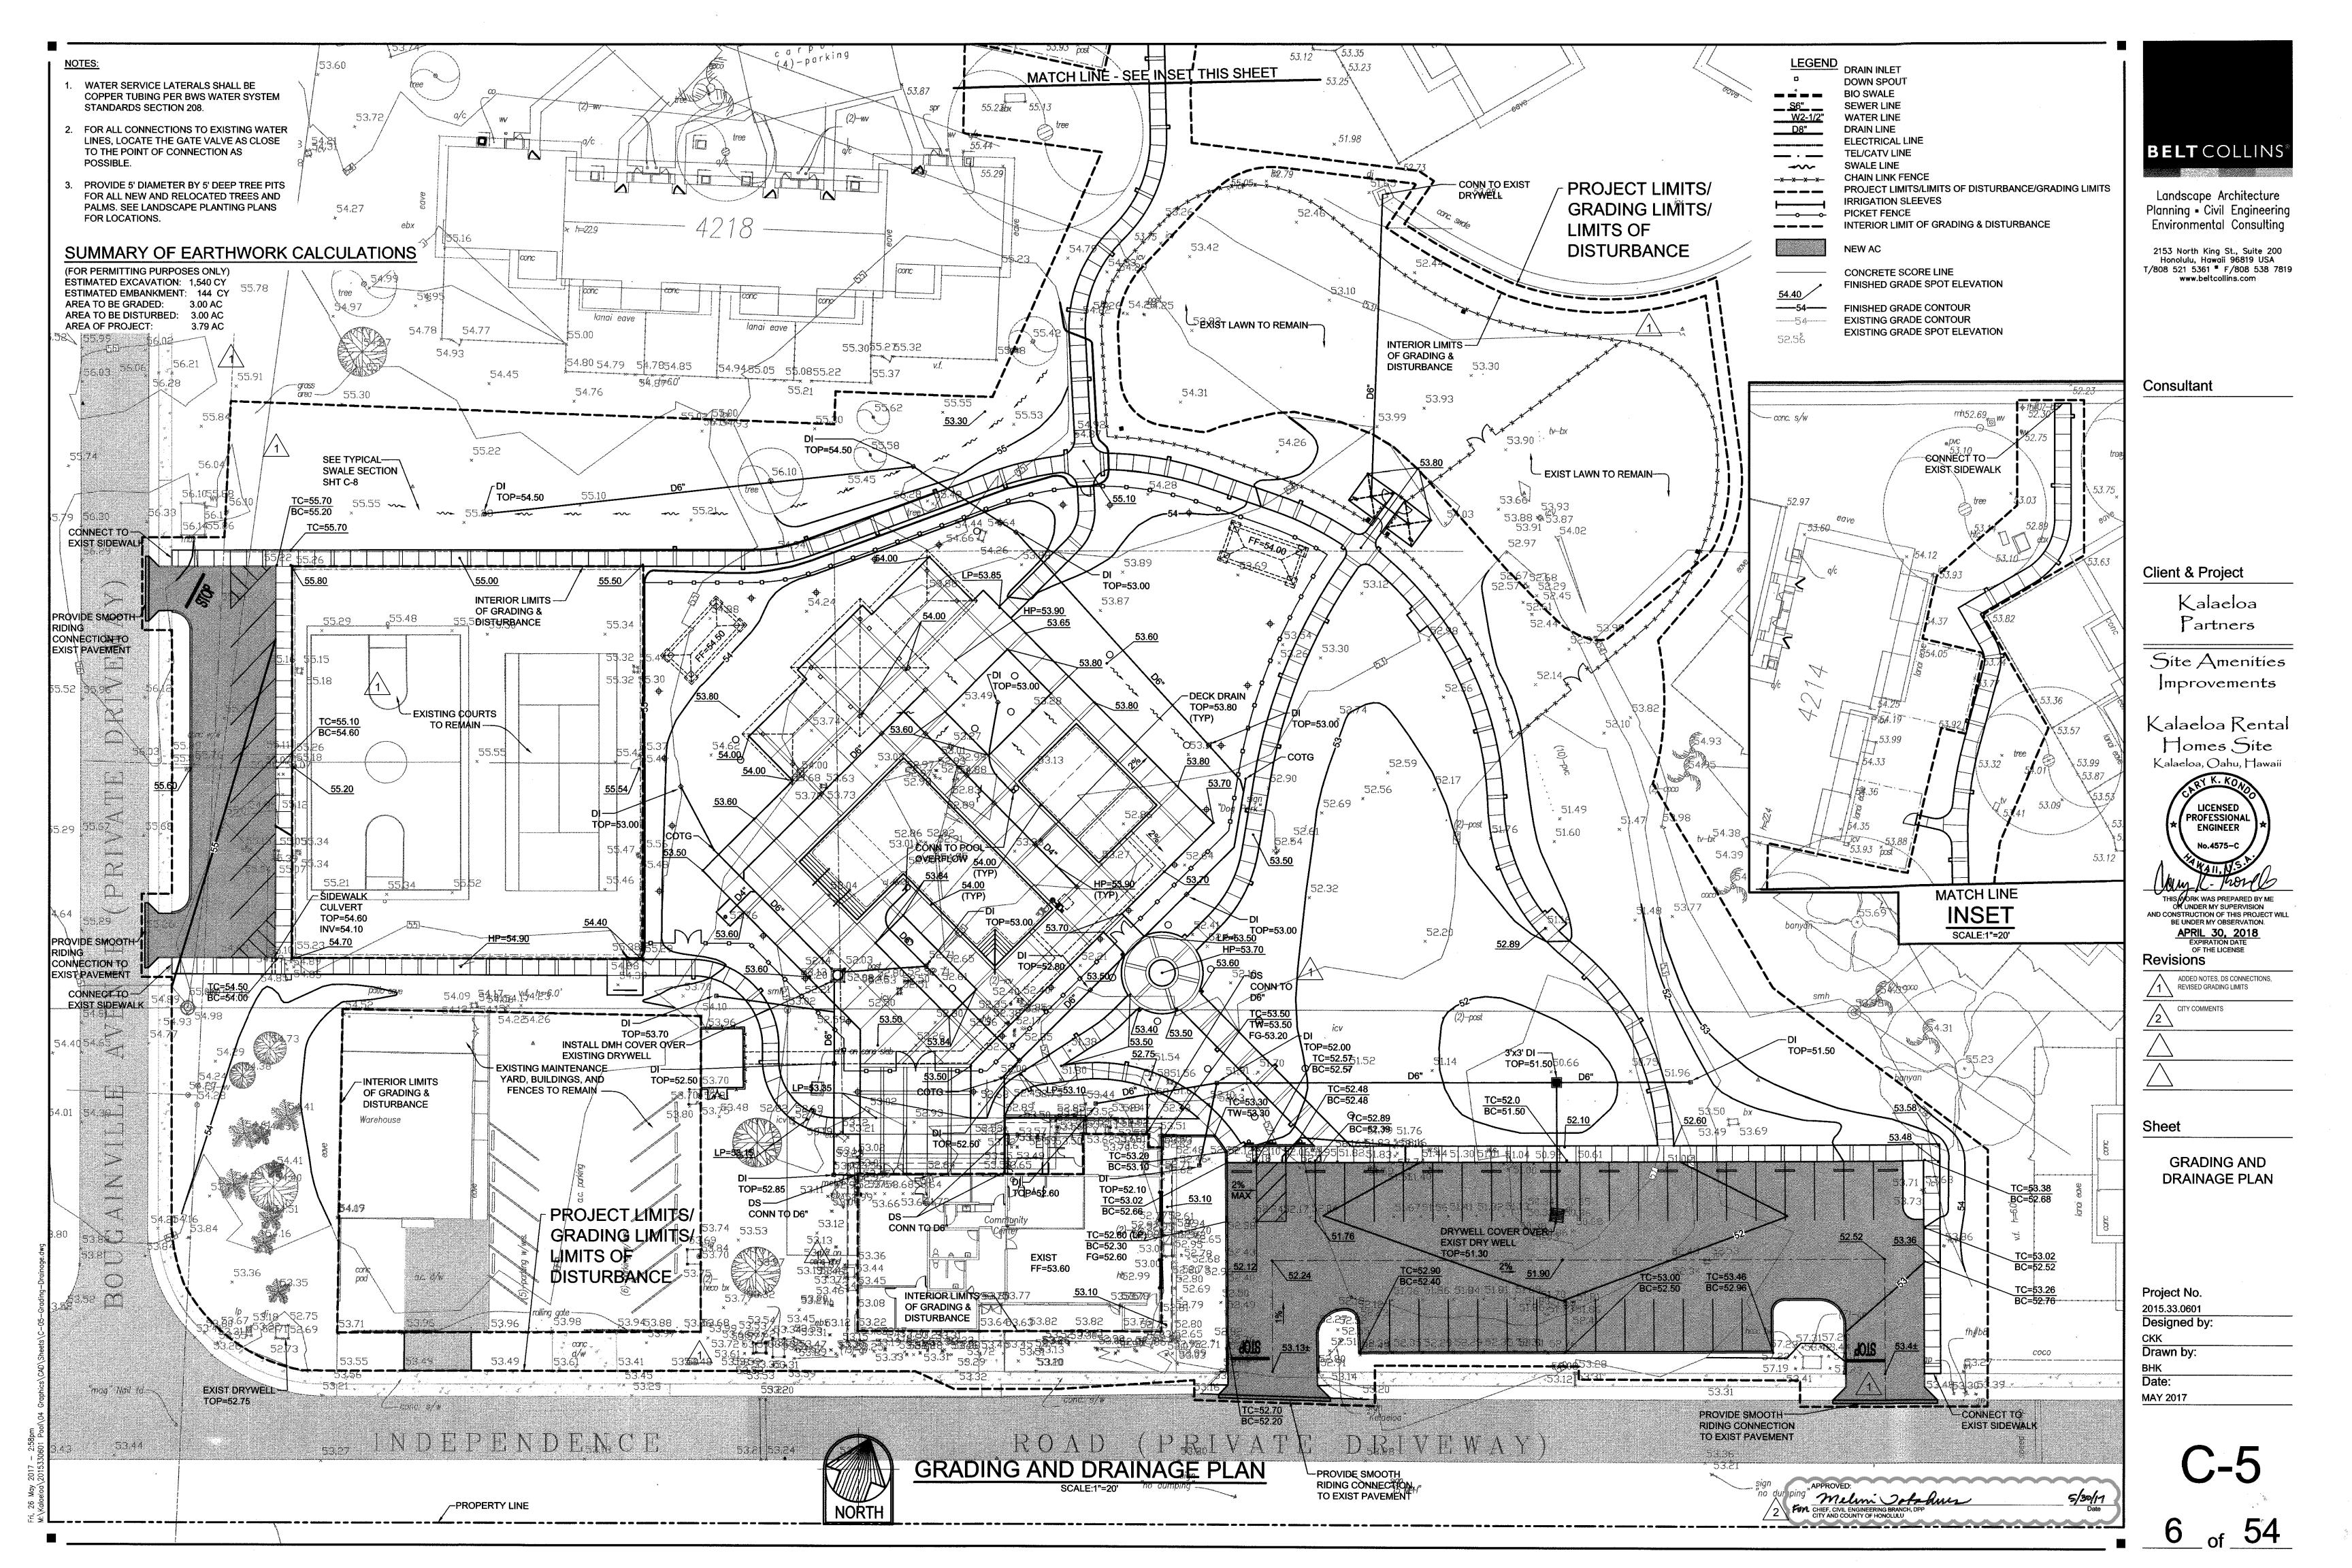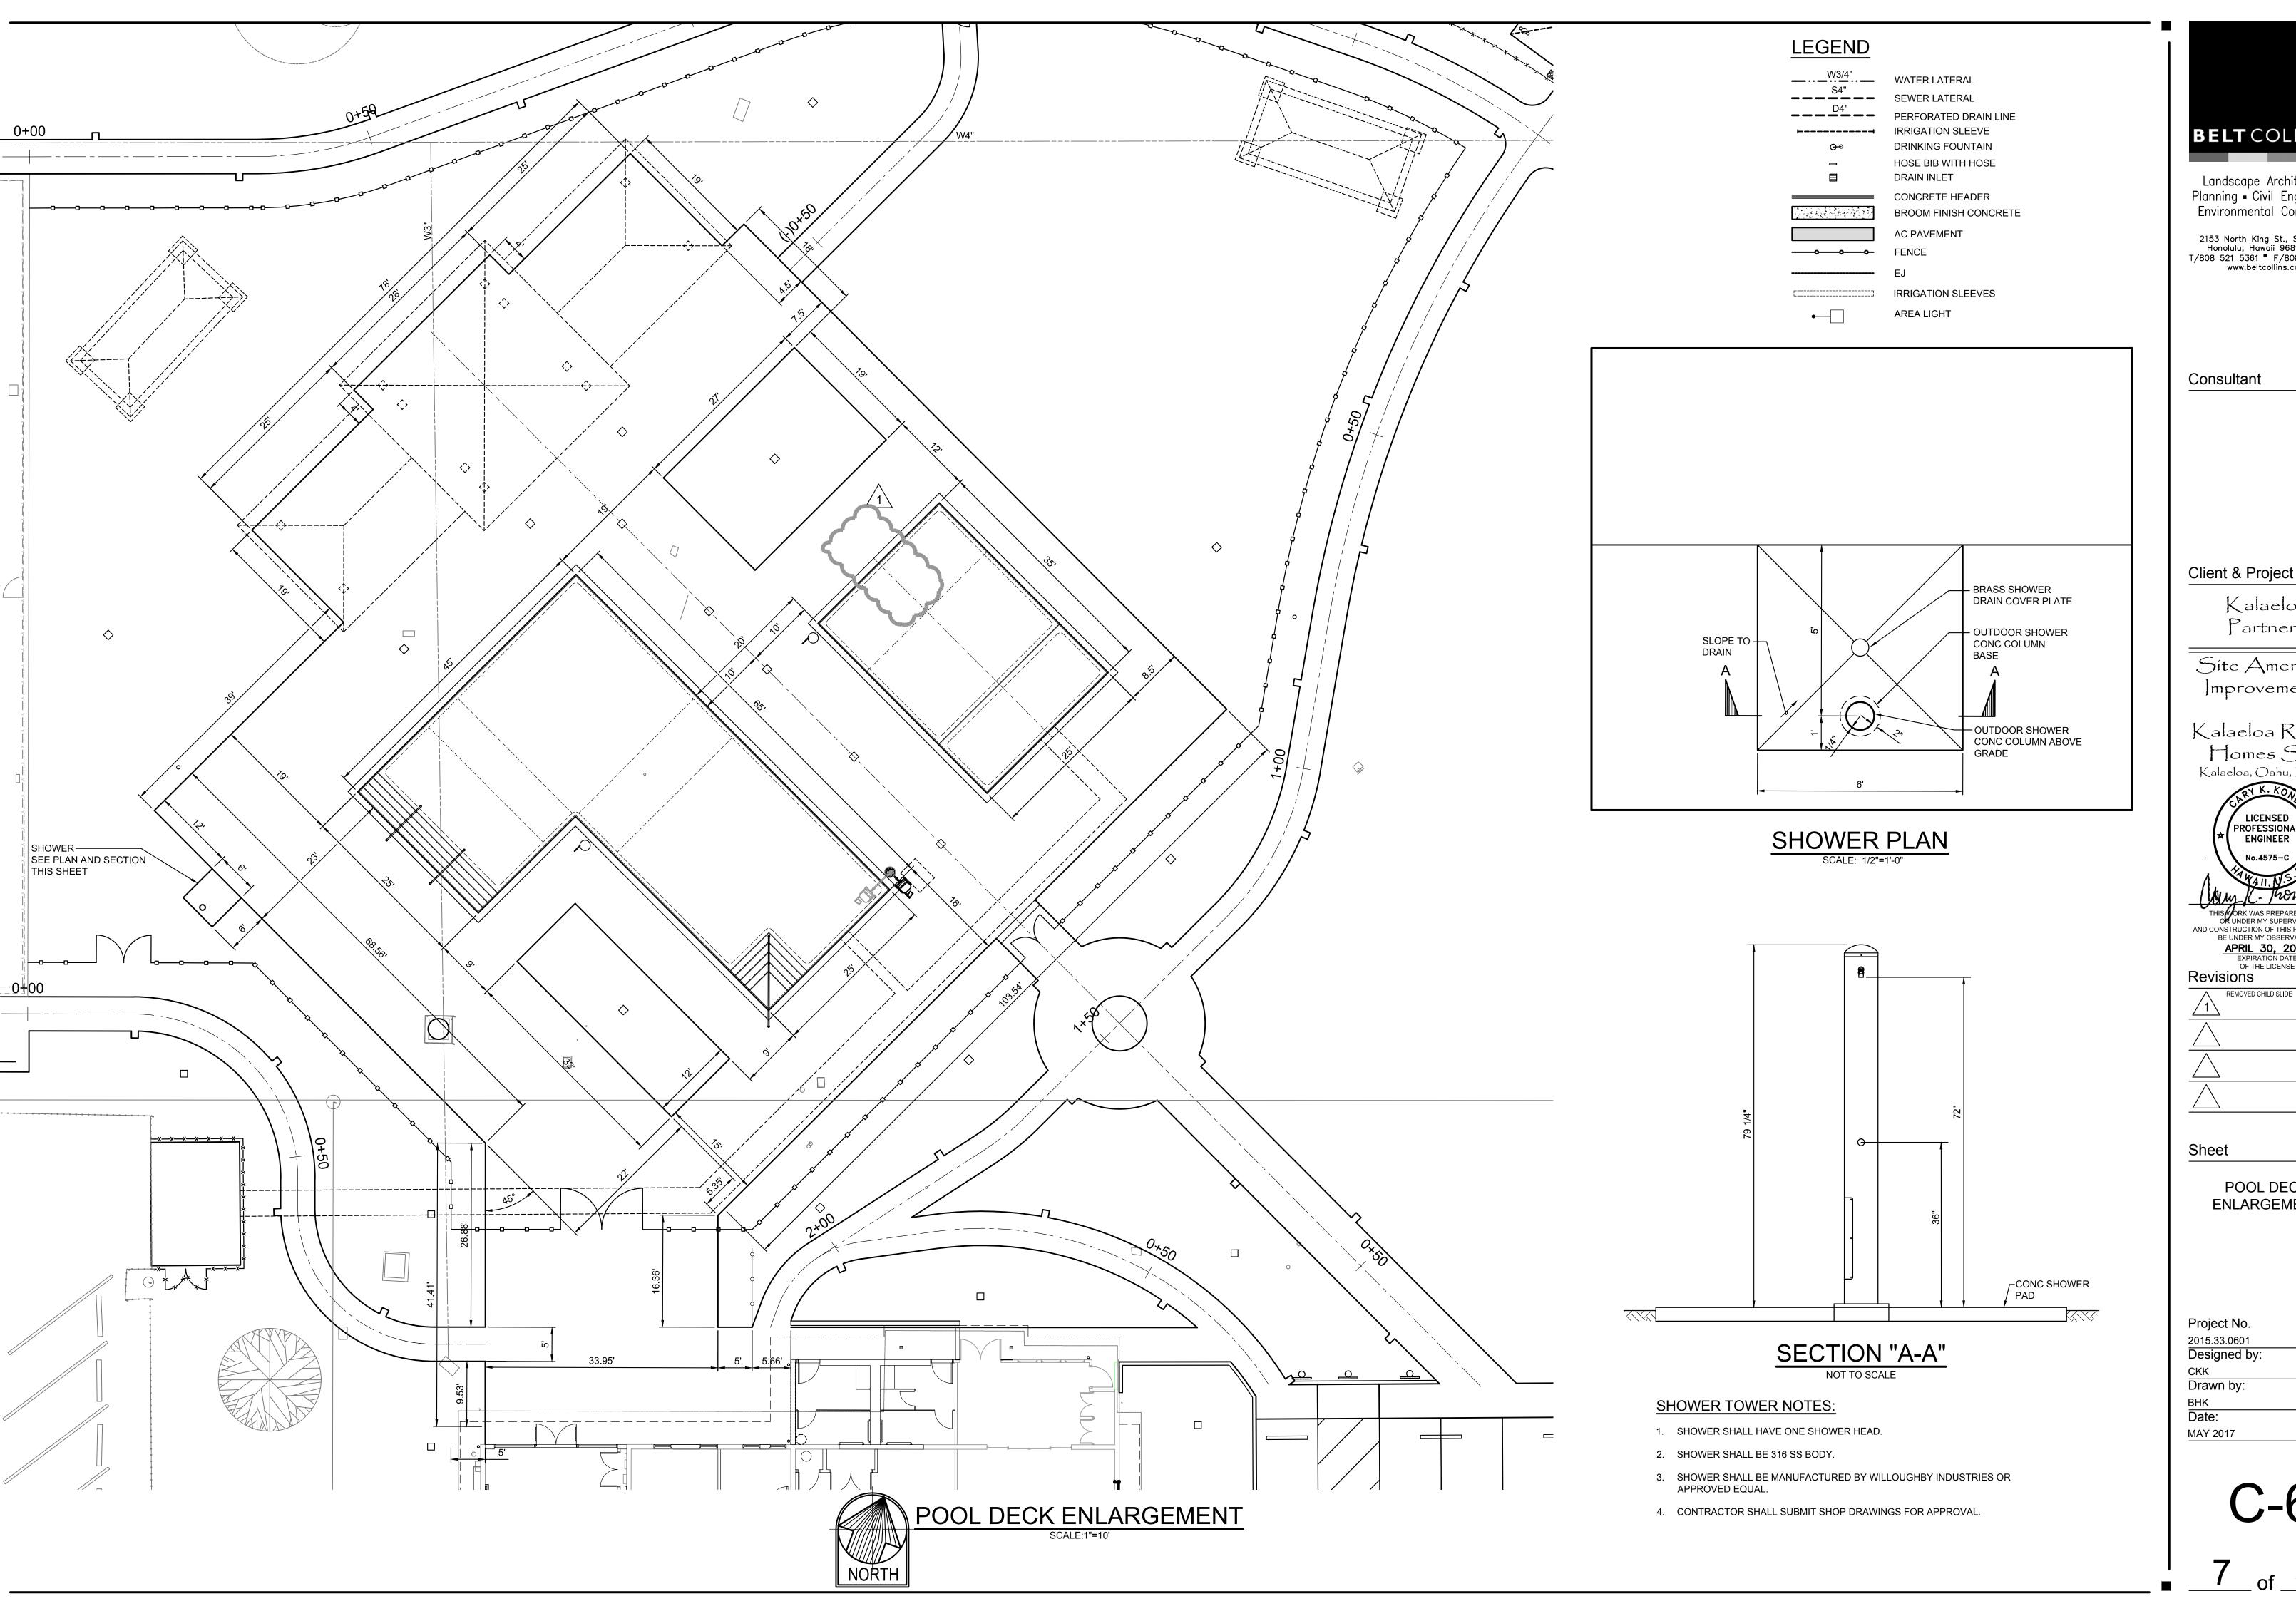DEMOLITION AND EROSION CONTROL PLAN







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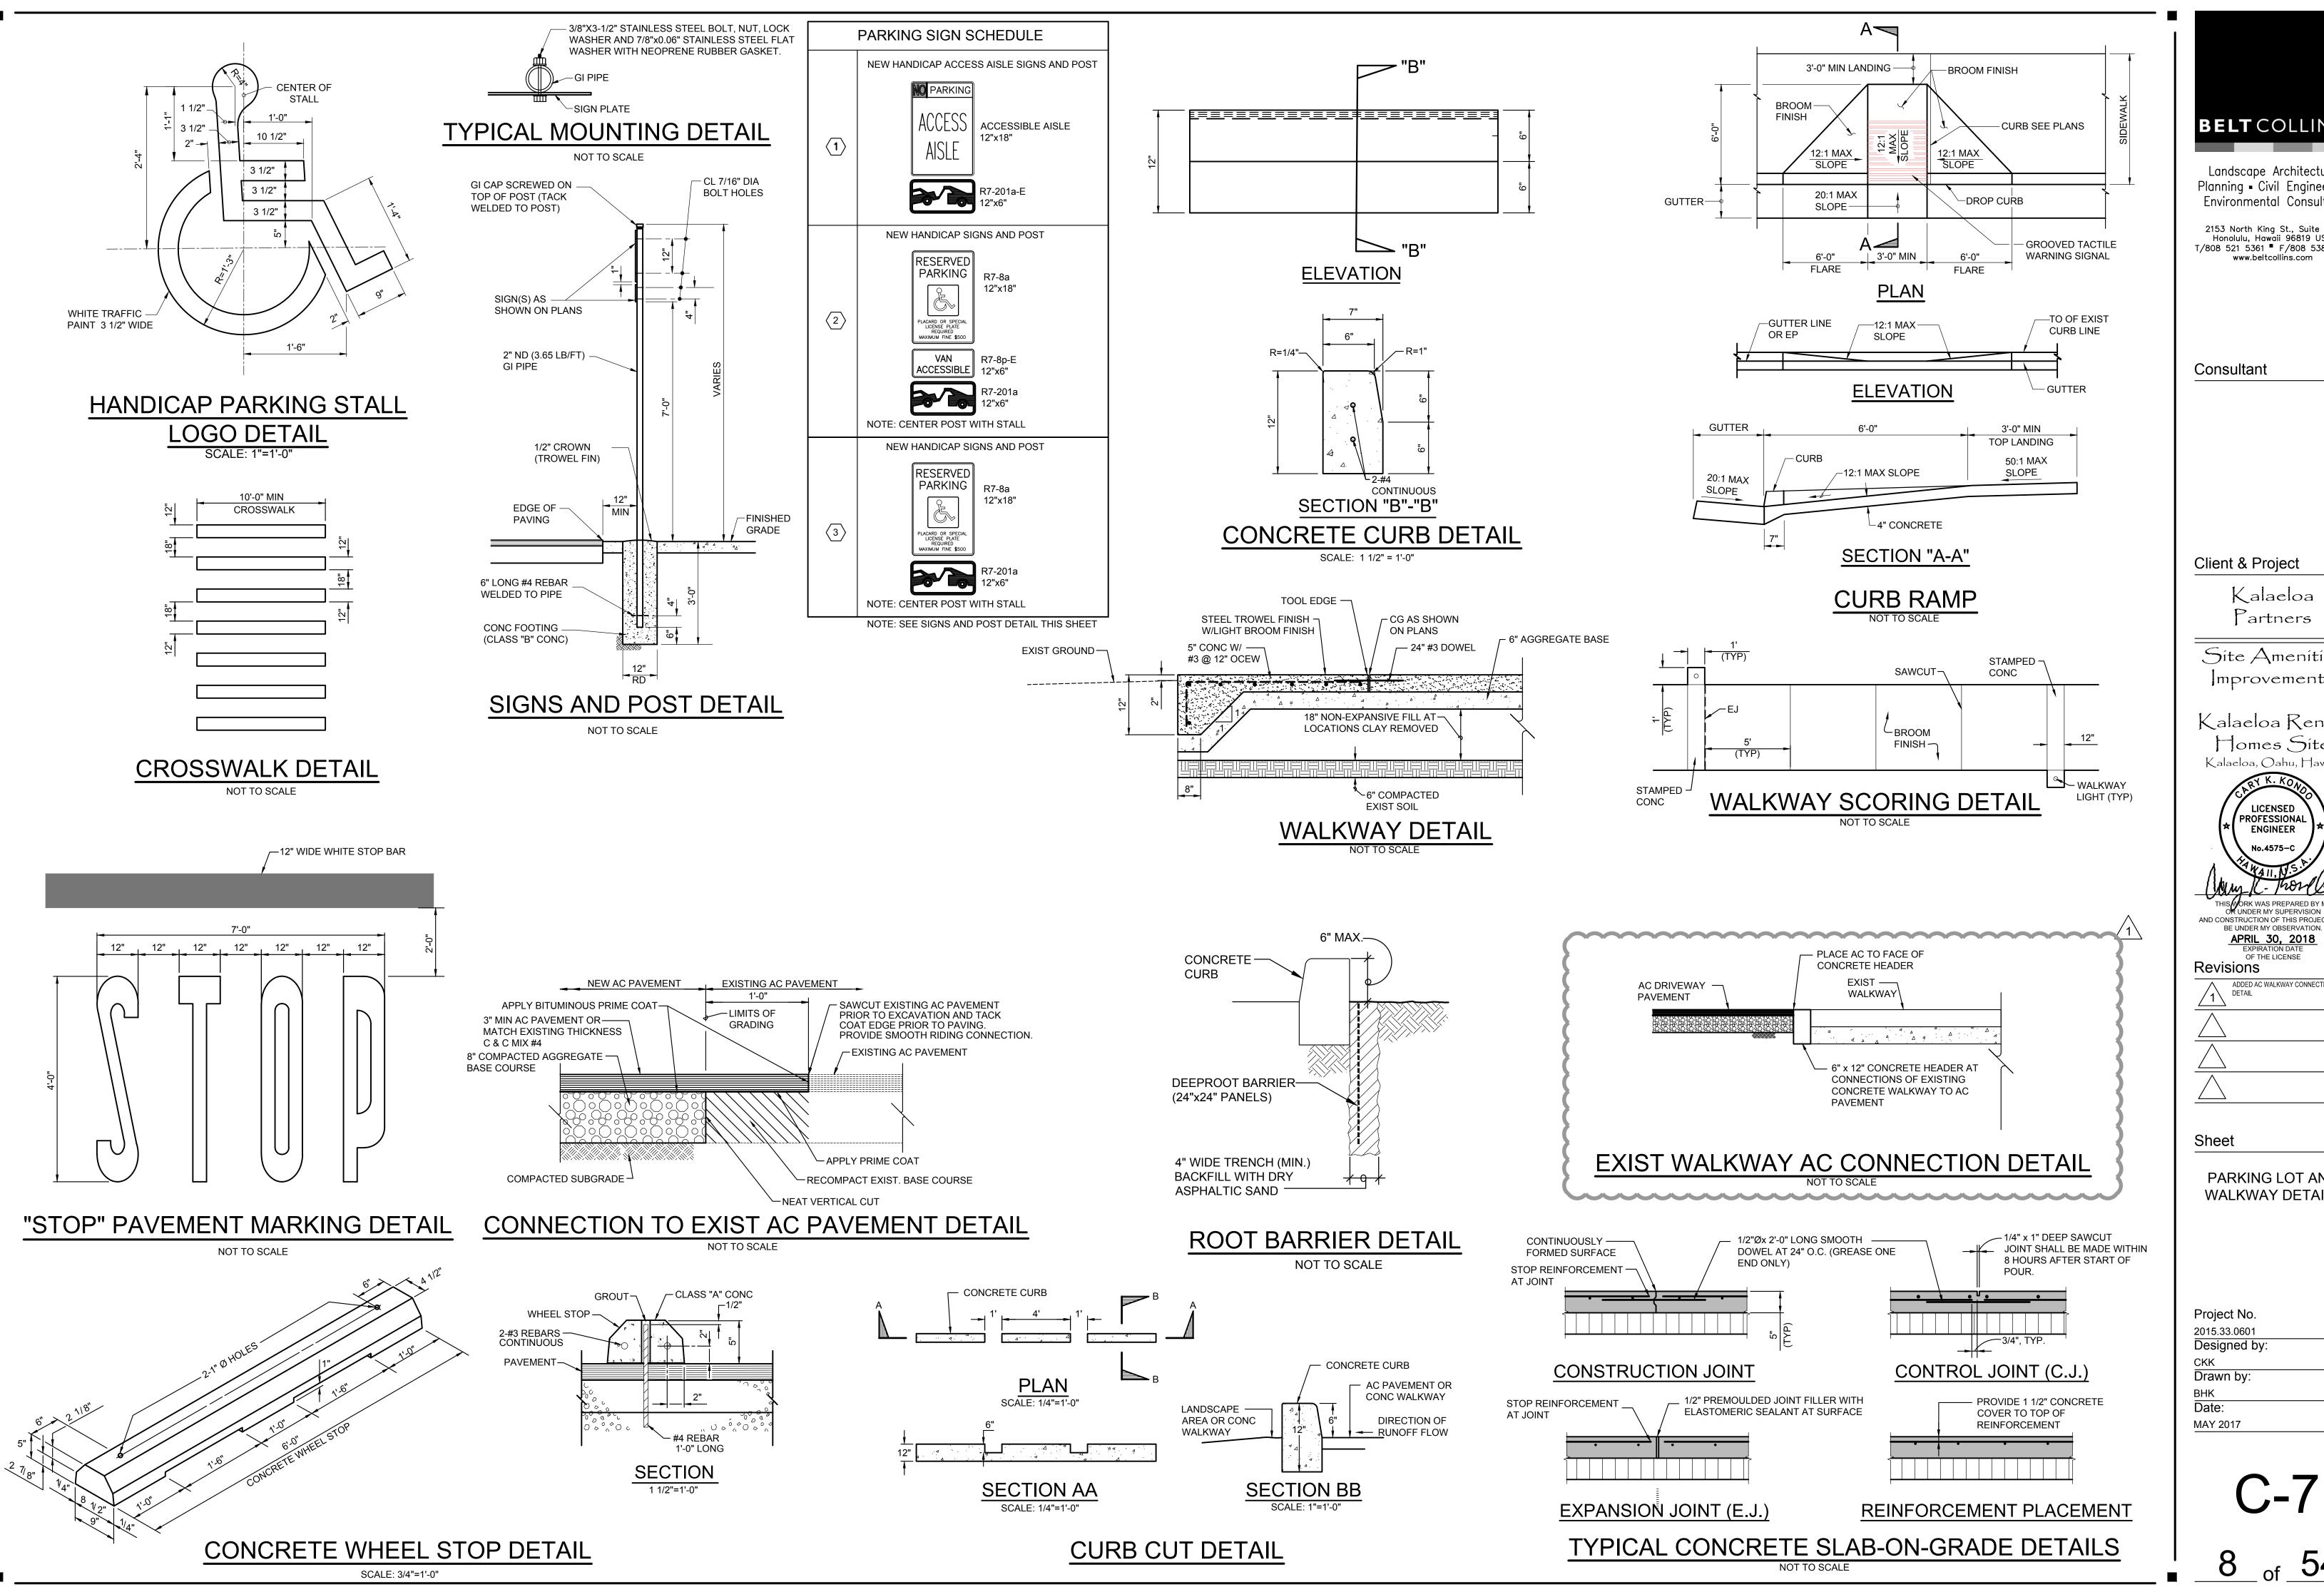
Revisions

REMOVED CHILD SLIDE

POOL DECK **ENLARGEMENT**

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APRIL 30, 2018 OF THE LICENSE

Revisions ADDED AC WALKWAY CONNECTION DETAIL

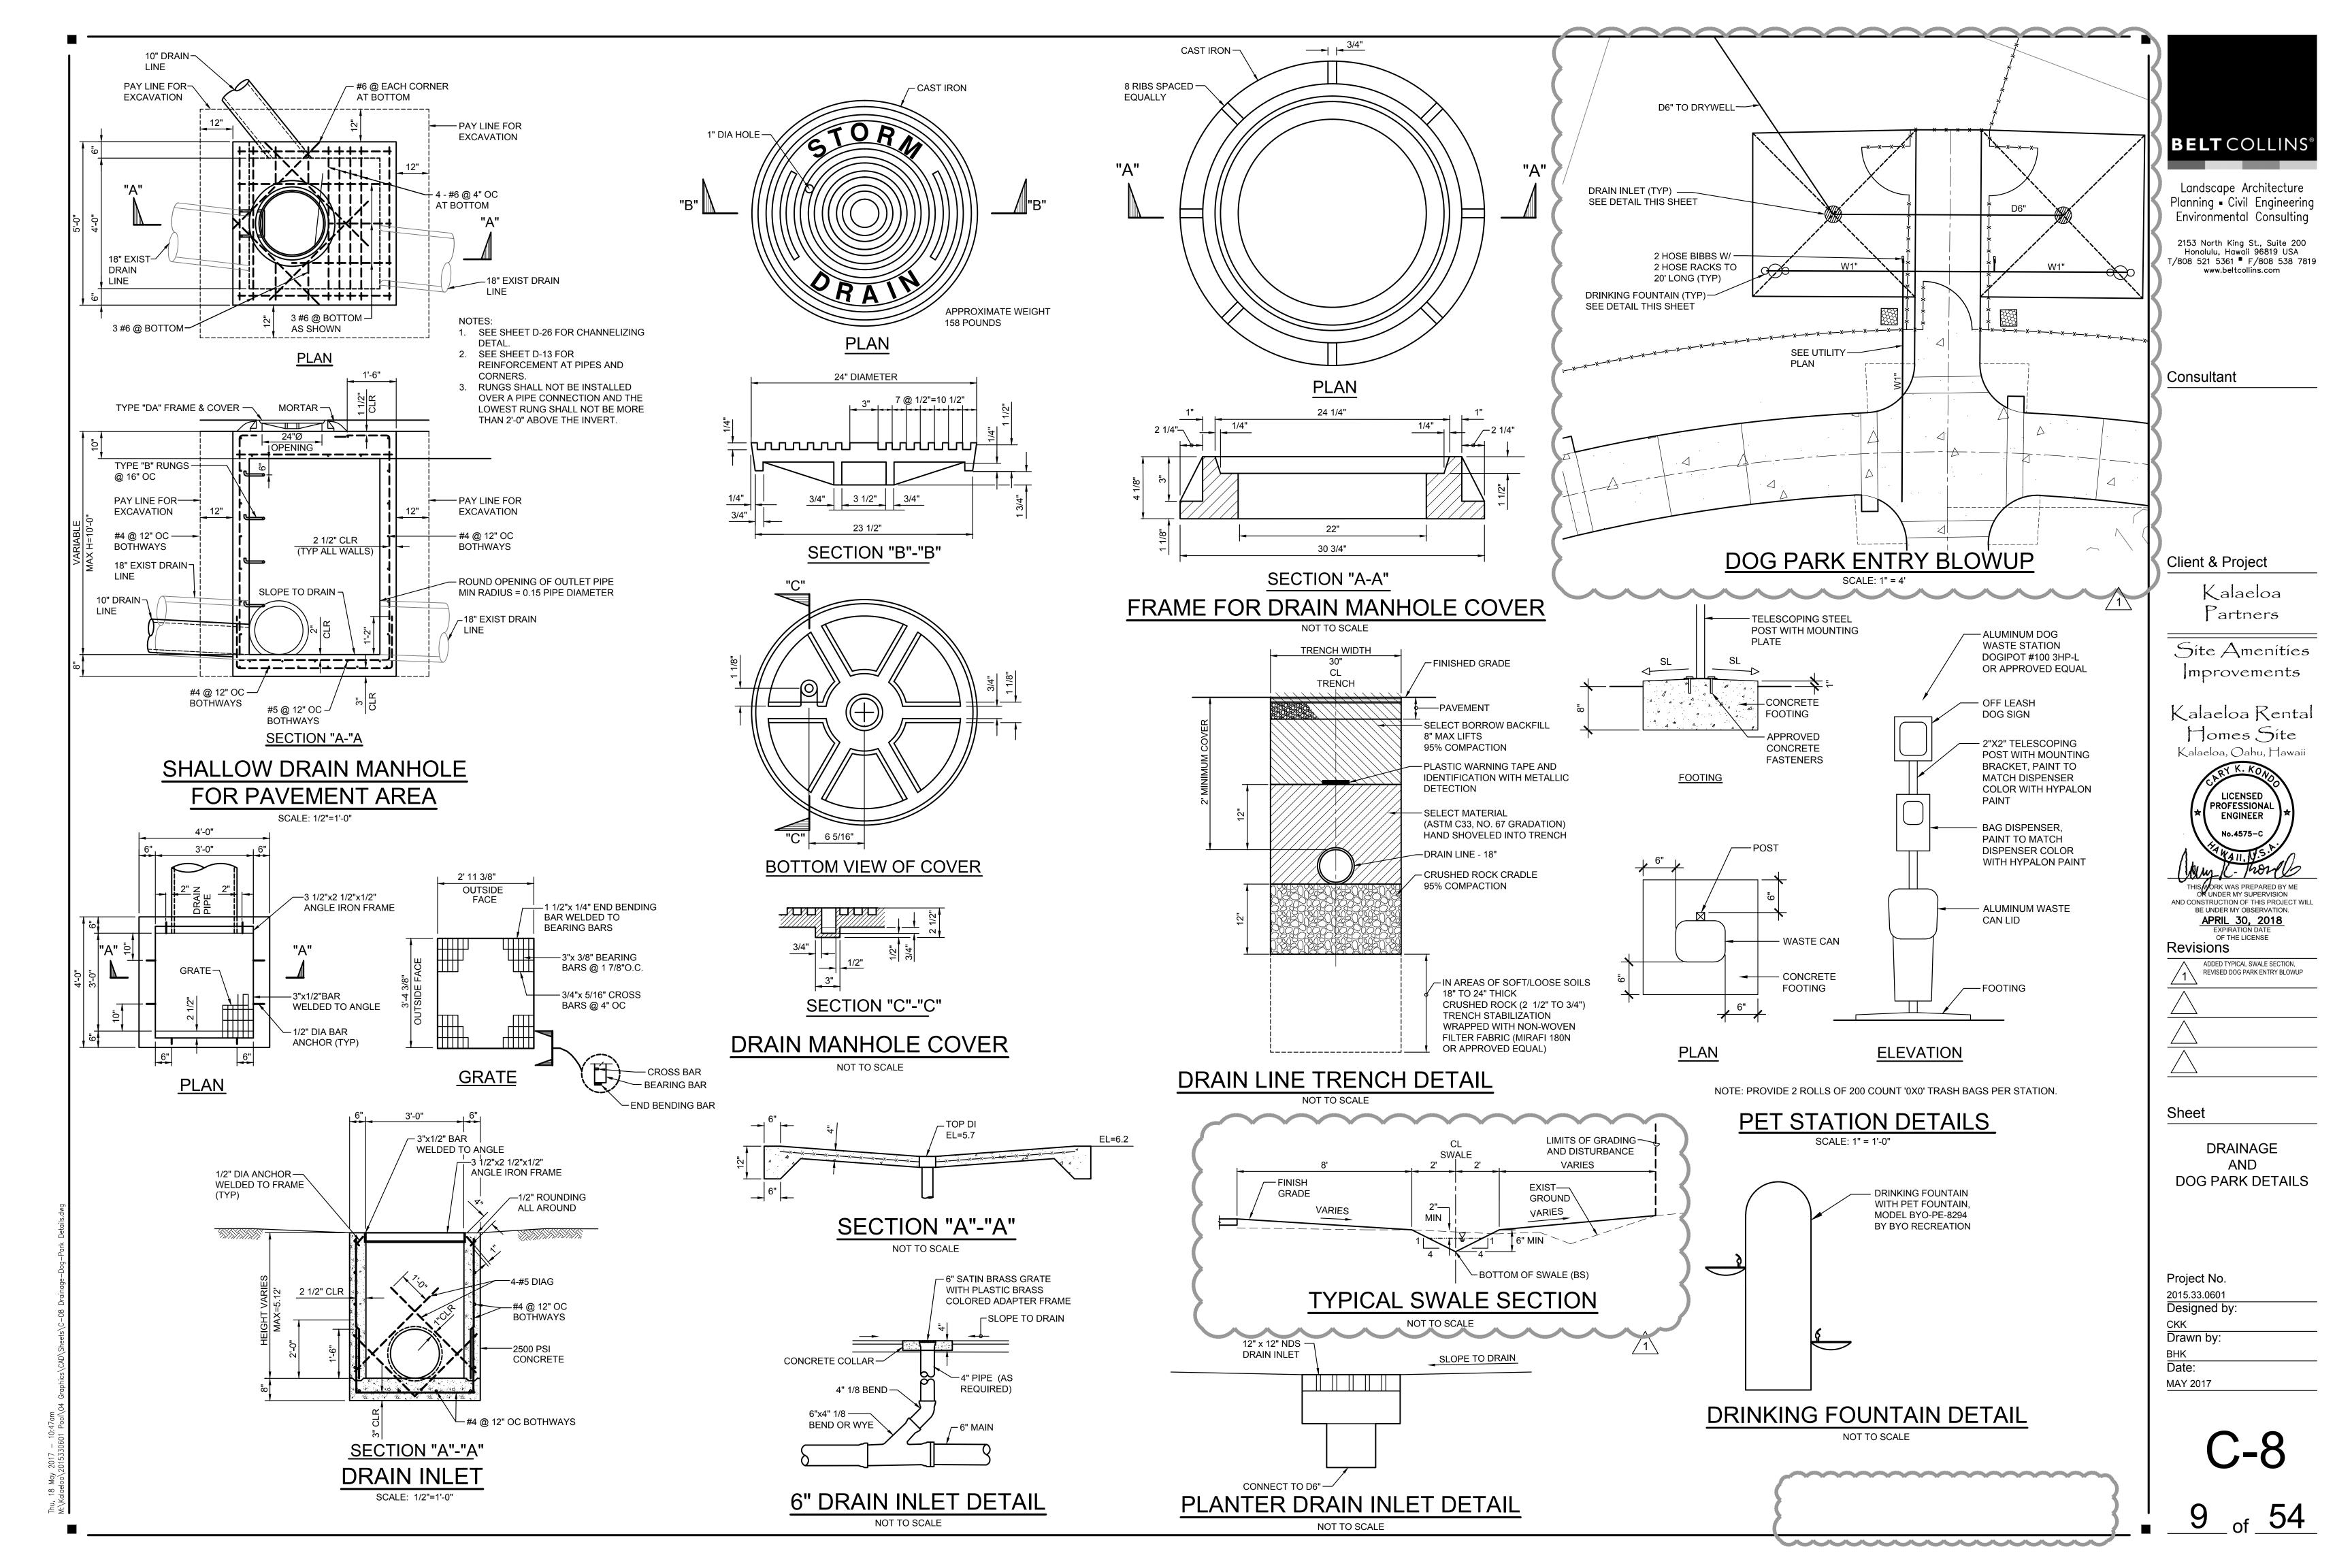
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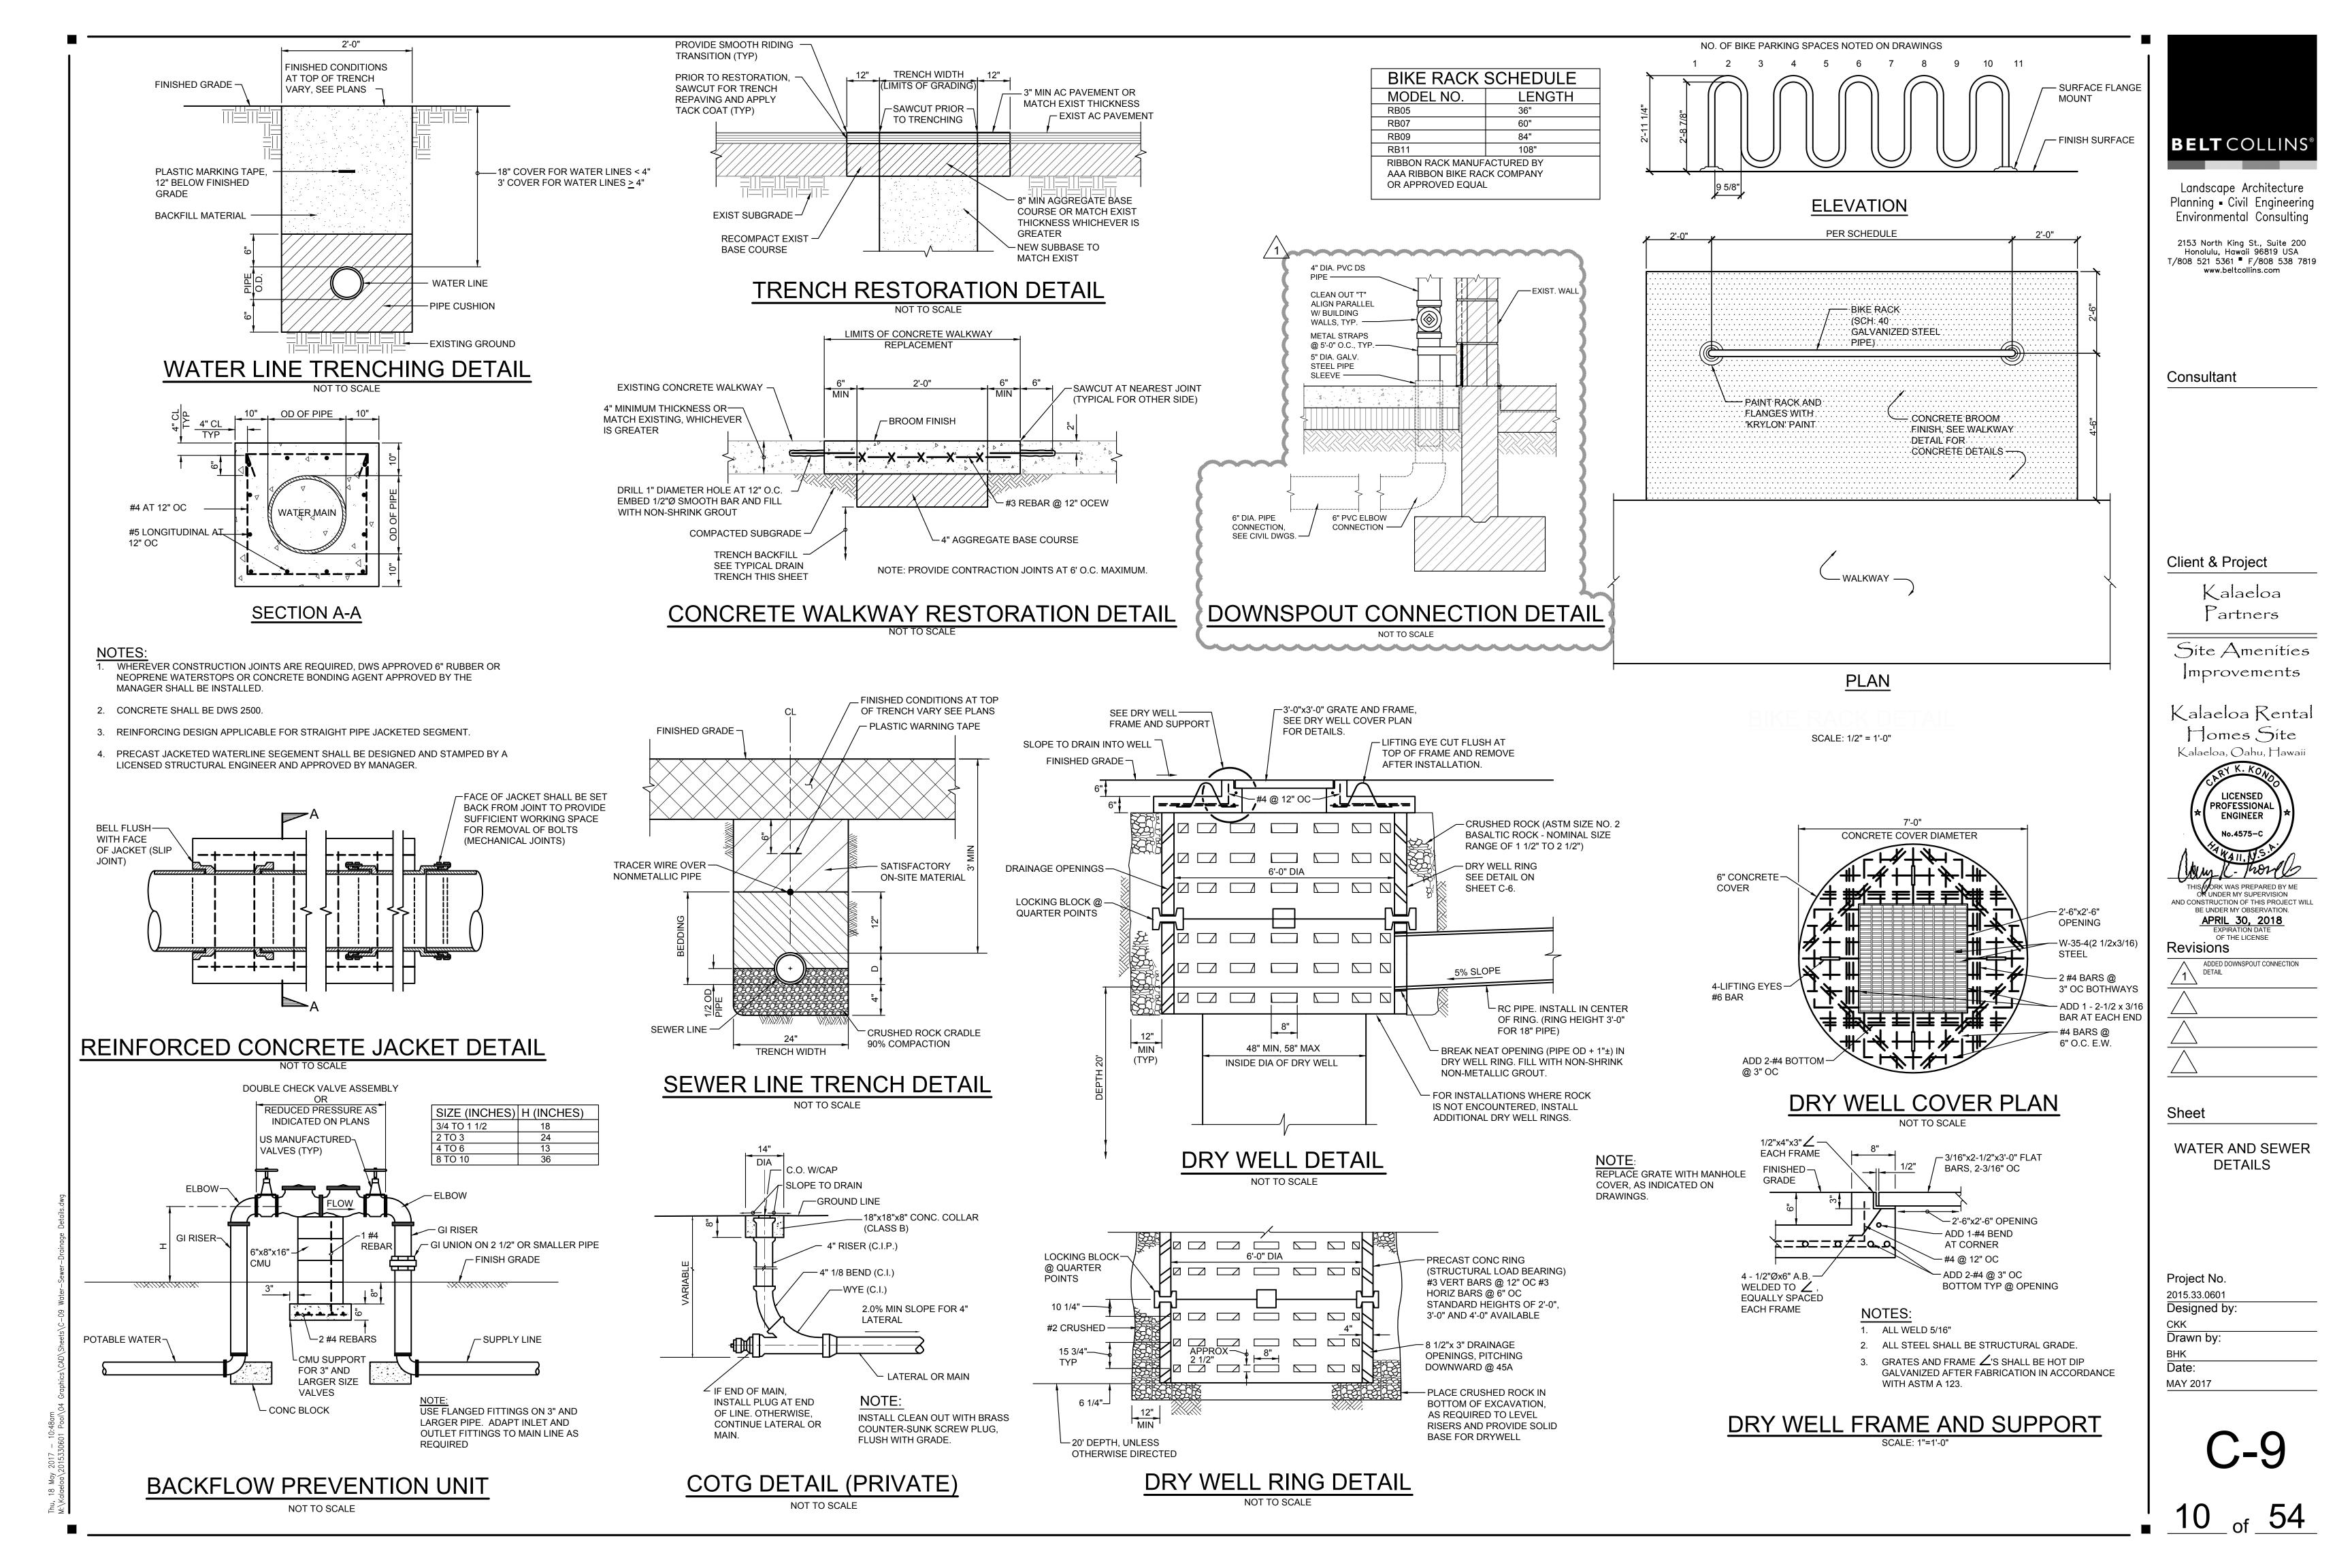
PARKING LOT AND WALKWAY DETAILS

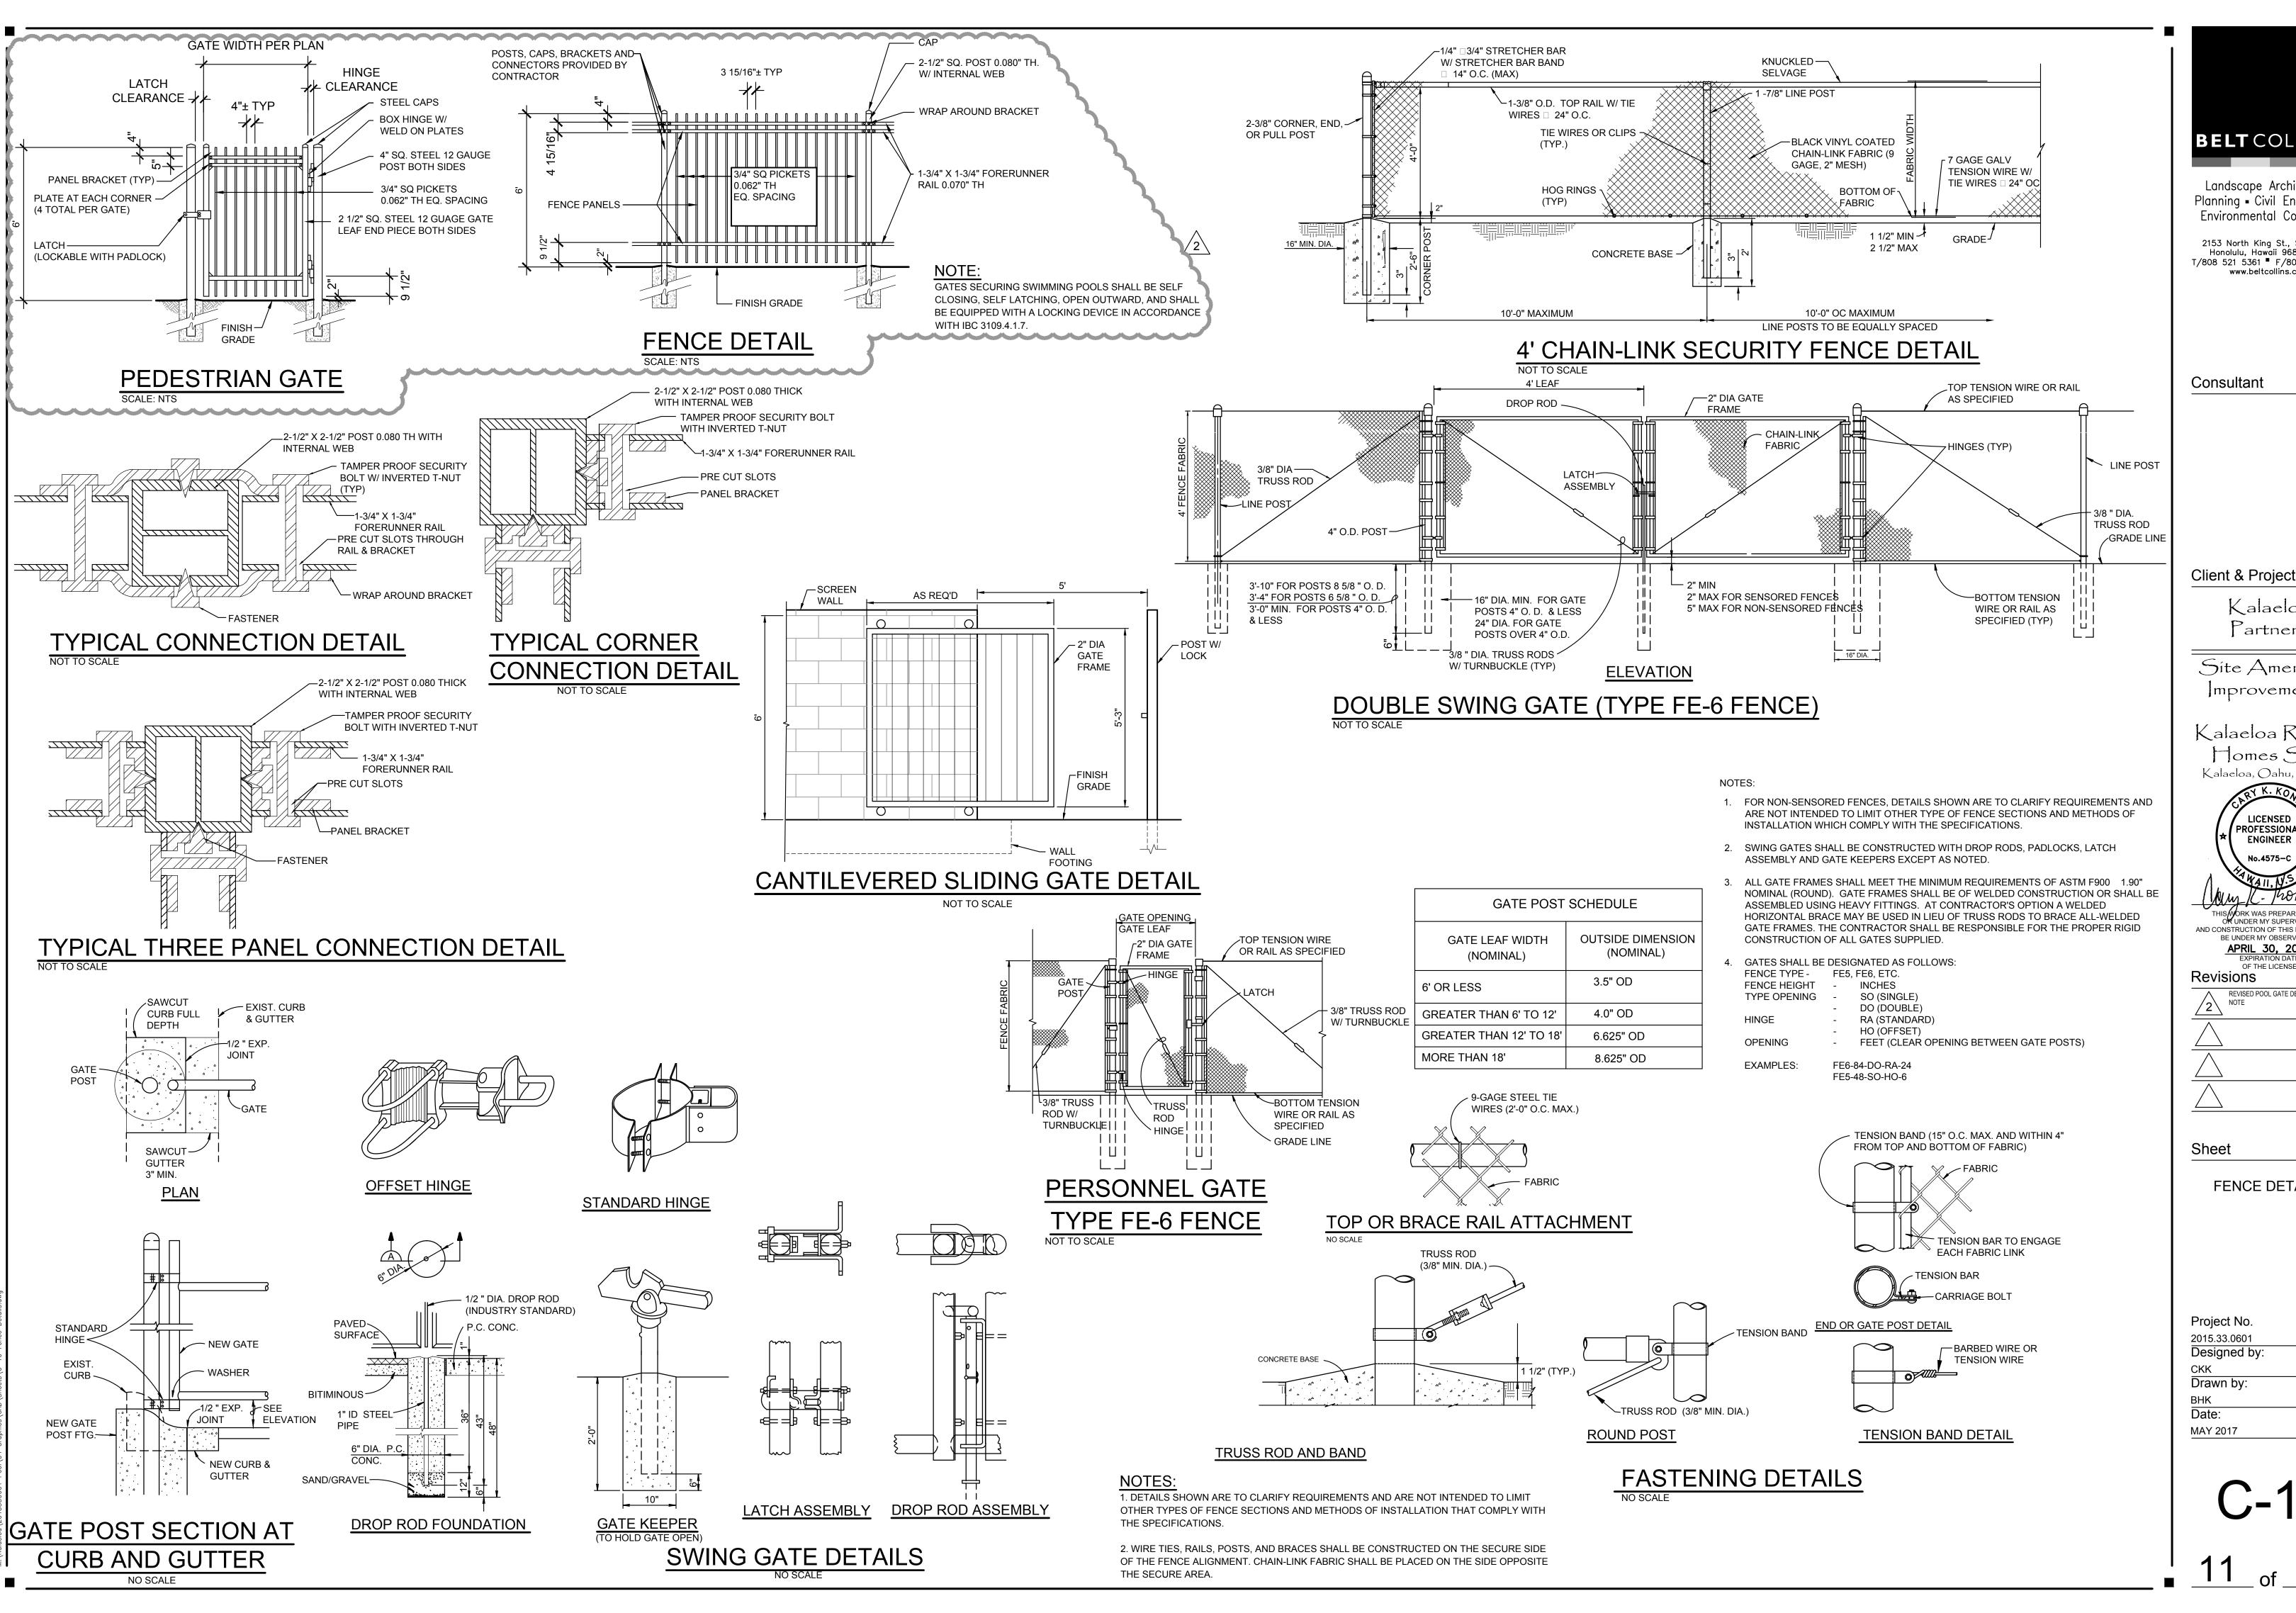
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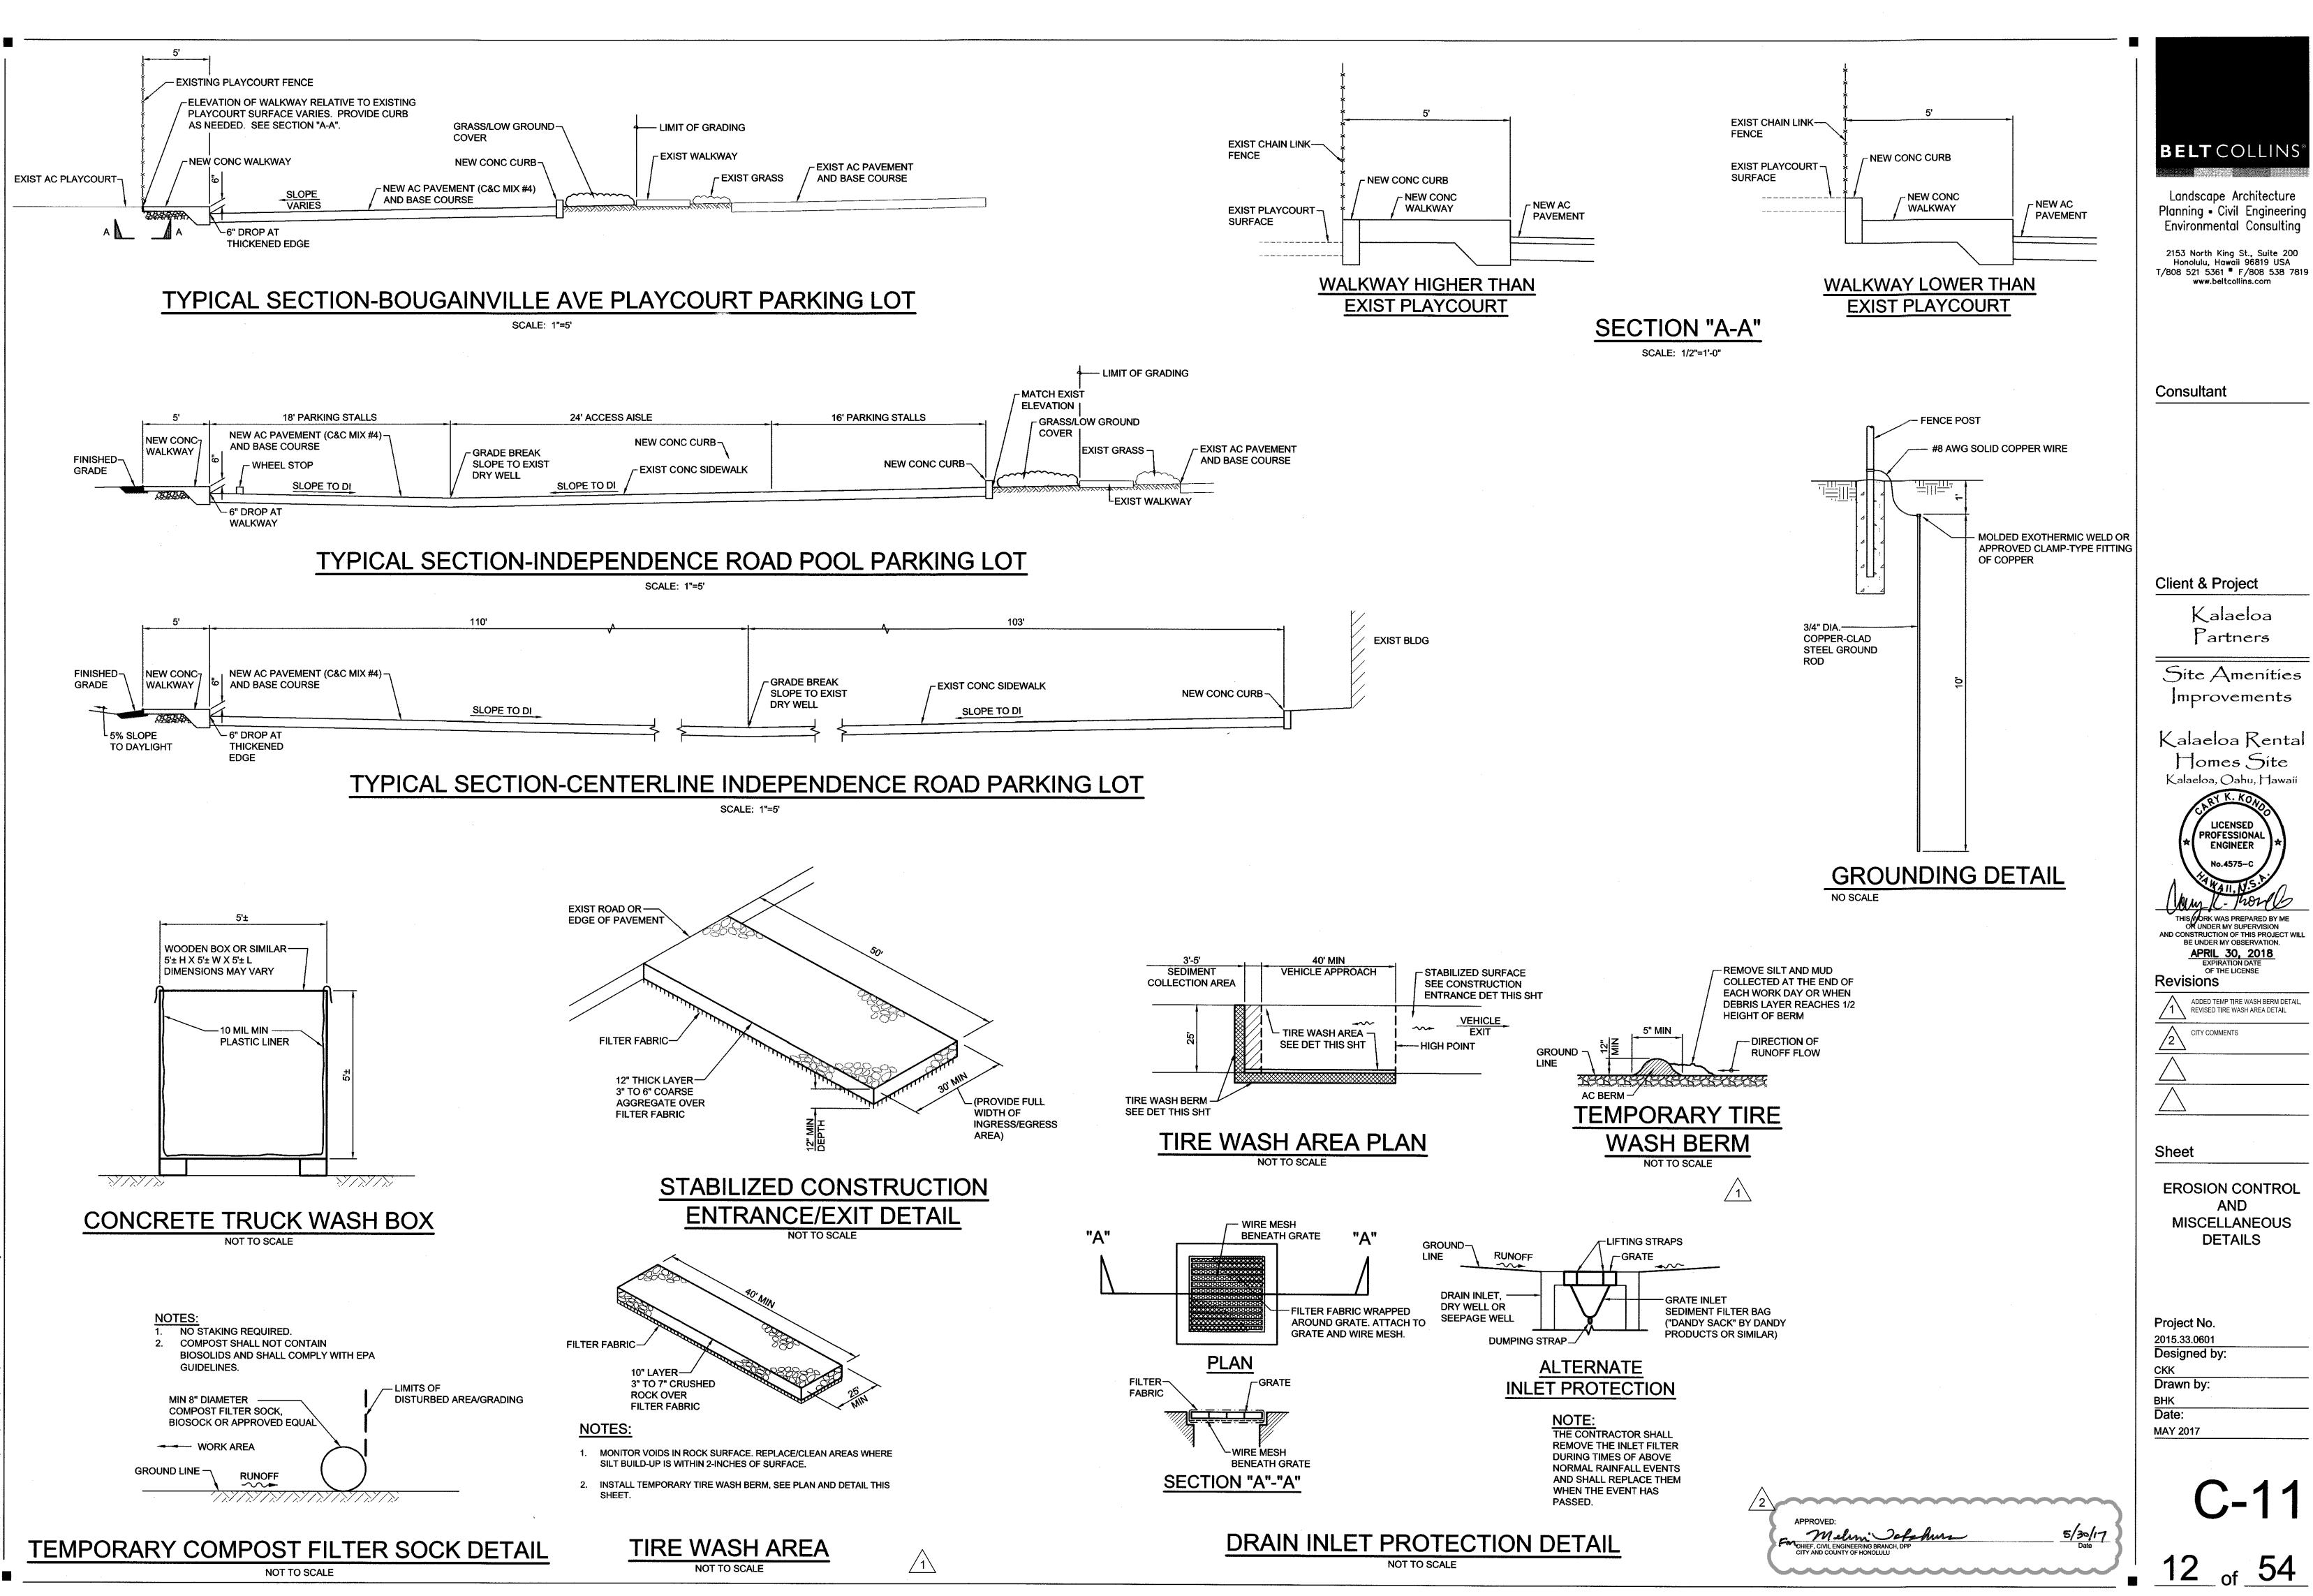
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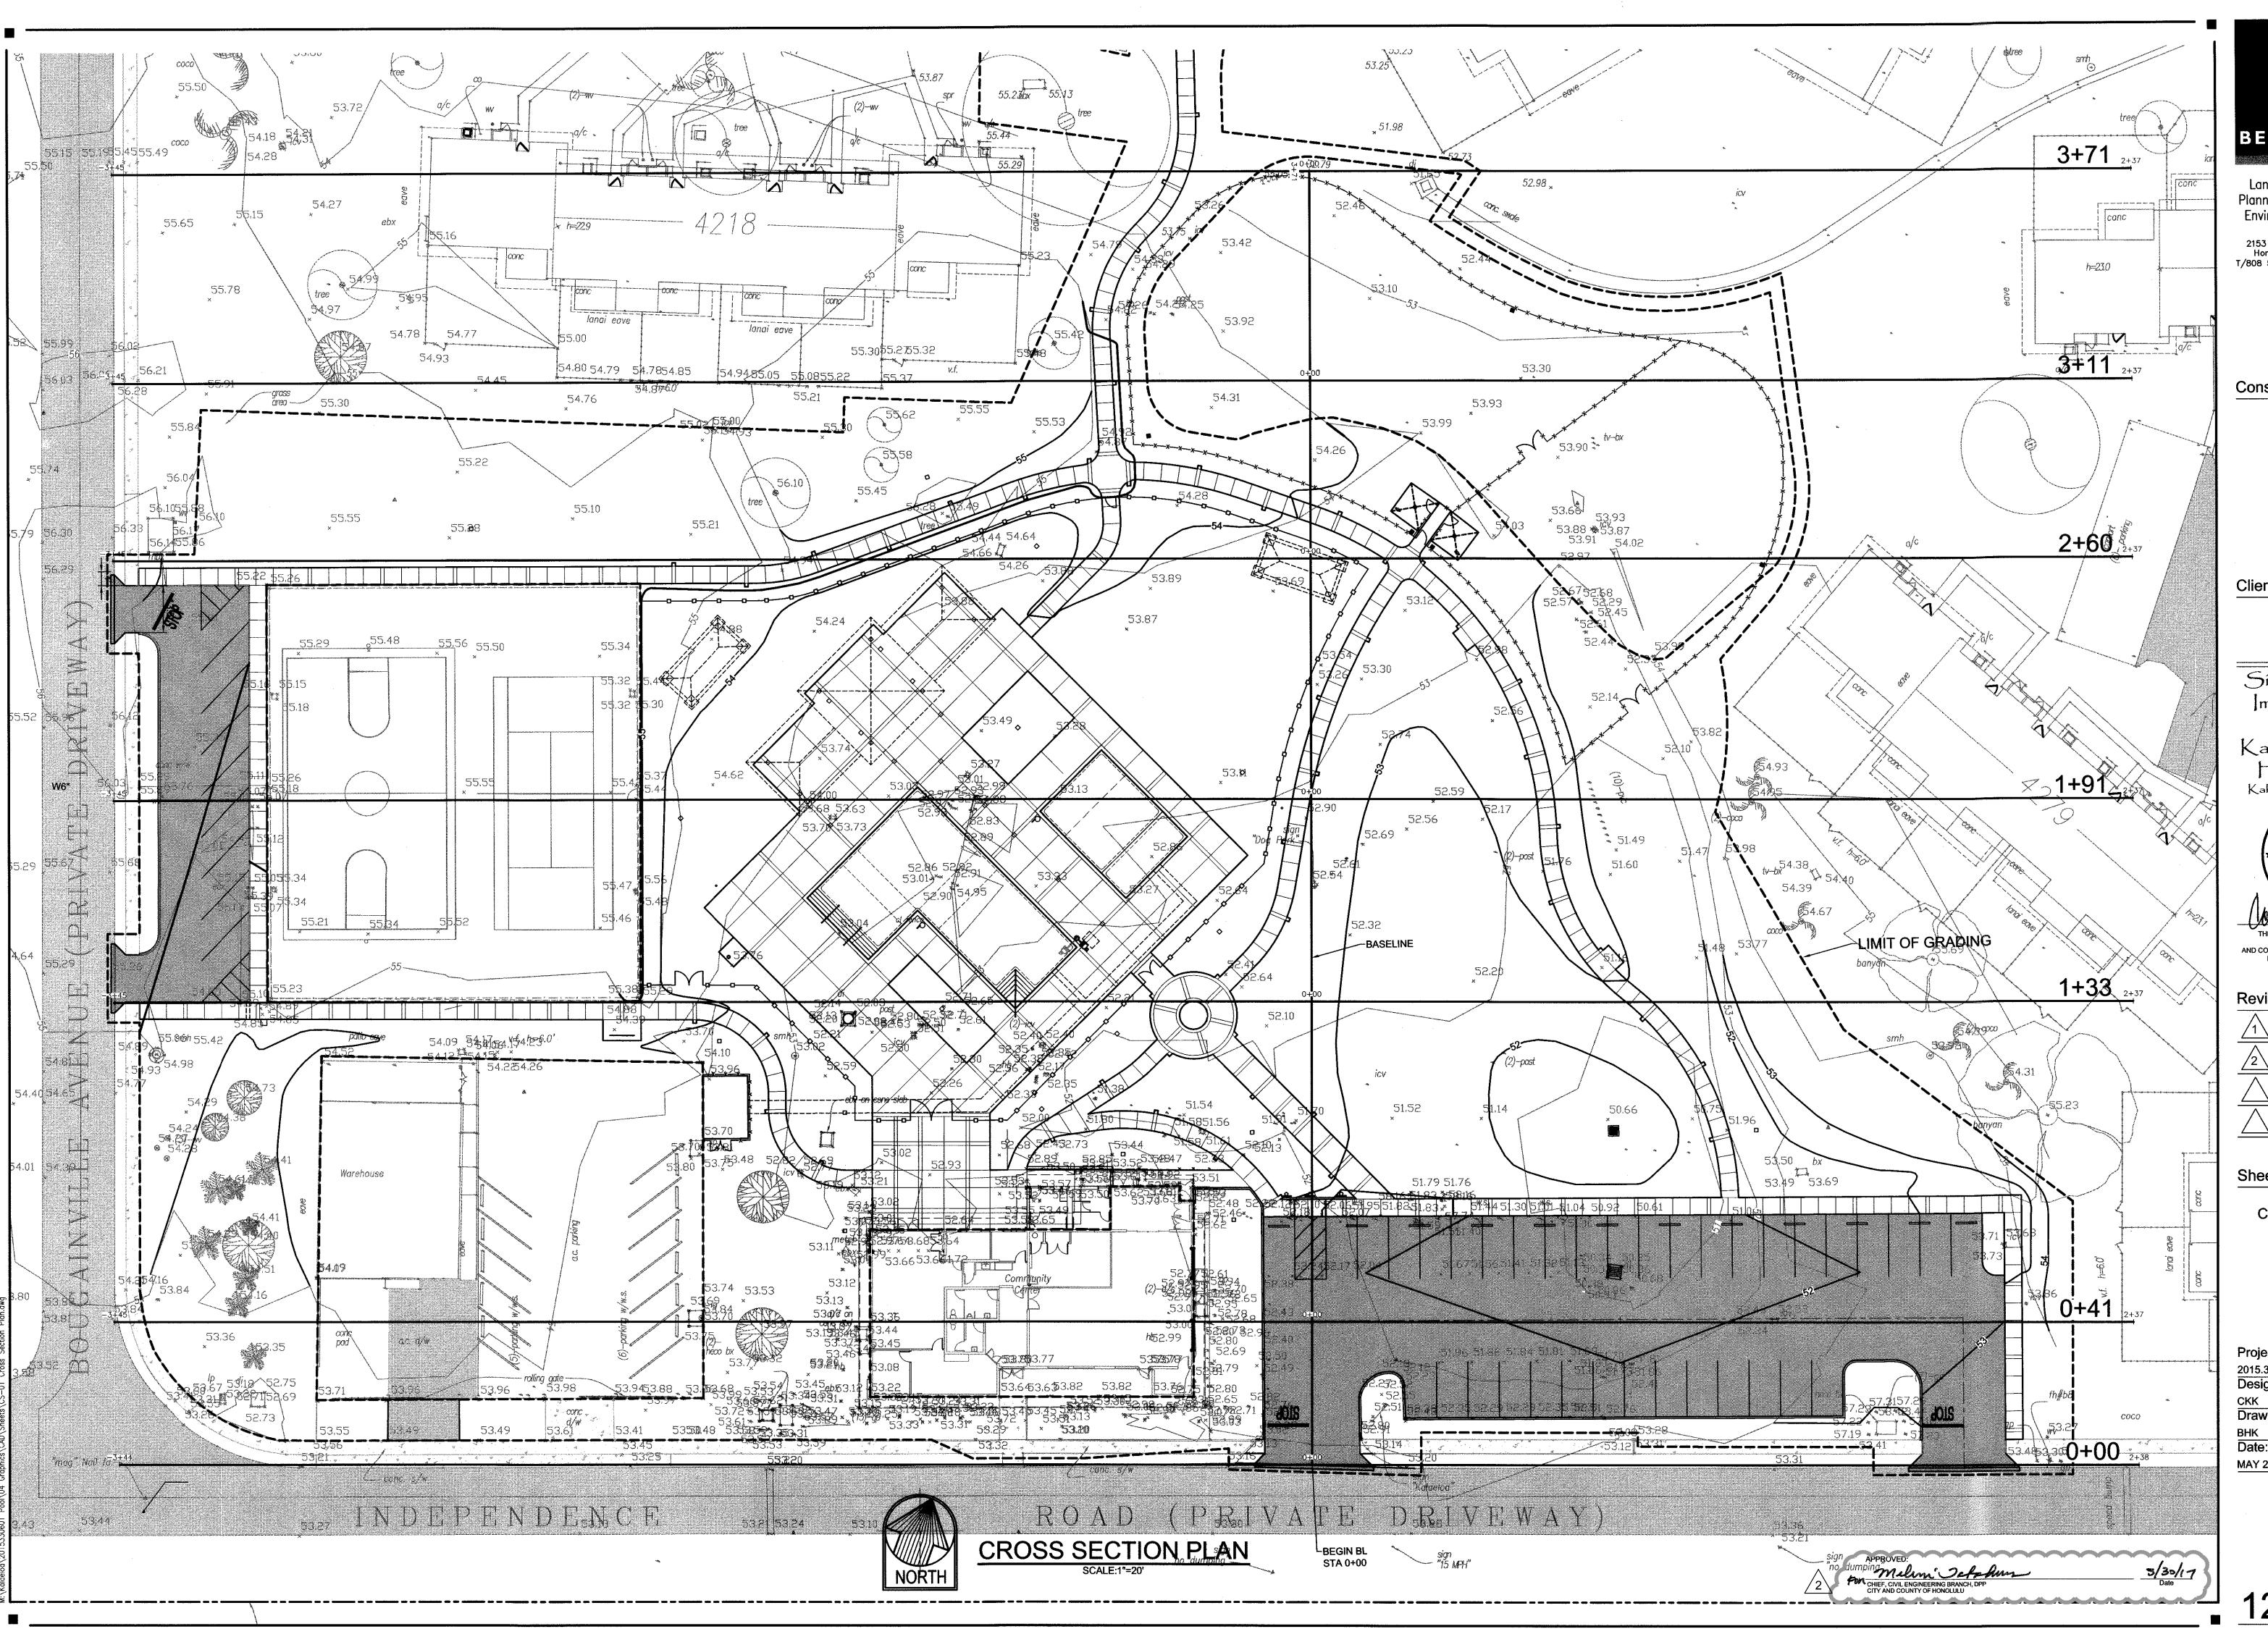
REVISED POOL GATE DETAILS, ADDED

FENCE DETAILS

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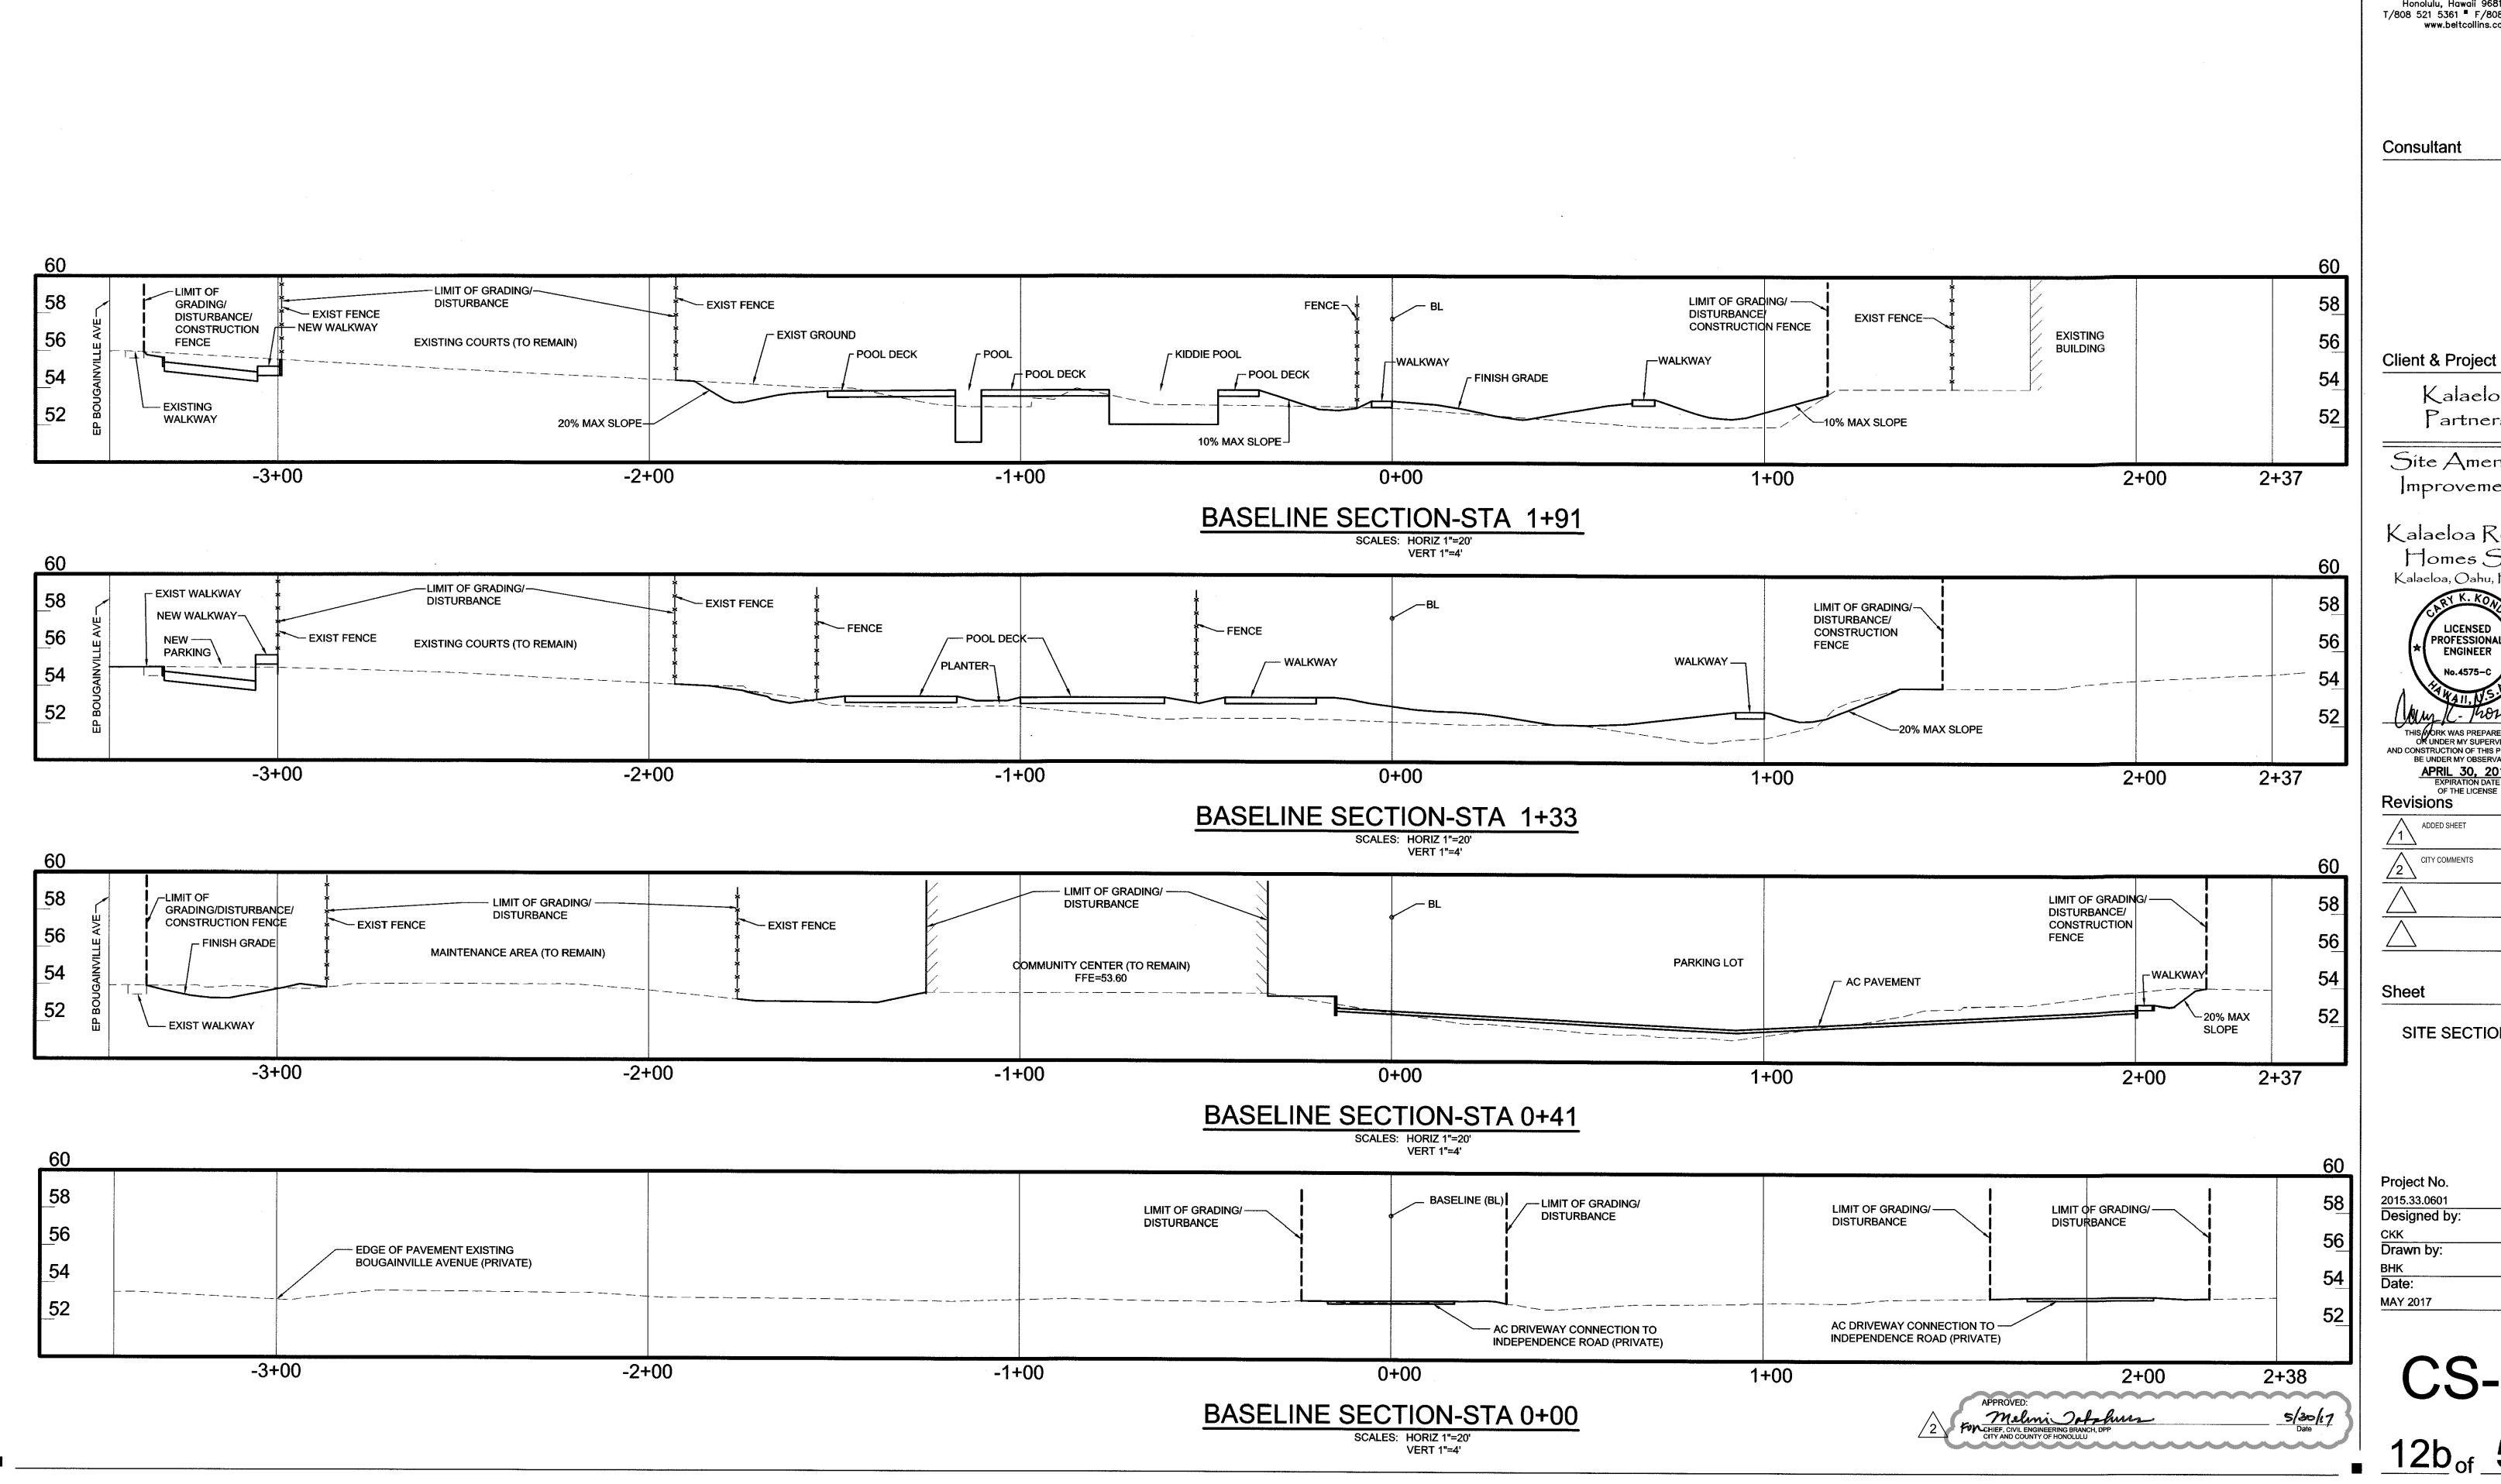
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CROSS SECTION PLAN

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Date: **MAY 2017**



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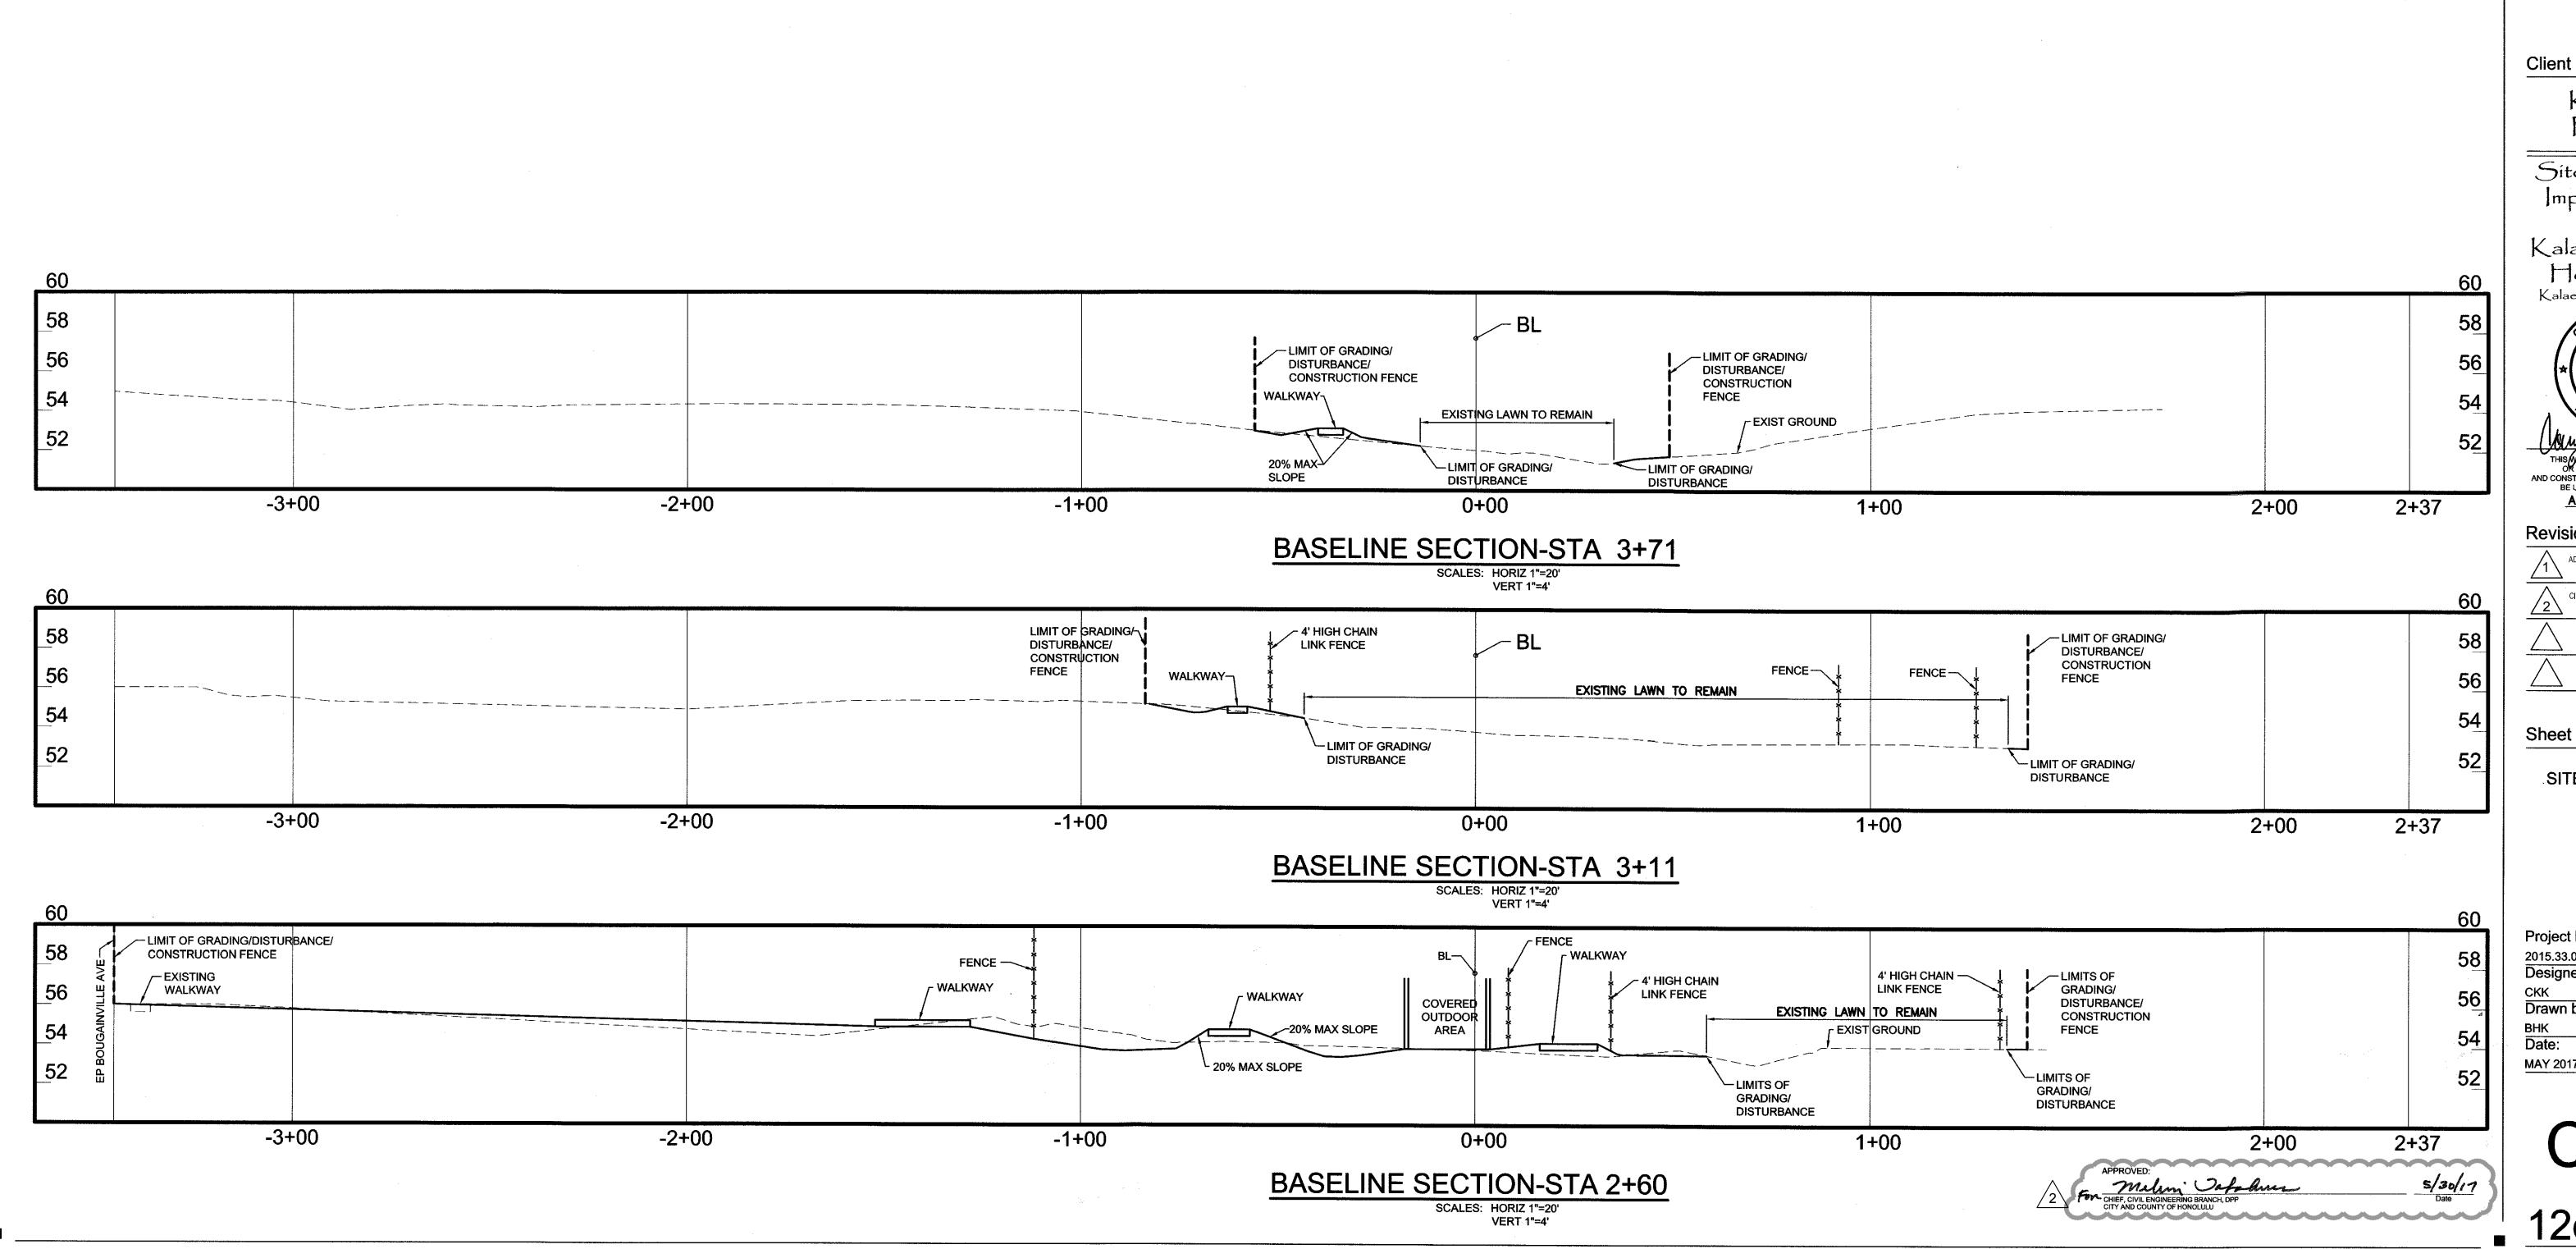
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SITE SECTIONS-1

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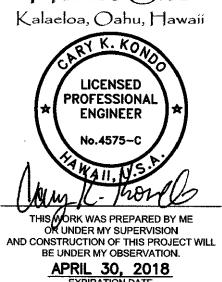
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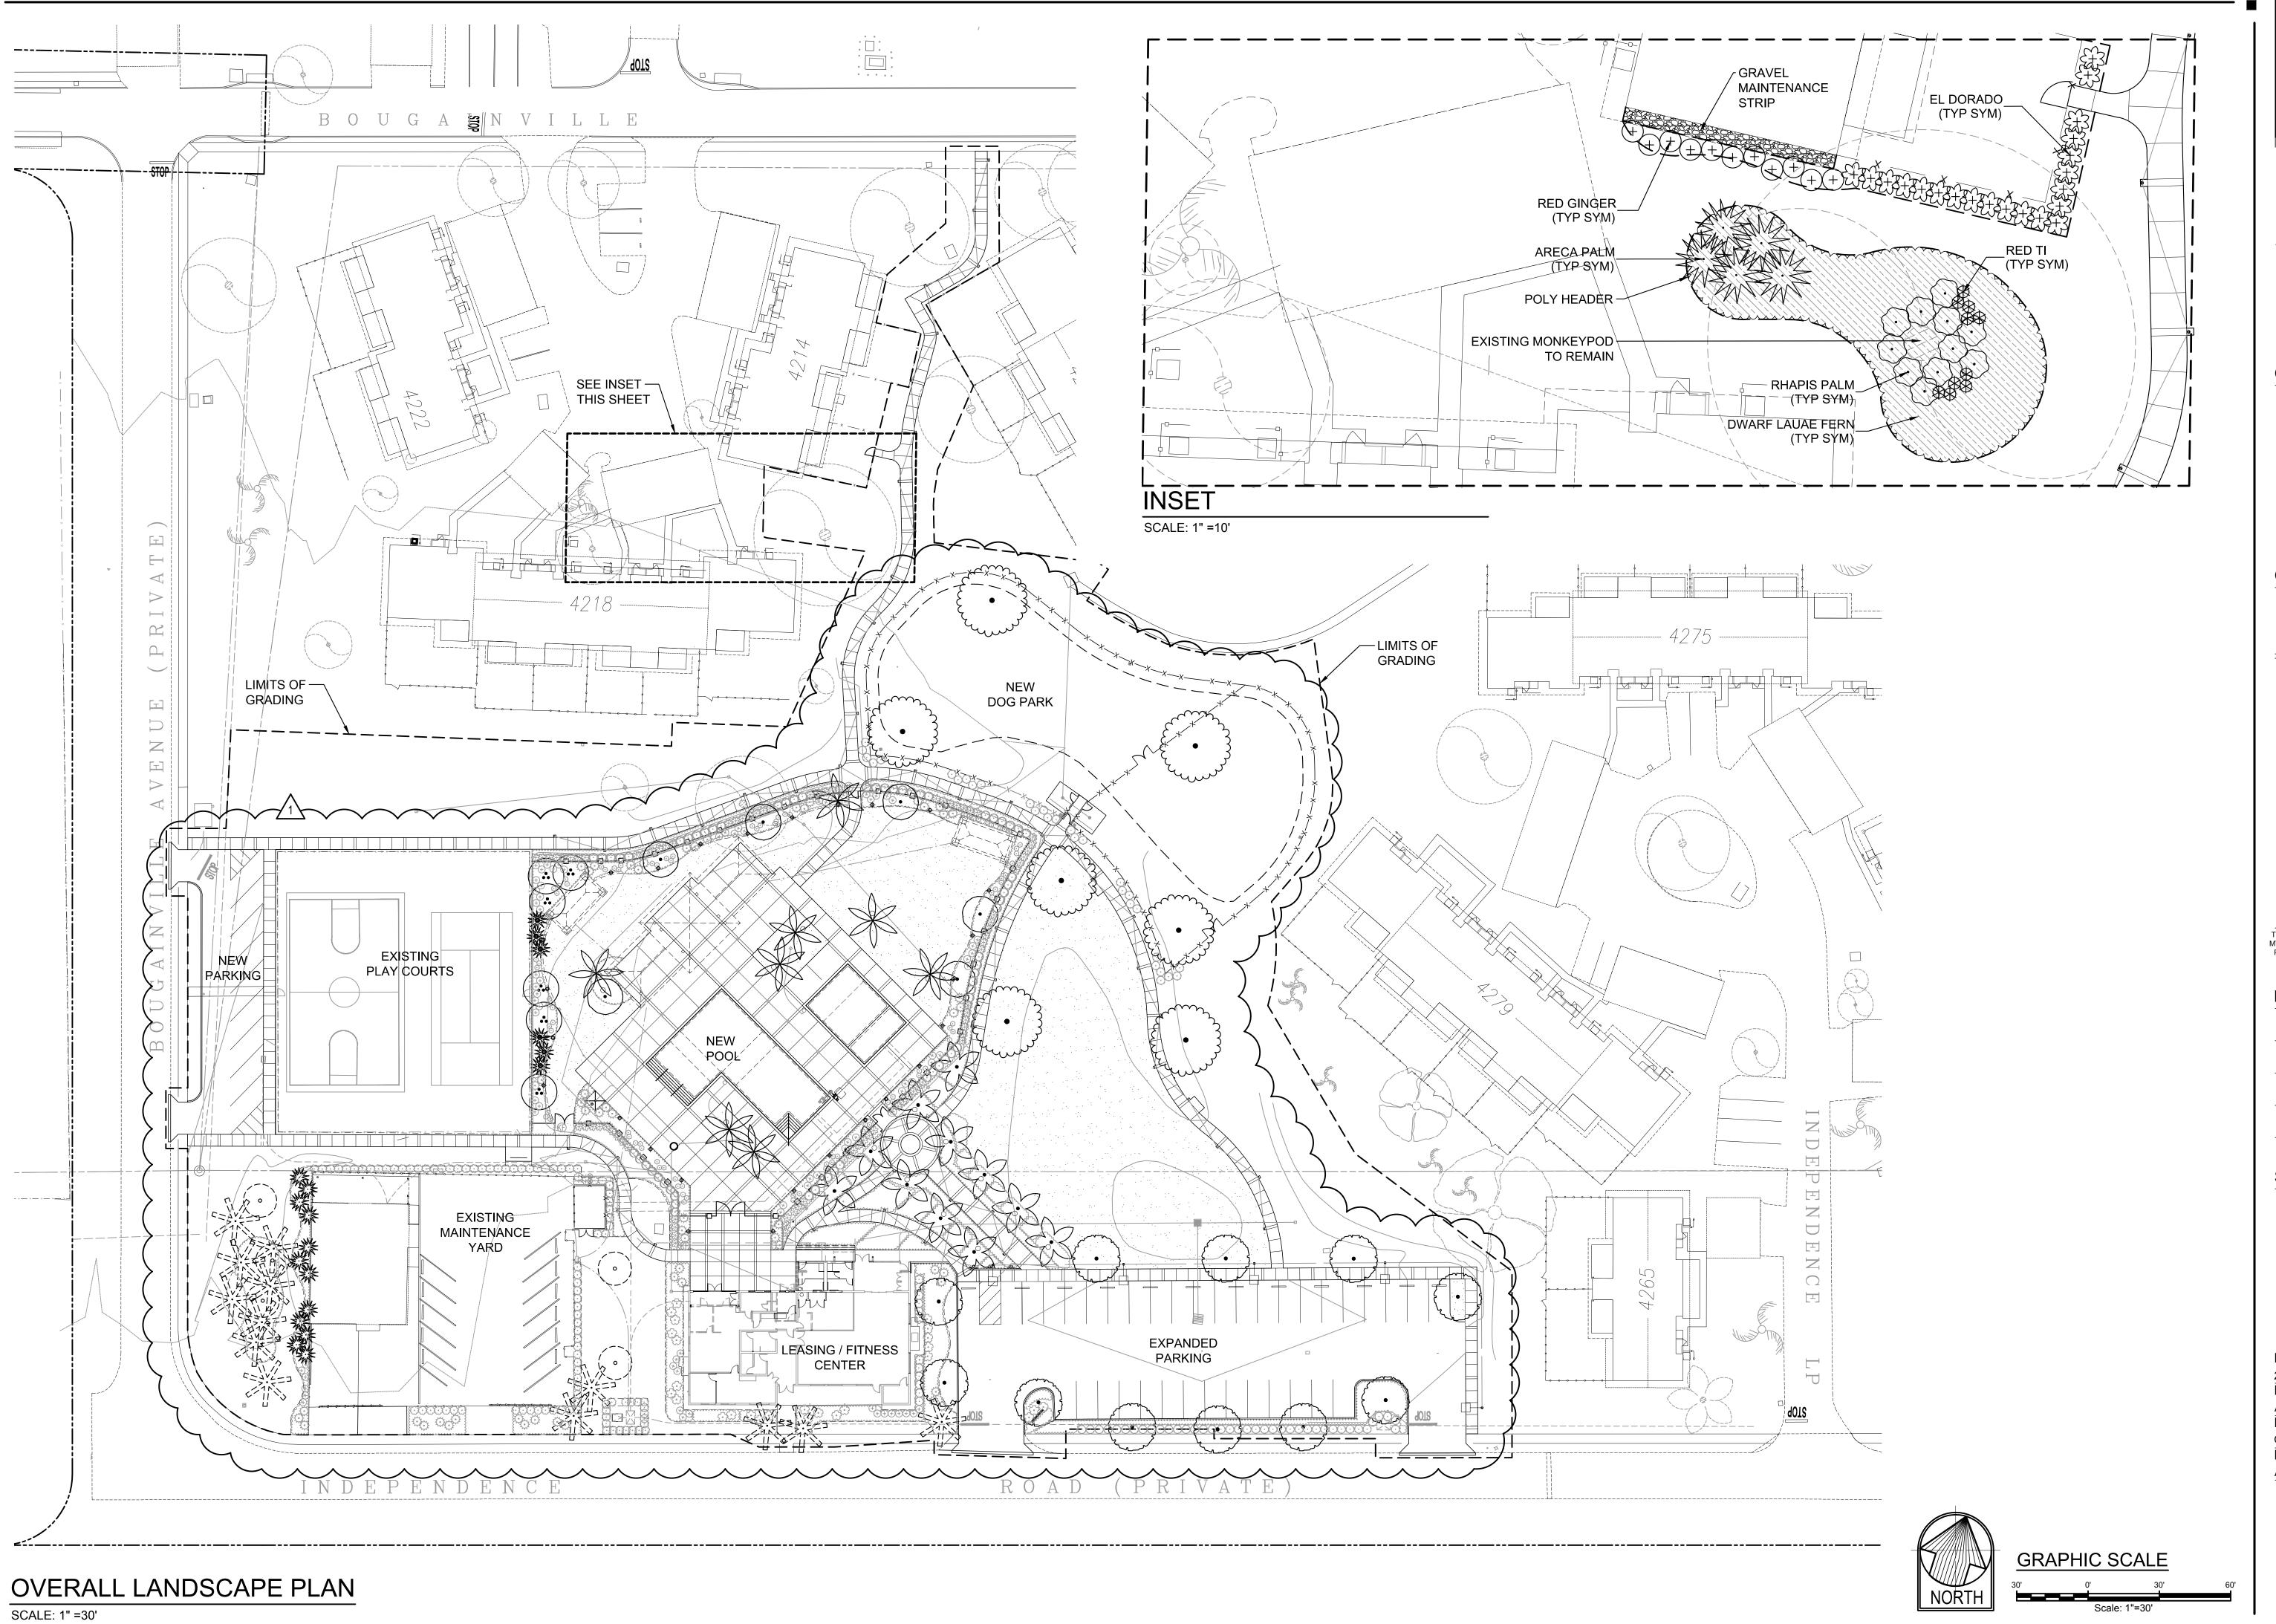


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SITE SECTIONS-2

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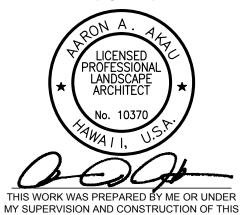
Consultant

Client & Project

Kalaeloa Partners

Site Amenities
Improvements

Kalaeloa Rental Homes Site Kalaeloa, Oahu, Hawaii



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APRIL 30, 2018

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REVISED LANDSCA

Sheet

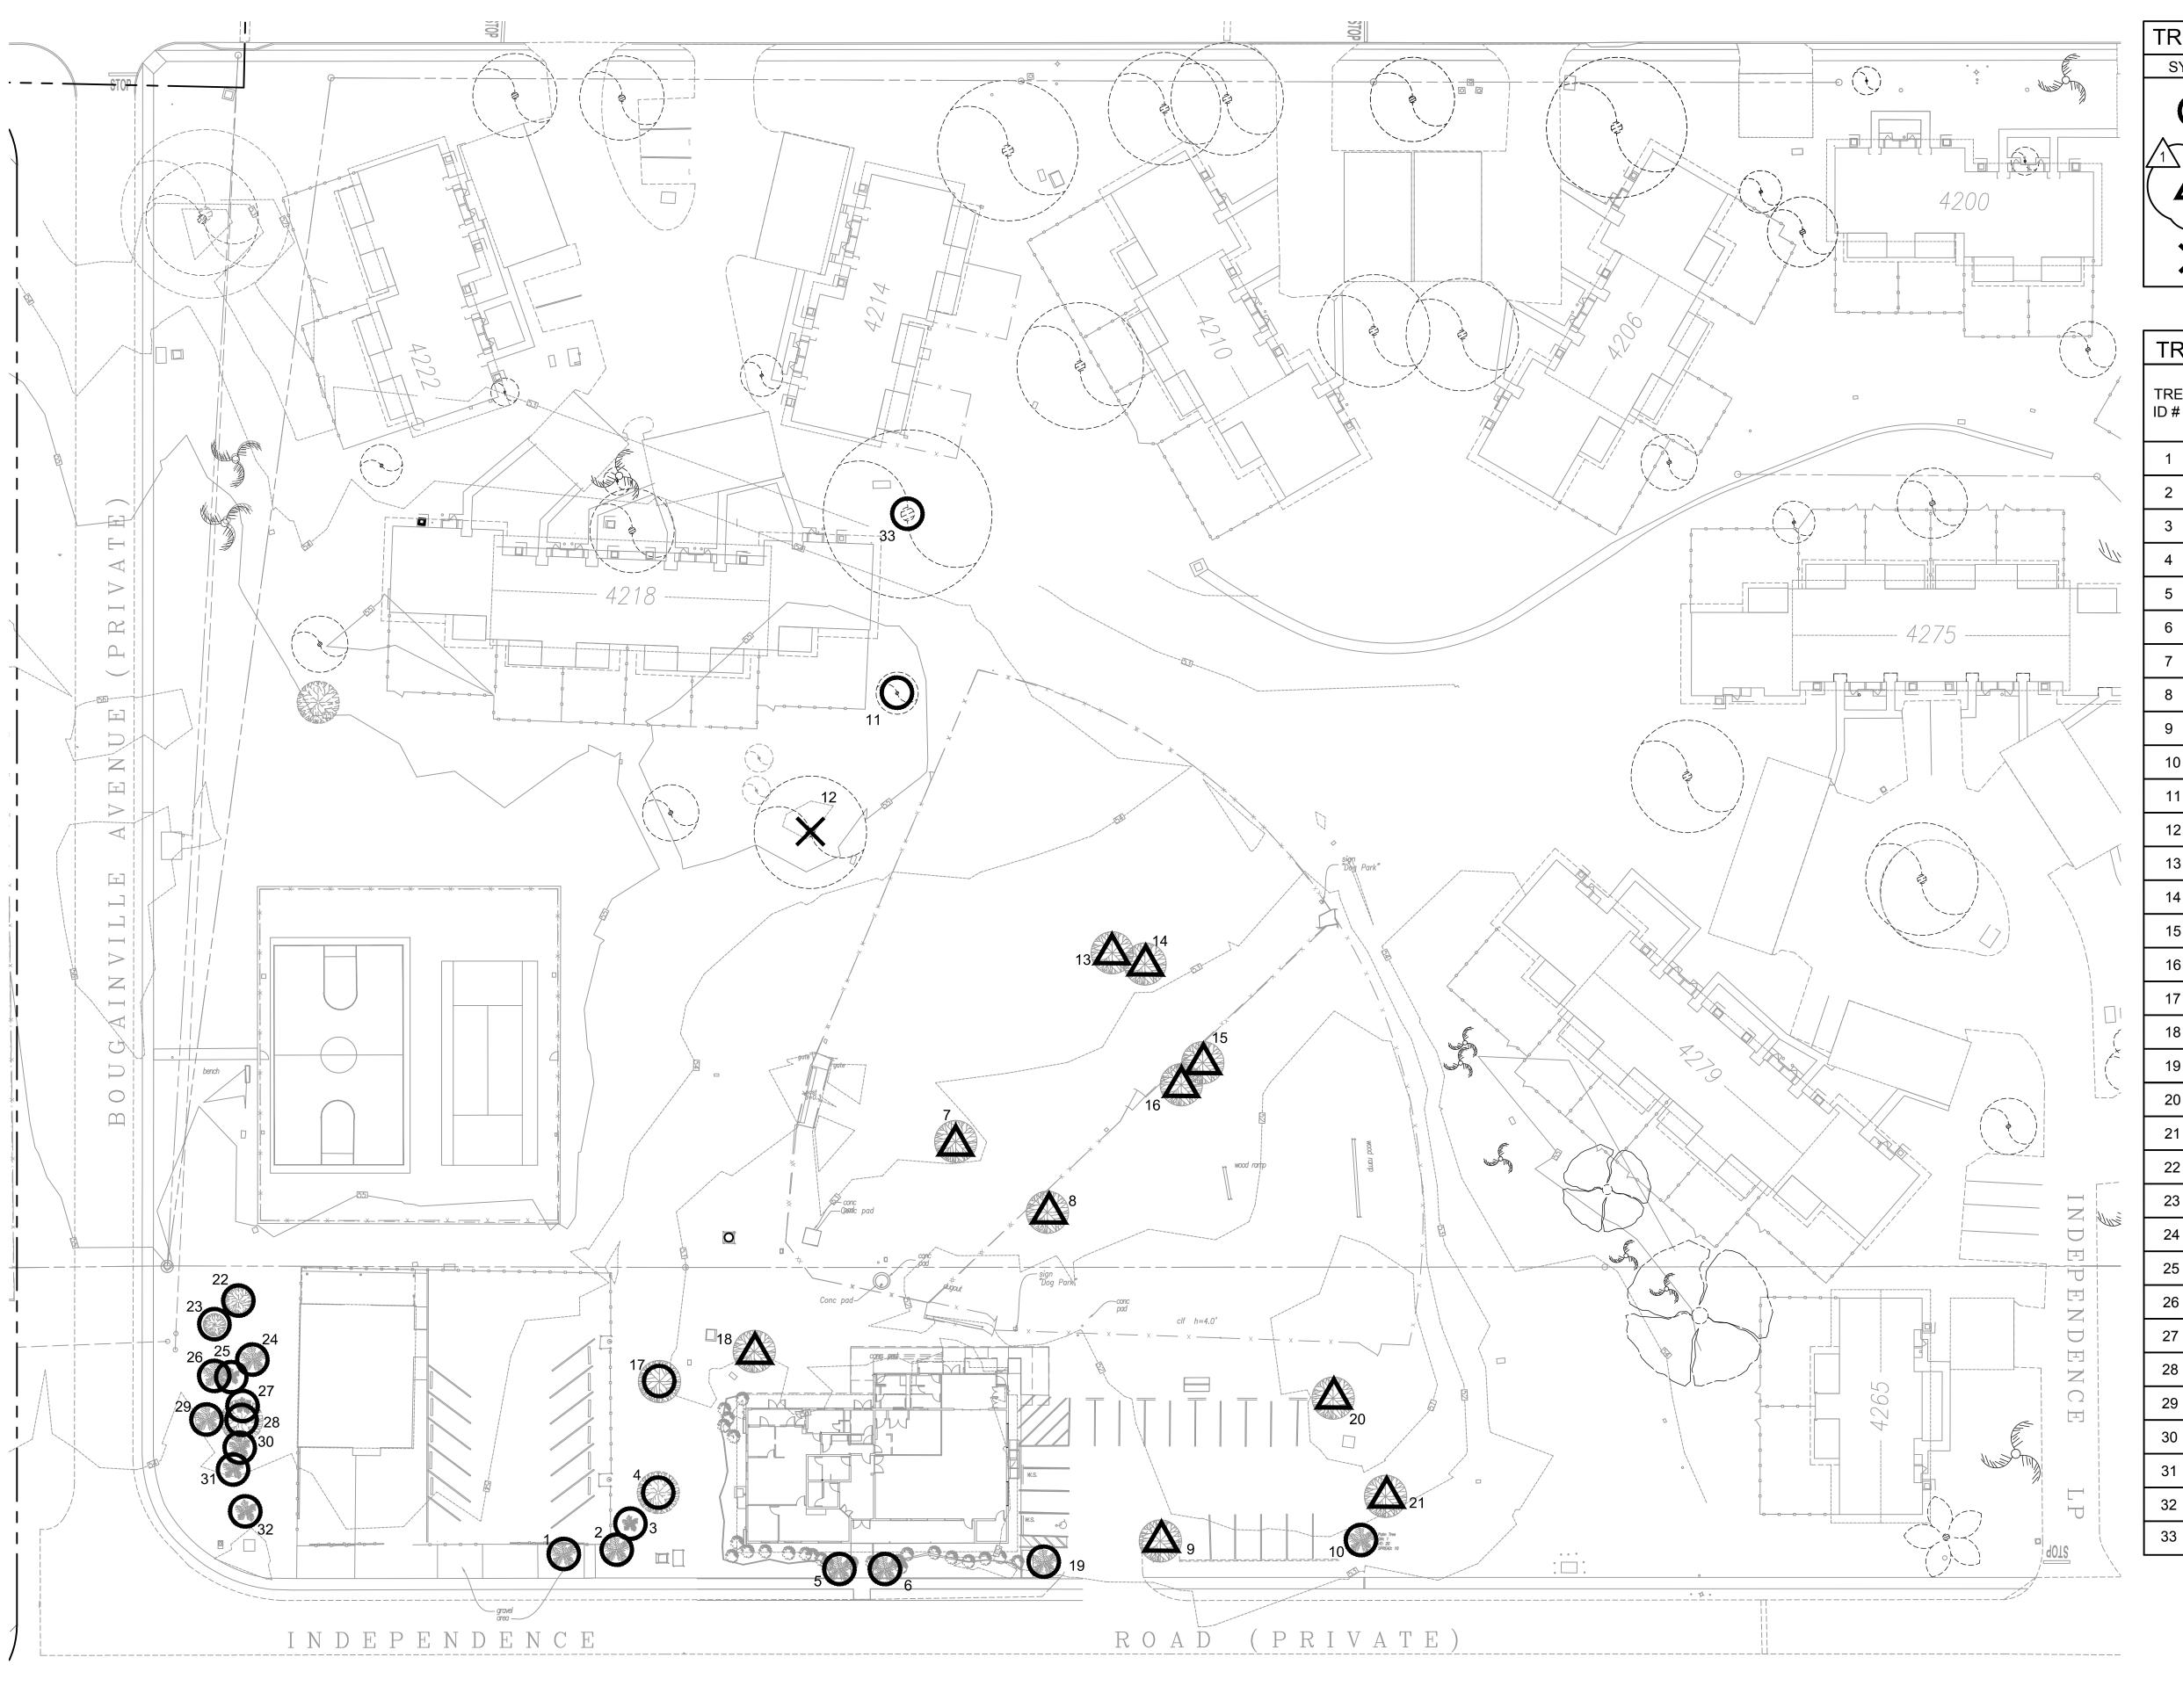
OVERALL LANDSCAPE PLAN

Project No. 2015.33.0601 Designed by:

AA
Drawn by:
CS, RS, CH


Date:
APRIL 2017

L100



<u></u>	TREE DIS	SPOSITION LEGEND
-	SYMBOL	DESCRIPTION
	0	PROTECT IN PLACE (SEE TREE PROTECTION NOTES AND DETAILS)
		SALVAGE AND RELOCATE. OWNER TO DIRECT NEW LOCATION WITHIN MAKAI NEIGHBORHOOD (SEE TREE RELOCATION NOTES AND DETAILS)
	×	REMOVE / DEMOLISH

TRE	E DISPOSITION SCH	EDULE
TREE ID#	COMMON NAME	REMARK
1	PALM	PROTECT IN PLACE
2	PALM	PROTECT IN PLACE
3	MANILA PALM	PROTECT IN PLACE
4	TRUE KOU	PROTECT IN PLACE
5	FOXTAIL PALM	PROTECT IN PLACE
6	FOXTAIL PALM	PROTECT IN PLACE
7	TRUE KOU	SALVAGE AND RELOCATE
8	TRUE KOU	SALVAGE AND RELOCATE
9	HONG KONG ORCHID	SALVAGE AND RELOCATE
10	PALM	PROTECT IN PLACE
11	PLUMERIA	PROTECT IN PLACE
12	MANGO	REMOVE / DEMOLISH
13	TRUE KOU	SALVAGE AND RELOCATE
14	TRUE KOU	SALVAGE AND RELOCATE
15	TRUE KOU	SALVAGE AND RELOCATE
16	TRUE KOU	SALVAGE AND RELOCATE
17	TRUE KOU	PROTECT IN PLACE
18	TRUE KOU	SALVAGE AND RELOCATE
19	FOXTAIL PALM	PROTECT IN PLACE
20	HONG KONG ORCHID	SALVAGE AND RELOCATE
21	HONG KONG ORCHID	SALVAGE AND RELOCATE
22	TRUE KOU	PROTECT IN PLACE
23	TRUE KOU	PROTECT IN PLACE
24	MANILA PALM	PROTECT IN PLACE
25	PALM	PROTECT IN PLACE
26	PALM	PROTECT IN PLACE
27	PALM	PROTECT IN PLACE
28	TRUE KOU	PROTECT IN PLACE
29	PALM	PROTECT IN PLACE
30	PALM	PROTECT IN PLACE
31	PALM	PROTECT IN PLACE
32	PALM	PROTECT IN PLACE
33	MONKEYPOD	PROTECT IN PLACE

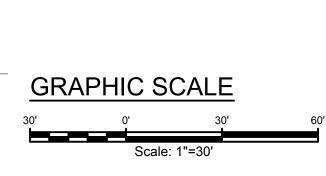

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REVISED TREE
DISPOSITION LEGEND

Sheet

TREE
DISPOSITION
PLAN AND
SCHEDULE

Project No. 2015.33.0601 Designed by:


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APRIL 2017

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NOTES:

- 1. FOR TREES THAT ARE IN NARROW PLANTING STRIPS. THE ENTIRE PLANTING STRIP SHALL BE ENCLOSED.
- 2. FOR TREE WELLS AND SMALL PLANTER AREAS THAT ARE FULL OF ROOTS, USE PLASTIC TRAFFIC BARRICADES (WATER FILLABLE) MINIMUM (3) EACH, OR TYPE 1 OR TYPE 2 TRAFFIC BARRICADES, MINIMUM FOUR (4) EACH, OR AS DETERMINED BY THE OWNERS REPRESENTATIVE.
- 3. IF THE FENCE IS INSIDE THE DRIP LINE, LAY PLYWOOD SHEETS, STEEL PLATES OR HEAVY DUTY GROUND PROTECTION MATS OVER AN 8" MULCH LAYER TO PROTECT THE TREE ROOTS AND GROUND FROM DAMAGE, SOIL COMPACTION AND EROSION FROM CONSTRUCTION EQUIPMENT AND VEHICLES. AVOID DAMAGING ROOTS DURING FENCE POST INSTALLATION.
- 4. POSTS: 2" SQUARE GALVANIZED STEEL POSTS, DRIVEN INTO THE GROUND TO MIN. 2' DEPTH, AT NO MORE THAN 10' SPACING.
- 5. SCHEDULE AN ON SITE MEETING WITH THE OWNERS REPRESENTATIVE TO DISCUSS THE INSTALLATION AND LAYOUT OF THE TREE PROTECTION FENCING.



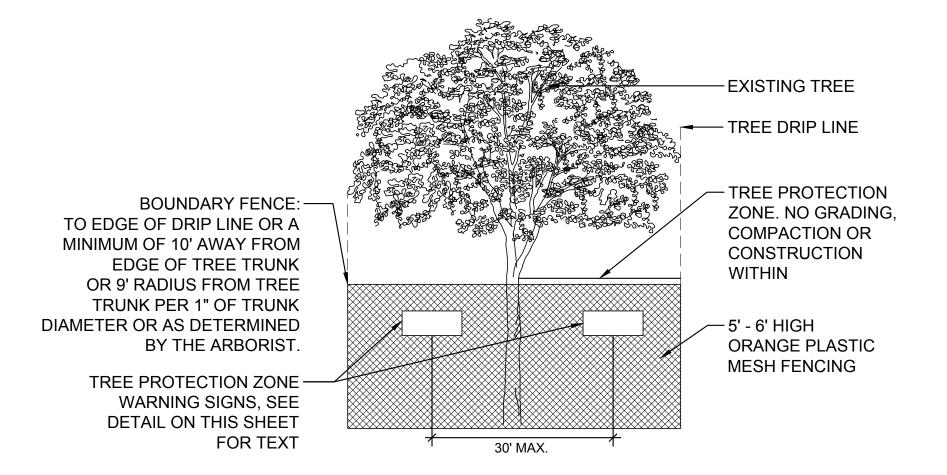— WHITE PLASTIC LAMINATED CARDBOARD BACKGROUND RED COPY WARNING

TREE PROTECTION ZONE

THIS FENCE AND SIGN SHALL NOT BE REMOVED WITHOUT APPROVAL FROM THE OWNER'S REPRESENTATIVE

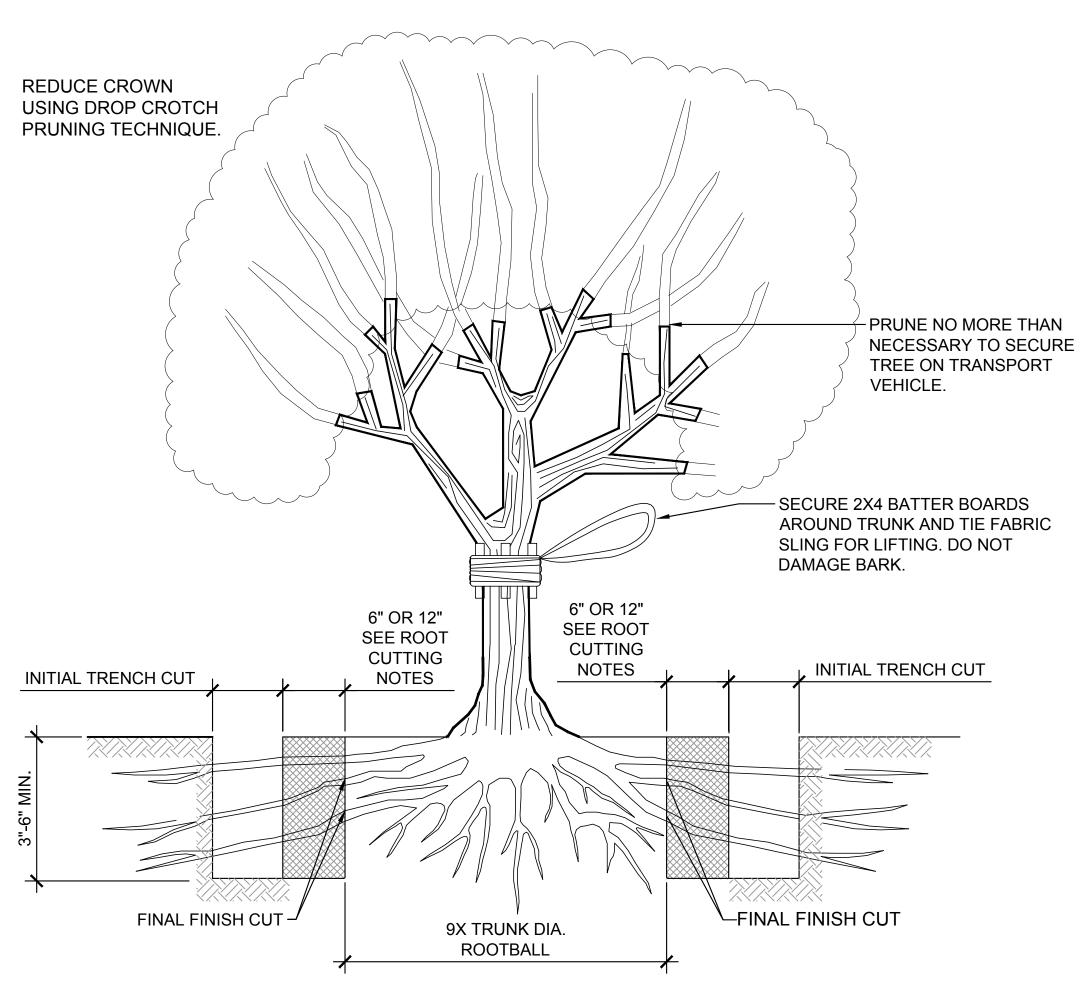
SPDII MAKAIWA RESORT DEVELOPMENT, LLC

- MINIMUM SIZE OF SIGNS: 8-1/2" X 11".
- 2. SECURELY FASTEN TO FENCE.
- 3. PROVIDE SIGNAGE 30' O.C. SPACING MAX. 4. SIGNS TO BE LAMINATED WITH HEAVY PLASTIC.

TREE PROTECTION ZONE WARNING SIGN

TREE PROTECTION ZONE FENCING DETAIL

NOT TO SCALE




NOTE: TREE RELOCATION SHALL BE DONE UNDER THE SUPERVISION OF A CERTIFIED ARBORIST

ROOT CUTTING NOTES:


MAKE INITIAL TRENCH CUTS 6" BEYOND THE FINAL FINISH CUT WHEN USING A TRENCHER.

Conviriant 2012 Balt Calling All Dights Decorred

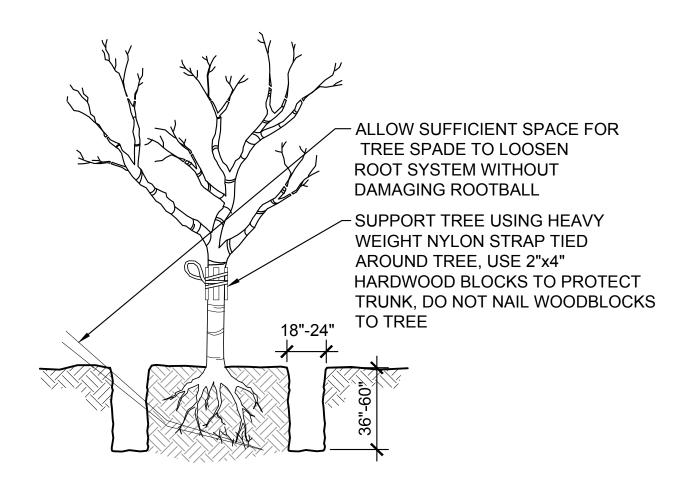- MAKE INITIAL TRENCH CUTS 12" BEYOND THE FINAL FINISH CUTS WHEN USING A BACKHOE. HAND EXCAVATE AROUND ROOTS TO THE SIZE OF DESIRED ROOTBALL AND THEN TRIM OFF
- PROTRUDING ROOTS BY HAND OR CHAINSAW.
- ANY ROOT PRUNING SHALL BE DONE BY THE CERTIFIED ARBORIST. ALL SEVERED ROOTS IRRESPECTIVE OF SIZE SHOULD BE CUT CLEAN WITH A CHAINSAW, LOPPER, PRUNING SHEARS AND/OR HANDSAW. A CLEAN CUT ALLOWS SEVERED ROOTS TO ABSORB WATER AND NUTRIENTS, AND FACILITATES ROOT REGENERATION AND COMPARTMENTALIZATION.



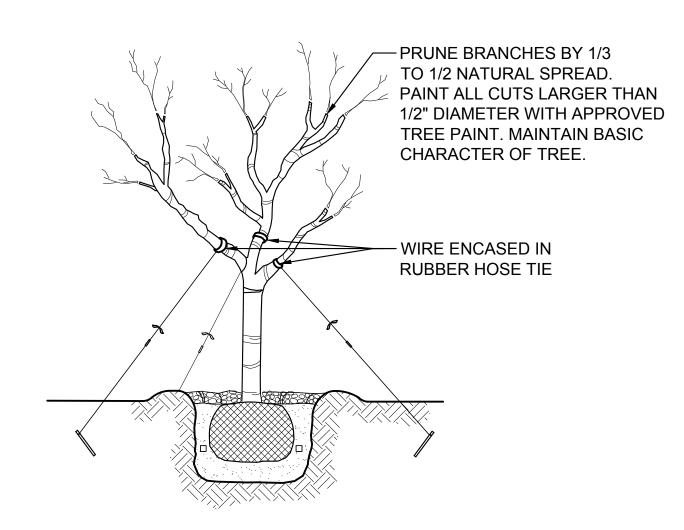TREE RELOCATION PREPARATION DETAIL NOT TO SCALE



TREE RELOCATION PLANTING DETAIL NOT TO SCALE

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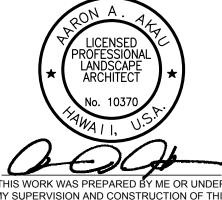
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Kalaeloa Rental Homes Site Kalaeloa, Oahu, Hawaii



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OF THE LICENSE Revisions

Sheet

TREE DISPOSITION DETAILS

Project No. 2015.33.0601

Designed by: Drawn by: CS, RS, CH

Date: APRIL 2017

LARGE TREE RELOCATION & ROOT CUTTING DETAIL

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Revised IRRIGATION

Sheet
OVERALL IRRIGATION

PLAN

Project No. 2015.33.0601 Designed by:

AA

Drawn by:
CS, RS, CH

Date:
APRIL 2017

GRAPHIC SCALE

1.00

16_{of} 54


OVERALL IRRIGATION PLAN

SCALE: 1" =30'

IRRIGATION NOTES:

- 1. IRRIGATION SYSTEMS SHOWN ON THE DRAWINGS ARE DIAGRAMMATIC AND ARE SUBJECT TO ADJUSTMENTS DUE TO UNANTICIPATED FIELD CONDITIONS. UNLESS OTHERWISE NOTED, LOCATE ALL SPRINKLER HEADS, VALVES, AND PIPES WITHIN PLANTING AREAS.
- 2. THE IRRIGATION SYSTEM DESIGN IS BASED ON A MINIMUM STATIC WATER PRESSURE OF 55 PSI AT THE POINT OF CONNECTION. NOTIFY PROJECT ENGINEER IF PRESSURE IS LESS THAN 55 PSI OR GREATER THAN 100 PSI..
- 3. CONTRACTOR IS RESPONSIBLE FOR THE COORDINATION OF THE INSTALLATION OF ALL SLEEVES, CONDUITS, MAINS AND LATERALS UNDER PAVEMENT AND THROUGH WALLS AND SHALL ASSURE THAT THESE ITEMS ARE LAID PRIOR TO THE PLACEMENT OF PAVEMENT/WALL. STUB-OUTS AND CONDUITS RUNNING THROUGH THE BUILDING STRUCTURE WILL BE DONE BY OTHERS. ALL IRRIGATION WIRES SHALL BE BUNDLED AND INSTALLED UNDER THE IRRIGATION MAIN FOR IN-GRADE INSTALLATION. INSTALL IRRIGATION WIRES IN CONDUITS WHERE WIRES ARE NOT FOLLOWING THE IRRIGATION MAIN AND ALL ABOVE-GRADE INSTALLATIONS. VERIFY UTILITY LOCATIONS BEFORE TRENCHING. CONTRACTOR WILL BE RESPONSIBLE FOR ANY DAMAGE TO UTILITIES AND EXISTING PLANTING TO REMAIN.
- 4. INSTALL SPRINKLER HEADS 6" AWAY FROM WALKWAYS, DRIVEWAYS AND 24" FROM STRUCTURES. FLEX RISERS SHALL BE USED ON ALL SHRUB HEADS ON RISERS INSTALLED ALONG WALKWAYS, DRIVEWAYS AND PARKING SPACES. ADJUST ALL SPRINKLER HEADS TO OBTAIN BEST COVERAGE. ADJUST FLOW CONTROL OF CONTROL VALVES TO MINIMIZE MISTING.
- 5. THE CONTRACTOR, TOGETHER WITH THE OWNER'S MAINTENANCE REPRESENTATIVE SHALL PROGRAM THE IRRIGATION CONTROLLER TO ACCOMMODATE THE LANDSCAPE AND SITE REQUIREMENTS, AND SHALL INSTRUCT THE REPRESENTATIVE ON THE OPERATION OF THE COMPLETE SYSTEM. ALL IRRIGATION OPERATION SHALL BE DURING "OFF PEAK" HOURS. OPERATION DURING OTHER TIMES SHALL BE WITH THE APPROVAL OF THE OWNER.

SYMBOL	MANUFACTURER/MODEL	PSI	GPM	RADIUS
-	TORO 570Z-4P-PRX-COM 15 SERIES	30	3.60	15'
•				
	TORO 570Z-4P-PRX-COM 15 SERIES	30	1.65	15'
•	1010 0702-41 -1 100-00W 10 0EINE0		1.00	
	TORO 570Z-4P-PRX-COM 15 SERIES	30	0.85	15'
•	TORU 5702-4P-PRA-COW 15 SERIES	30	0.65	15
A	TORO 570Z-4P-PRX-COM TURF STRIP SPRAY	30	0.45	4'x15'
-				
	TORO 570Z-4P-PRX-COM TURF STRIP SPRAY	30	0.90	4'x30'
Δ				
	TORO 570Z-12P-PRX-COM 15 SERIES	30	1.65	15'
	TORO 570Z-12P-PRX-COM 15 SERIES	30	0.85	15'
©	TORO 5702-12P-PRA-COIVI 15 SERIES	30	0.65	13
©	TORO 570Z-12P-PRX-COM 15 SERIES	30	1.10	15'
	TORO 570Z-12P-PRX-COM 15 SERIES	30	2.60	15'
•				
	TORO 570Z-12P-PRX-COM 15 SERIES VAN	30	 	15'
•				. •
	TODO 5707 400 DDV 00M 0UDUD 07DD 00D 4V	20	0.45	41 4=1
(A)	TORO 570Z-12P-PRX-COM SHRUB STRIP SPRAY	30	0.45	4'x15'
<u> </u>	TORO 570Z-12P-PRX-COM SHRUB STRIP SPRAY	30	0.90	4'x30'
SYMBOL	MANUFACTURER/MODEL/DESCRIPTION	PSI	GPM	RADIUS
	TORO T5-P-CK-LA TURF ROTOR, 5" POP-UP, LOW ANGLE NOZZLES,	45	1.52	31'
1 (51) x	PLASTIC RISER. ADJUSTABLE ARC PATTERNS 40-360, 25`-50` RADIUS			
	WITH CHECK VALVE			
	TORO T5-P-CK-LA TURF ROTOR, 5" POP-UP, LOW ANGLE NOZZLES,	45	3.05	34'
((1))	PLASTIC RISER. ADJUSTABLE ARC PATTERNS 40-360, 25`-50` RADIUS WITH CHECK VALVE			
	WITH CHECK VALVE			
SYMBOL	MANUFACTURER/MODEL/DESCRIPTION			
	TORO 220-26-0 BRASS 1", 1-1/4", 1-1/2", 2", 2-1/2", AND 3" ELECTRIC			
•	REMOTE CONTROL VALVE, WITH SPIKE GUARD SOLENOID. 1"-2" HAVE IN-LINE GLOBE BODY STYLE, AND 2-1/2" - 3" ARE ANGLE VALVE			
	BODY STYLES			
	TORO 100-2SLVC TWO-PIECE, 1" SINGLE LUG QUICK COUPLER	<u> </u>		
	VALVE WITH VINYL COVER			
×	NIBCO T-113 CLASS 125 BRONZE GATE SHUT OFF VALVE WITH WHEEL HANDLE			
	ZURN 975XL 1-1/2" REDUCED PRESSURE BACKFLOW PREVENTER			
BF	ZONN STONE I- 1/2 NEDUCED FRESSURE DAUNFLUW PREVENTER			
	RAIN MASTER CONTROLLER RME36EGI-ST			
Ц				
^	IRRITROL RS1000 WIRELESS RAIN SENSOR			
€\$				
	IRRIGATION LATERAL: PVC CLASS 200 SDR 21 PIPE			
	IN THE THE TENTE IN THE TOTAL			
	India Atlanta in the first of t			
	IRRIGATION MAINLINE: PVC SCHEDULE 40 PIPE			
_				
	PIPE SLEEVE: PVC SCHEDULE 40 PIPE			
======				
	PIPE CONDUIT: PVC SCHEDULE 40 PIPE			
		1		
			l	

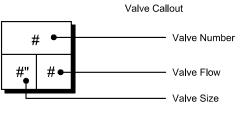

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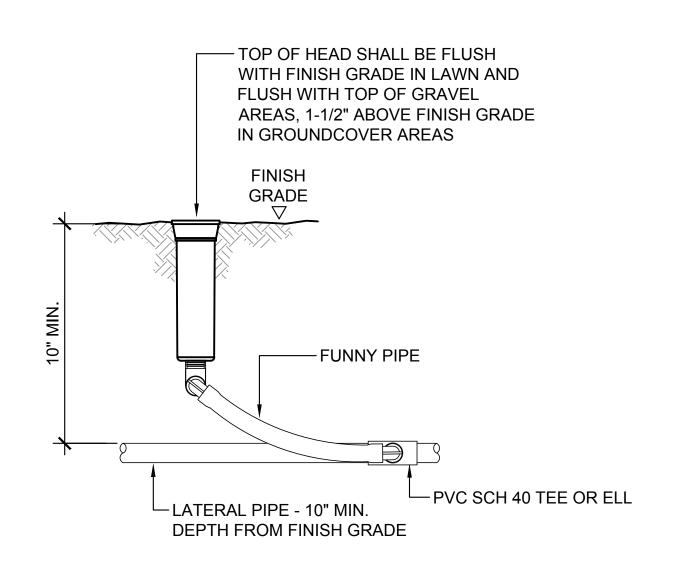
IRRIGATION EQUIPMENT SCHEDULE, DETAILS AND NOTES

Project No. 2015.33.0601 Designed by:

Drawn by:
CS, RS, CH
Date:

Date:
APRIL 2017

L302



-BRASS GATE VALVE

H UNION

-INSTALL 8" PIPE

COLUMN SLEEVE FOR

– WARNING /

-PVC MAIN

DETECTION

TAPE (TYP.)

DEEP GATE VALVE



TOP OF VALVE BOX TO BE FLUSH-

/4" MIN.

WITH FINISH GRADE IN LAWN

GROUNDCOVER AND GRAVEL

NO. 3 GRAVEL —

NOT TO SCALE

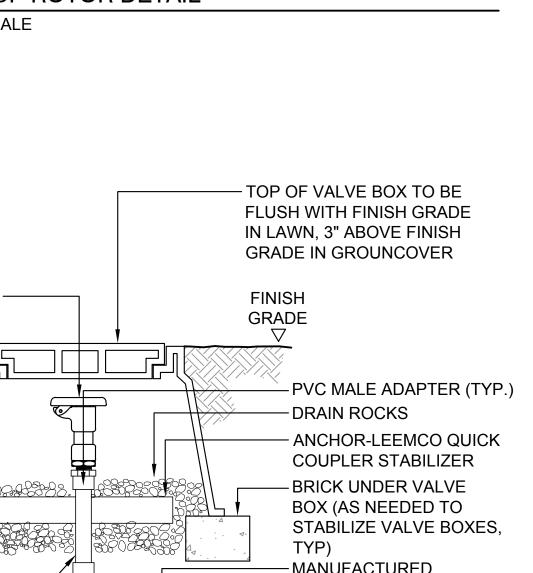
GATE VALVE DETAIL

(3" DEPTH)

AND 3" ABOVE FINISH GRADE IN


TOP OF HEAD SHALL BE FLUSH WITH FINISH GRADE IN LAWN AND FLUSH WITH TOP OF GRAVEL AREAS AND 1-1/2" ABOVE FINISH GRADE IN GROUND **COVER AREAS** GRADE - 3/4" STREET ELLS - 3/4" SCH 80 NIPPLE SIDE VIEW PVC LATERAL -PVC TEE PVC LATERAL - KBI SWING JOINT **TOP VIEW**

4" POP-UP ROTOR DETAIL NOT TO SCALE




QUICK COUPLER VALVE DETAIL NOT TO SCALE

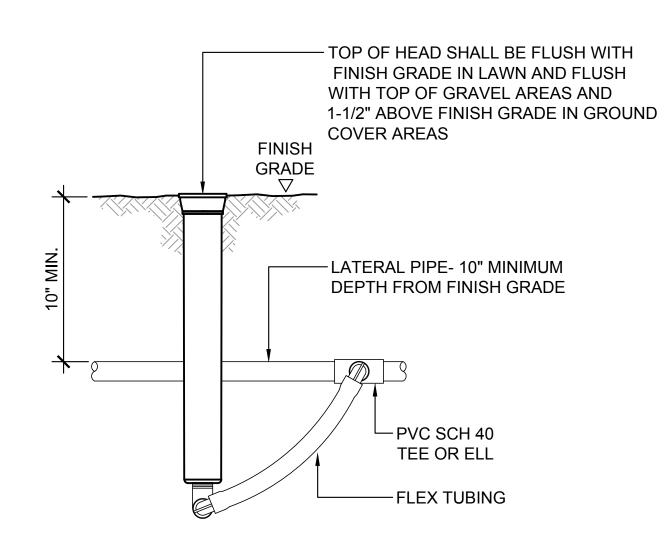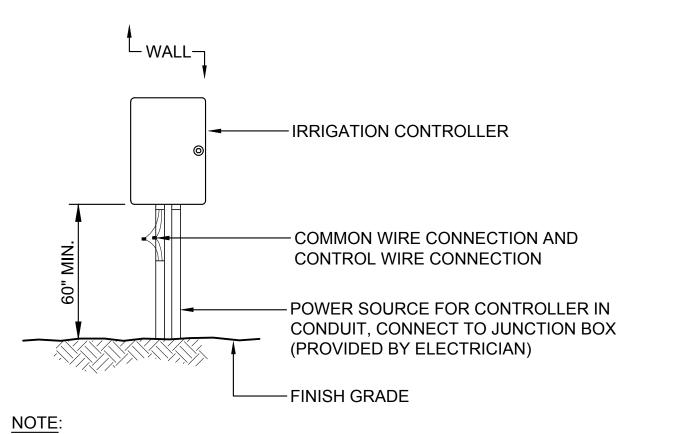Converight 2012 Polt Colline All Dights Decorved








1. MOUNT CONTROLLER 60" MIN. FROM FINISH GRADE TO BOTTOM OF CONTROLLER.

2. ALL WIRING TO BE INSTALLED AS PER LOCAL CODE.

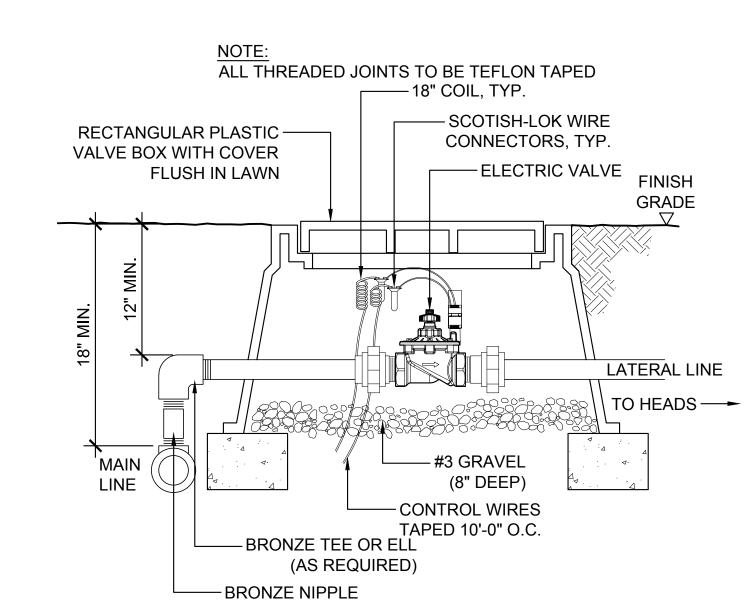
3. SEE MANUFACTURER'S RECOMMENDATIONS FOR MOUNTING.







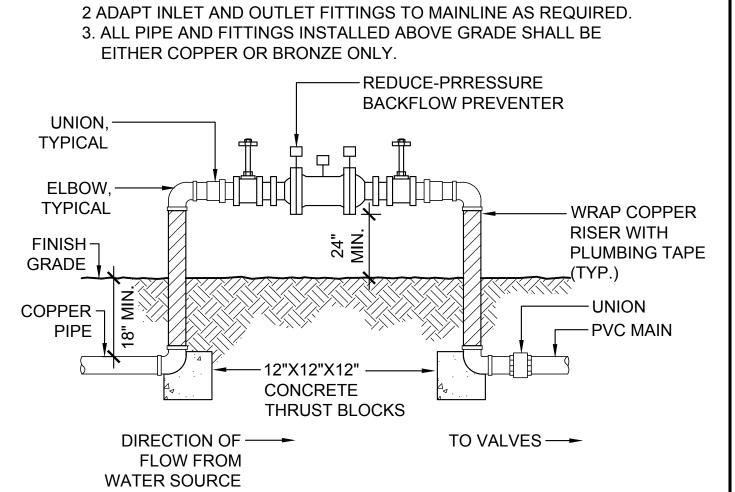1. USE FLANGED FITTINGS ON 3" AND LARGER PIPE.



BACKFLOW PREVENTER DETAIL NOT TO SCALE



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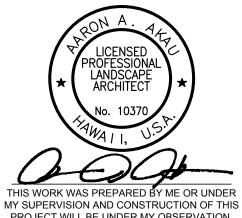
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EXPIRATION DATE OF THE LICENSE

Revisions 1 ADDED DETAIL

Sheet

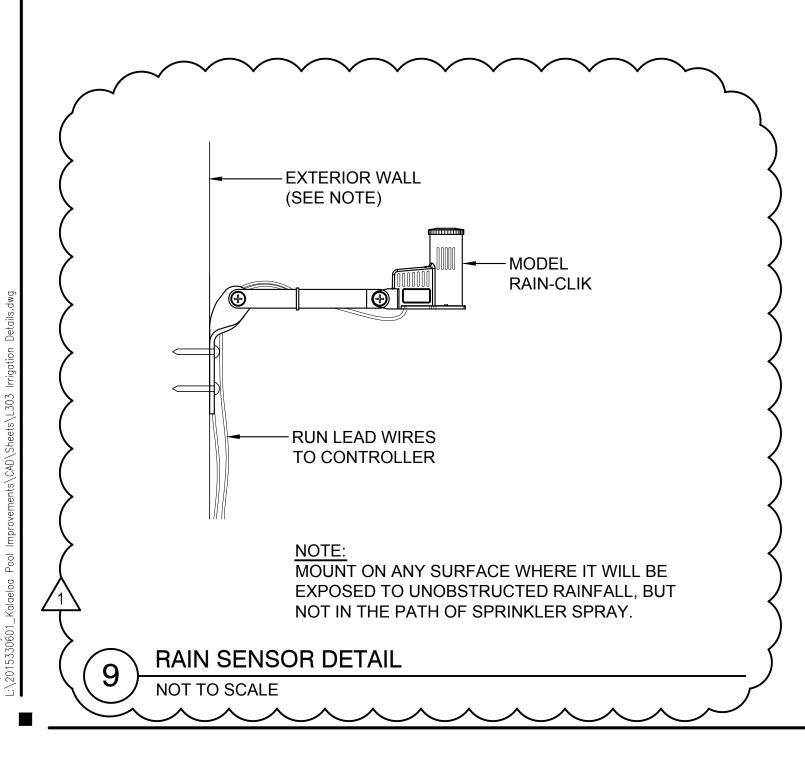
IRRIGATION DETAILS

Project No. 2015.33.0601

Designed by: Drawn by: CS, RS, CH

Date: APRIL 2017


18 of 54




BRICKS UNDER VALVE BOX -

(AS NEEDED TO STABILIZE

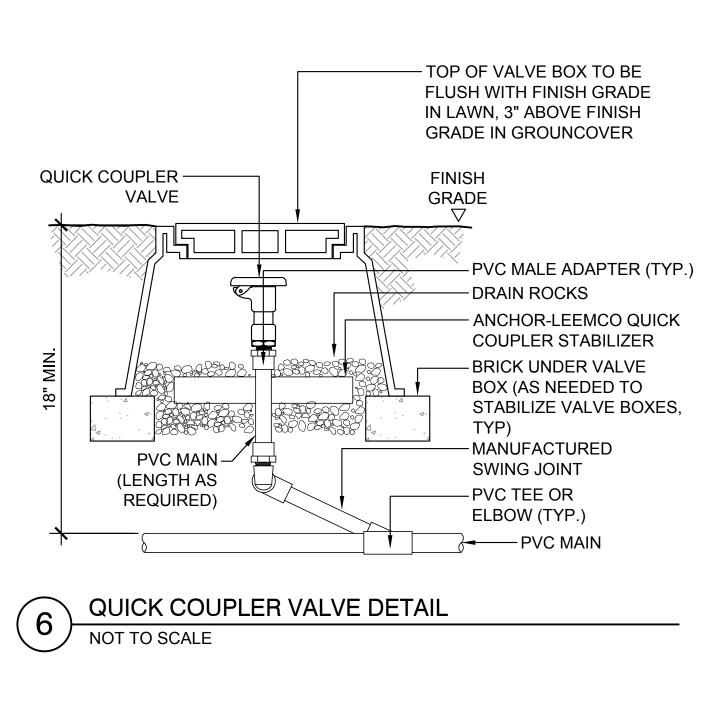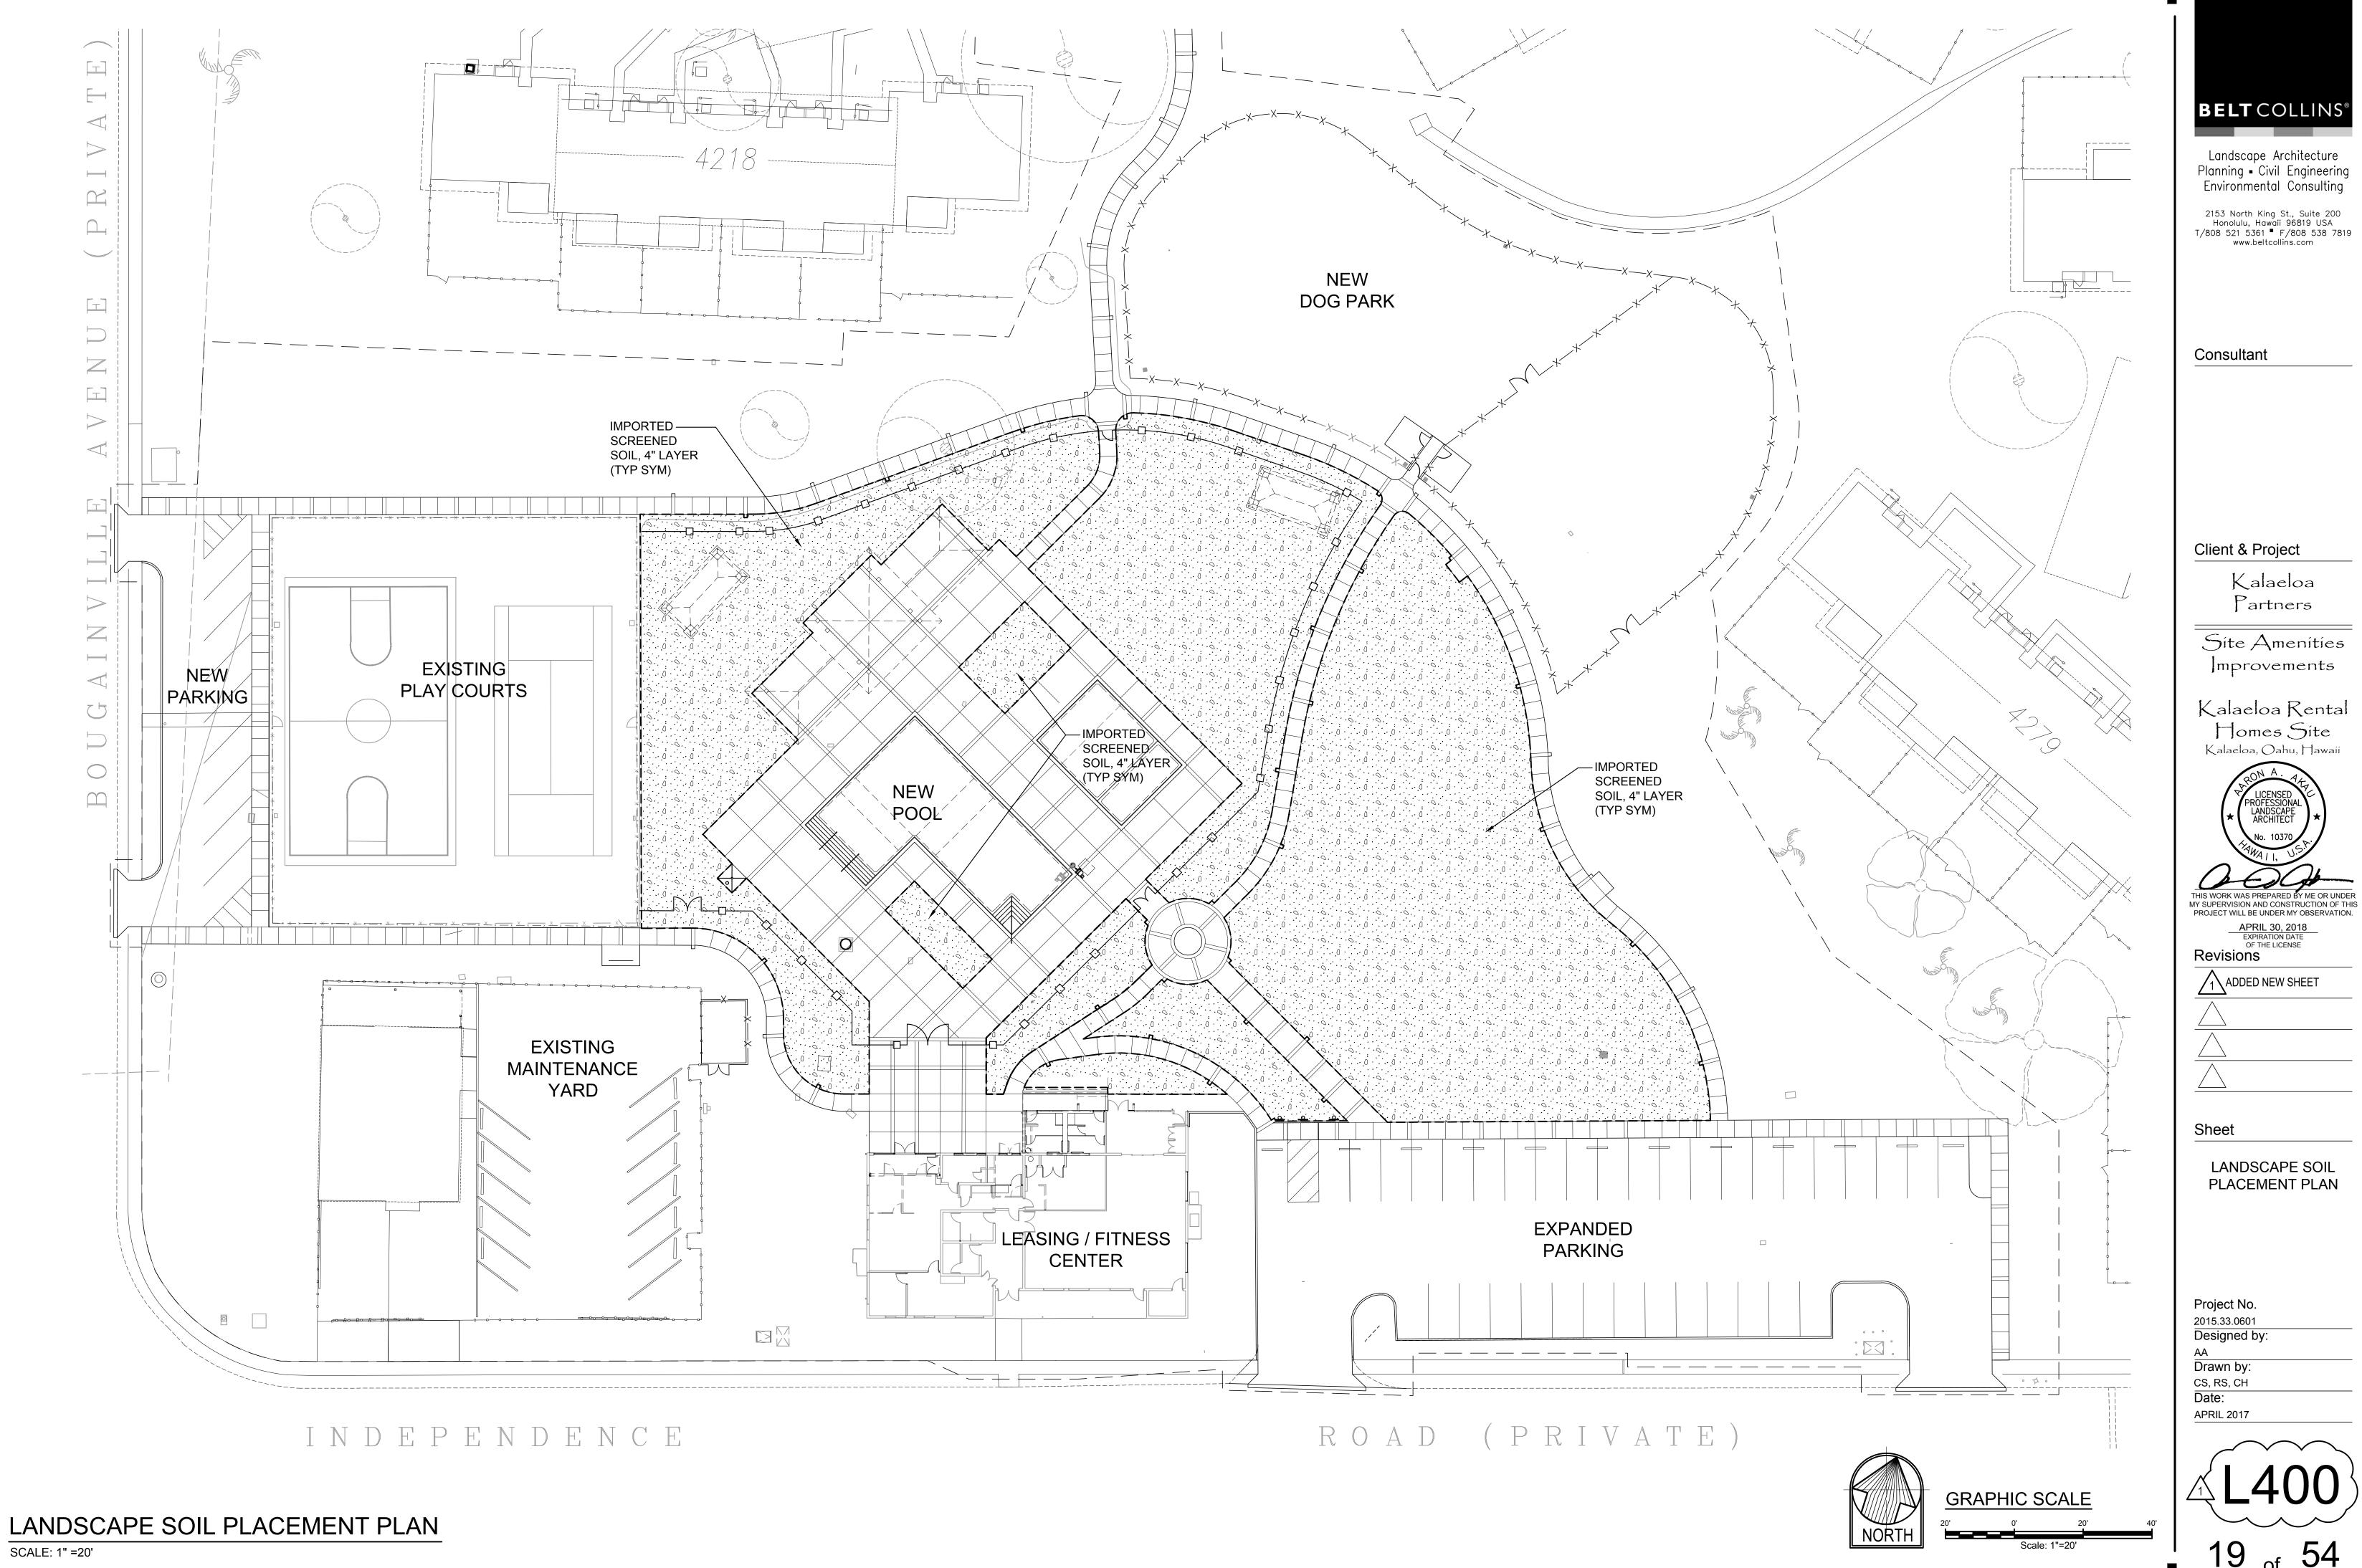VALVE BOXES) - TYPICAL








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LANDSCAPE SOIL PLACEMENT PLAN



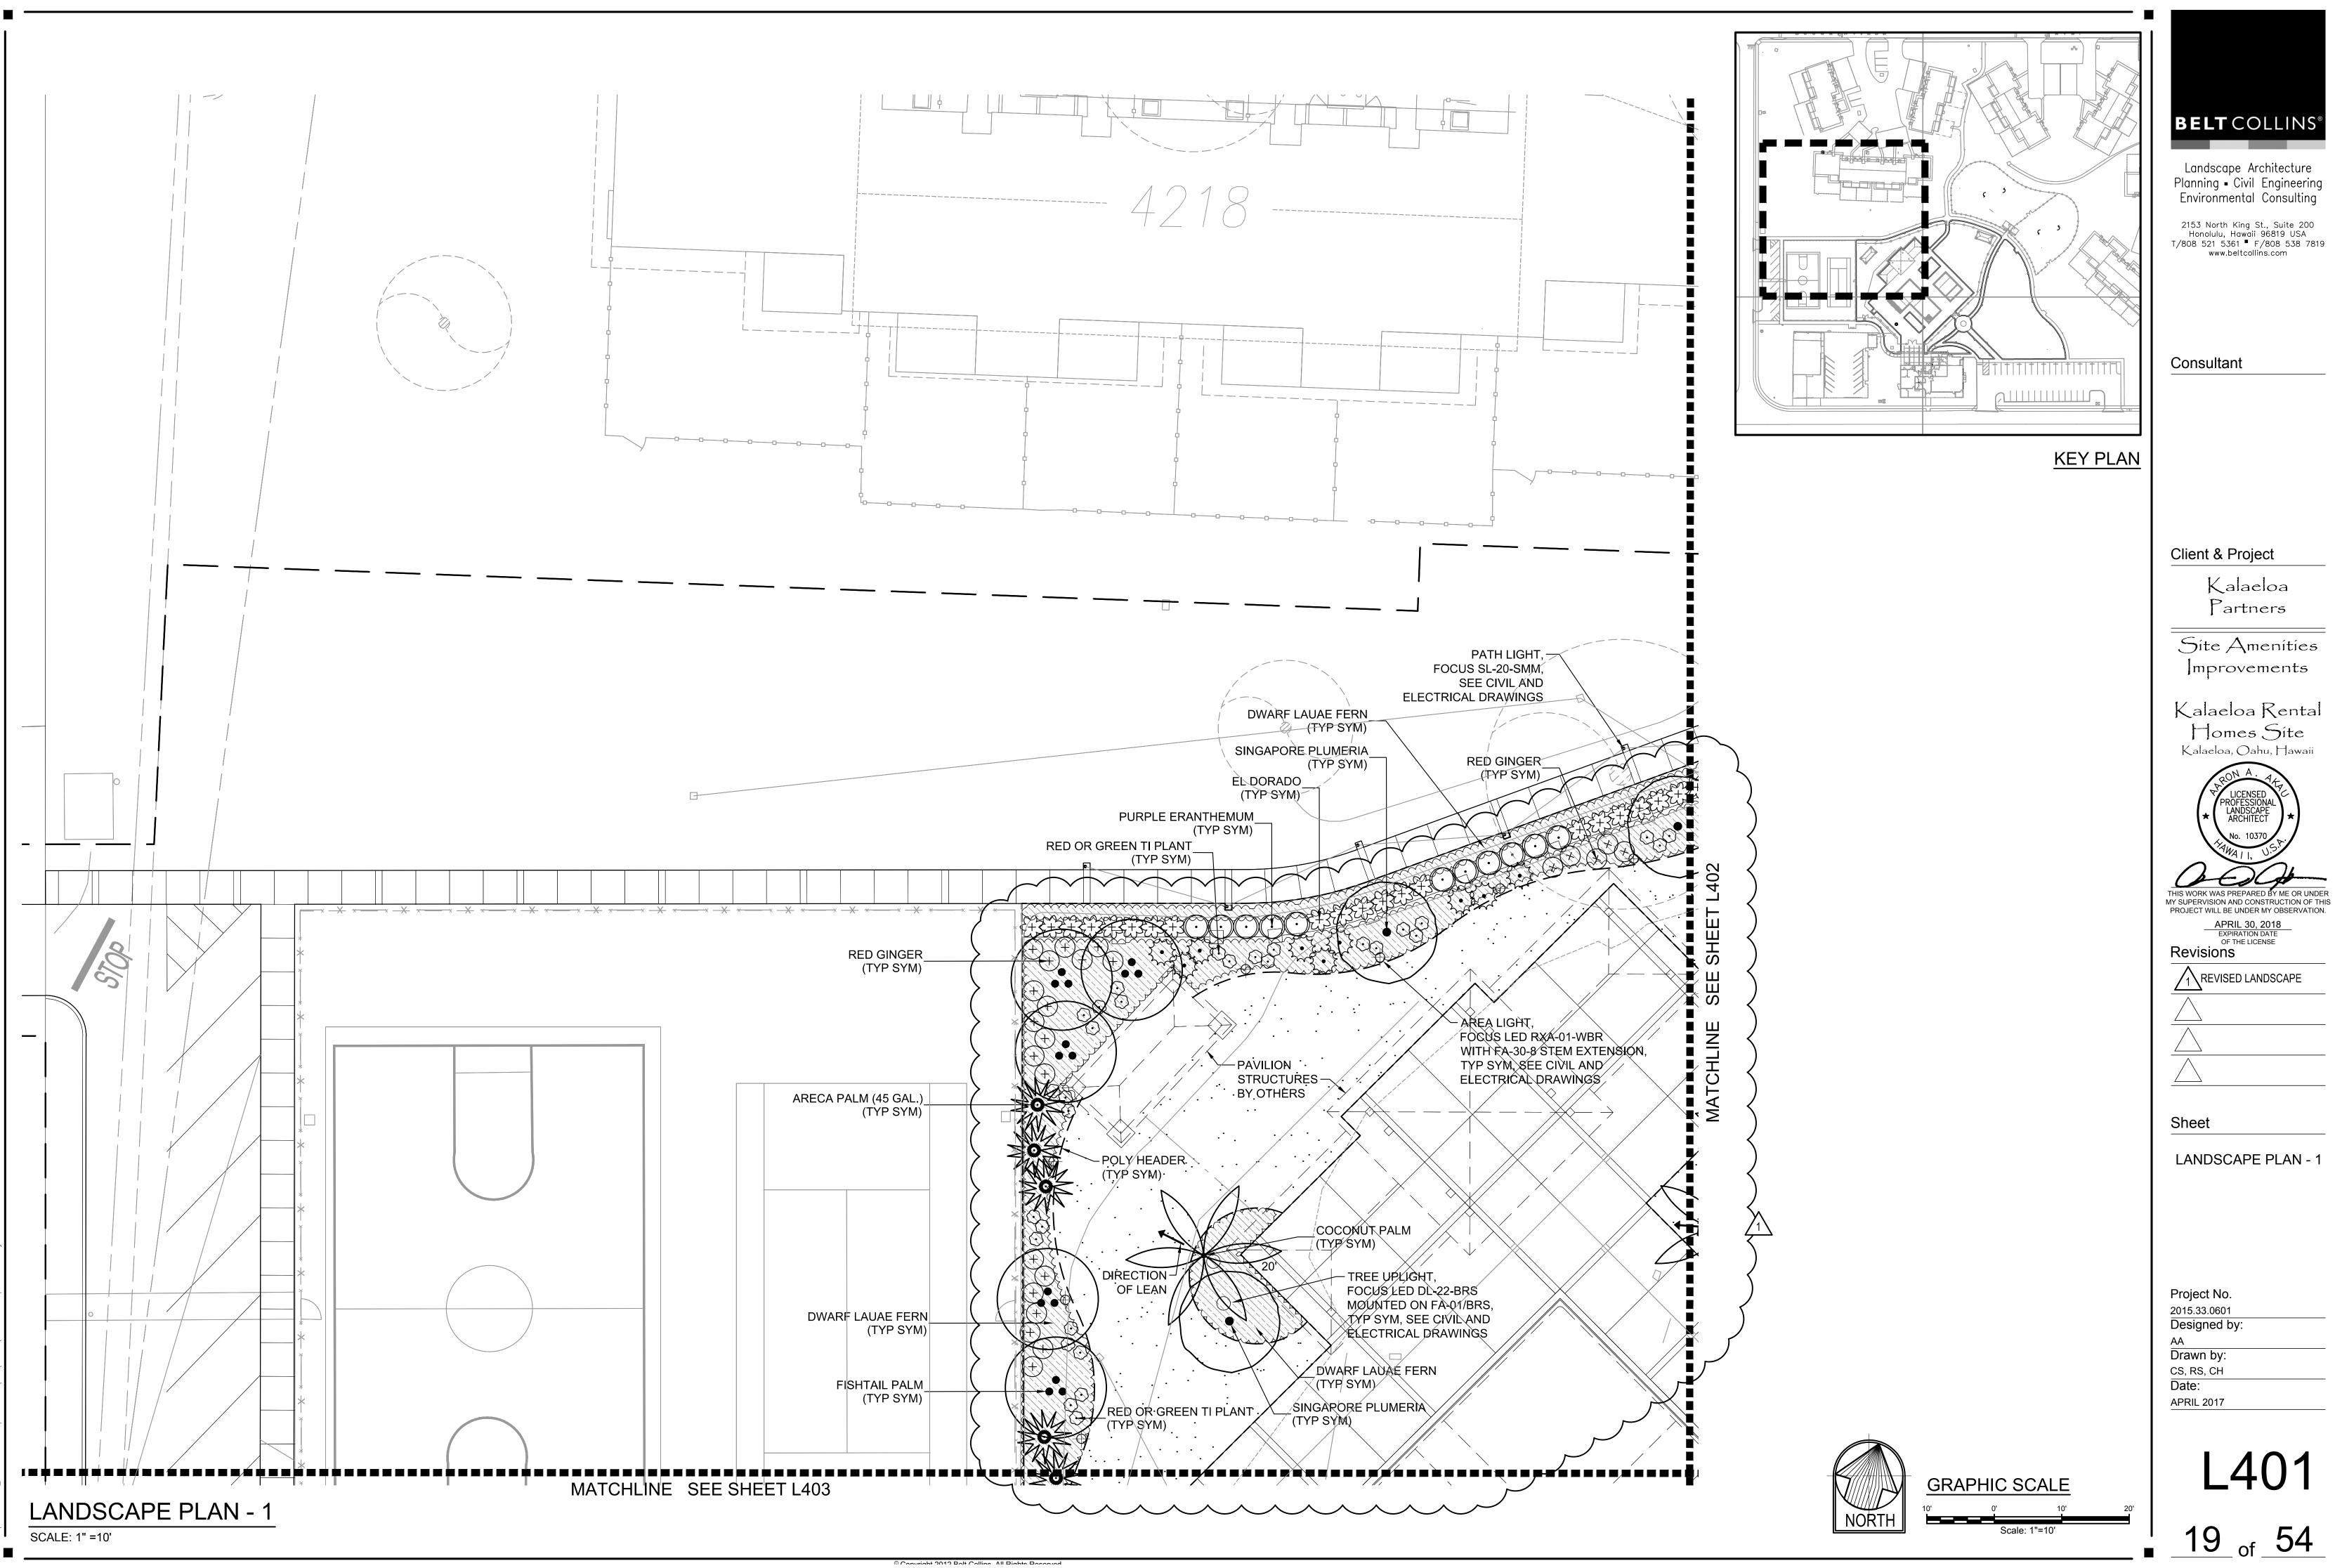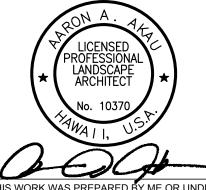
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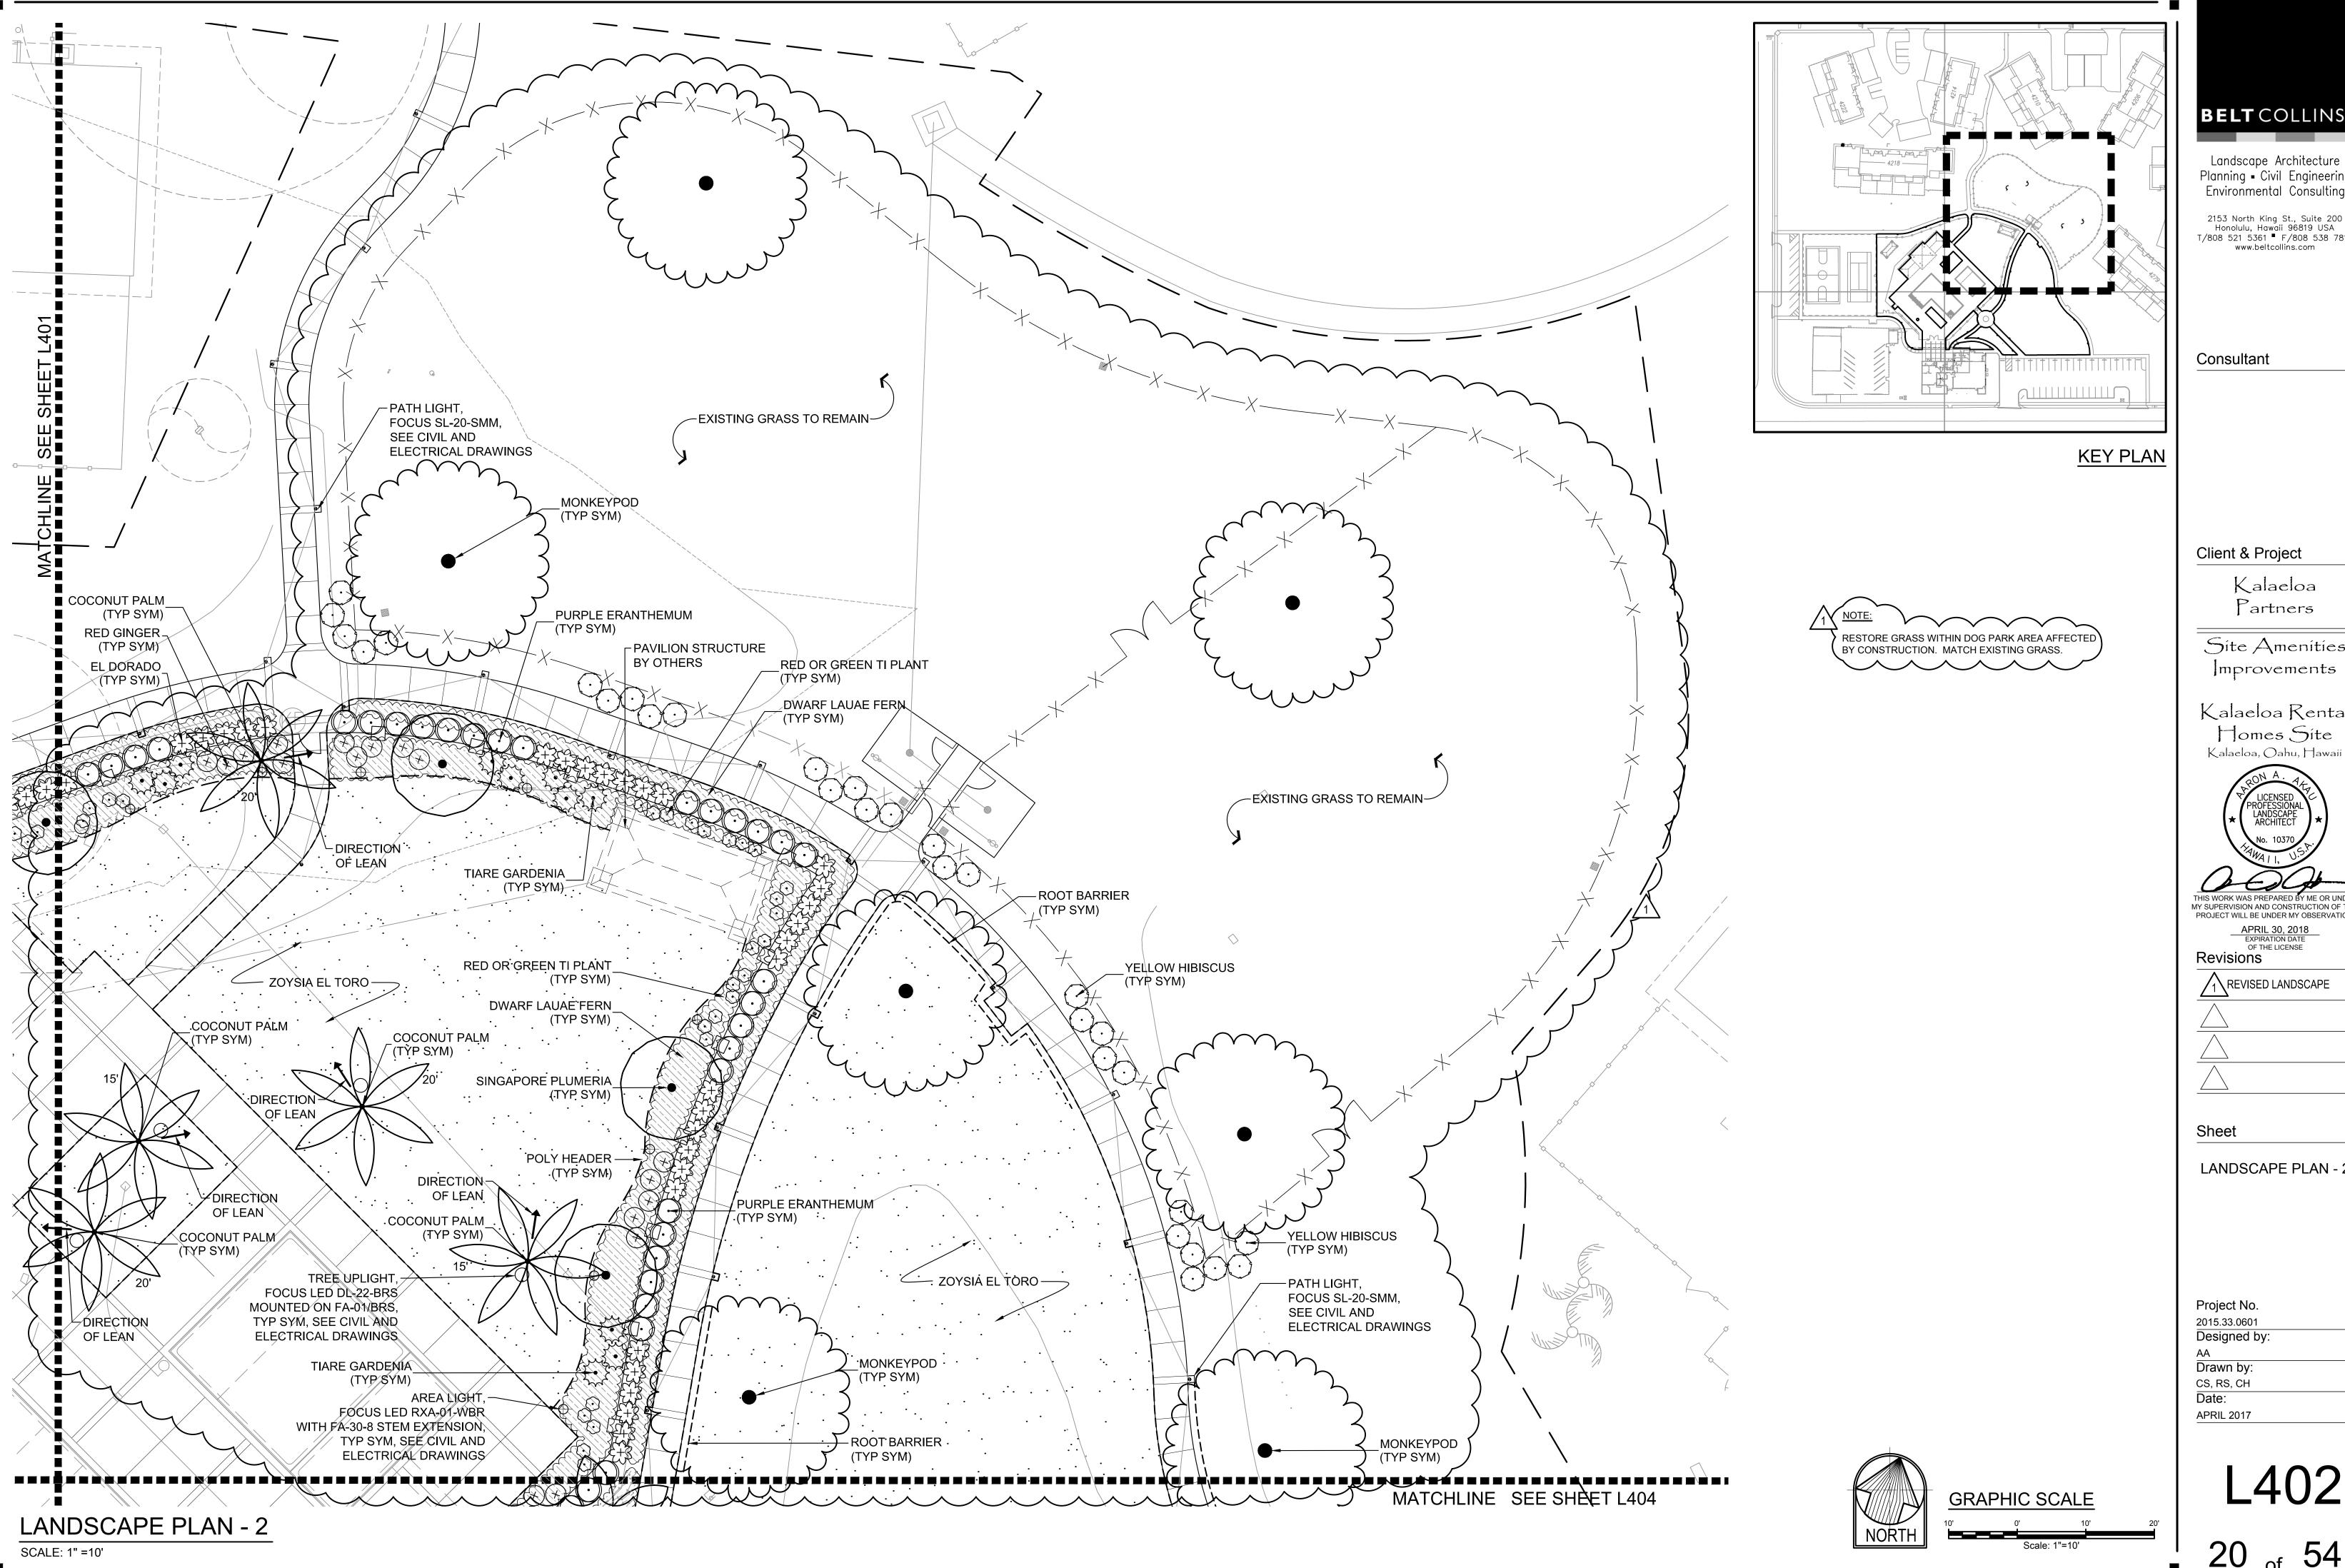
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1 REVISED LANDSCAPE


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LANDSCAPE PLAN - 2

Project No. 2015.33.0601

Designed by:

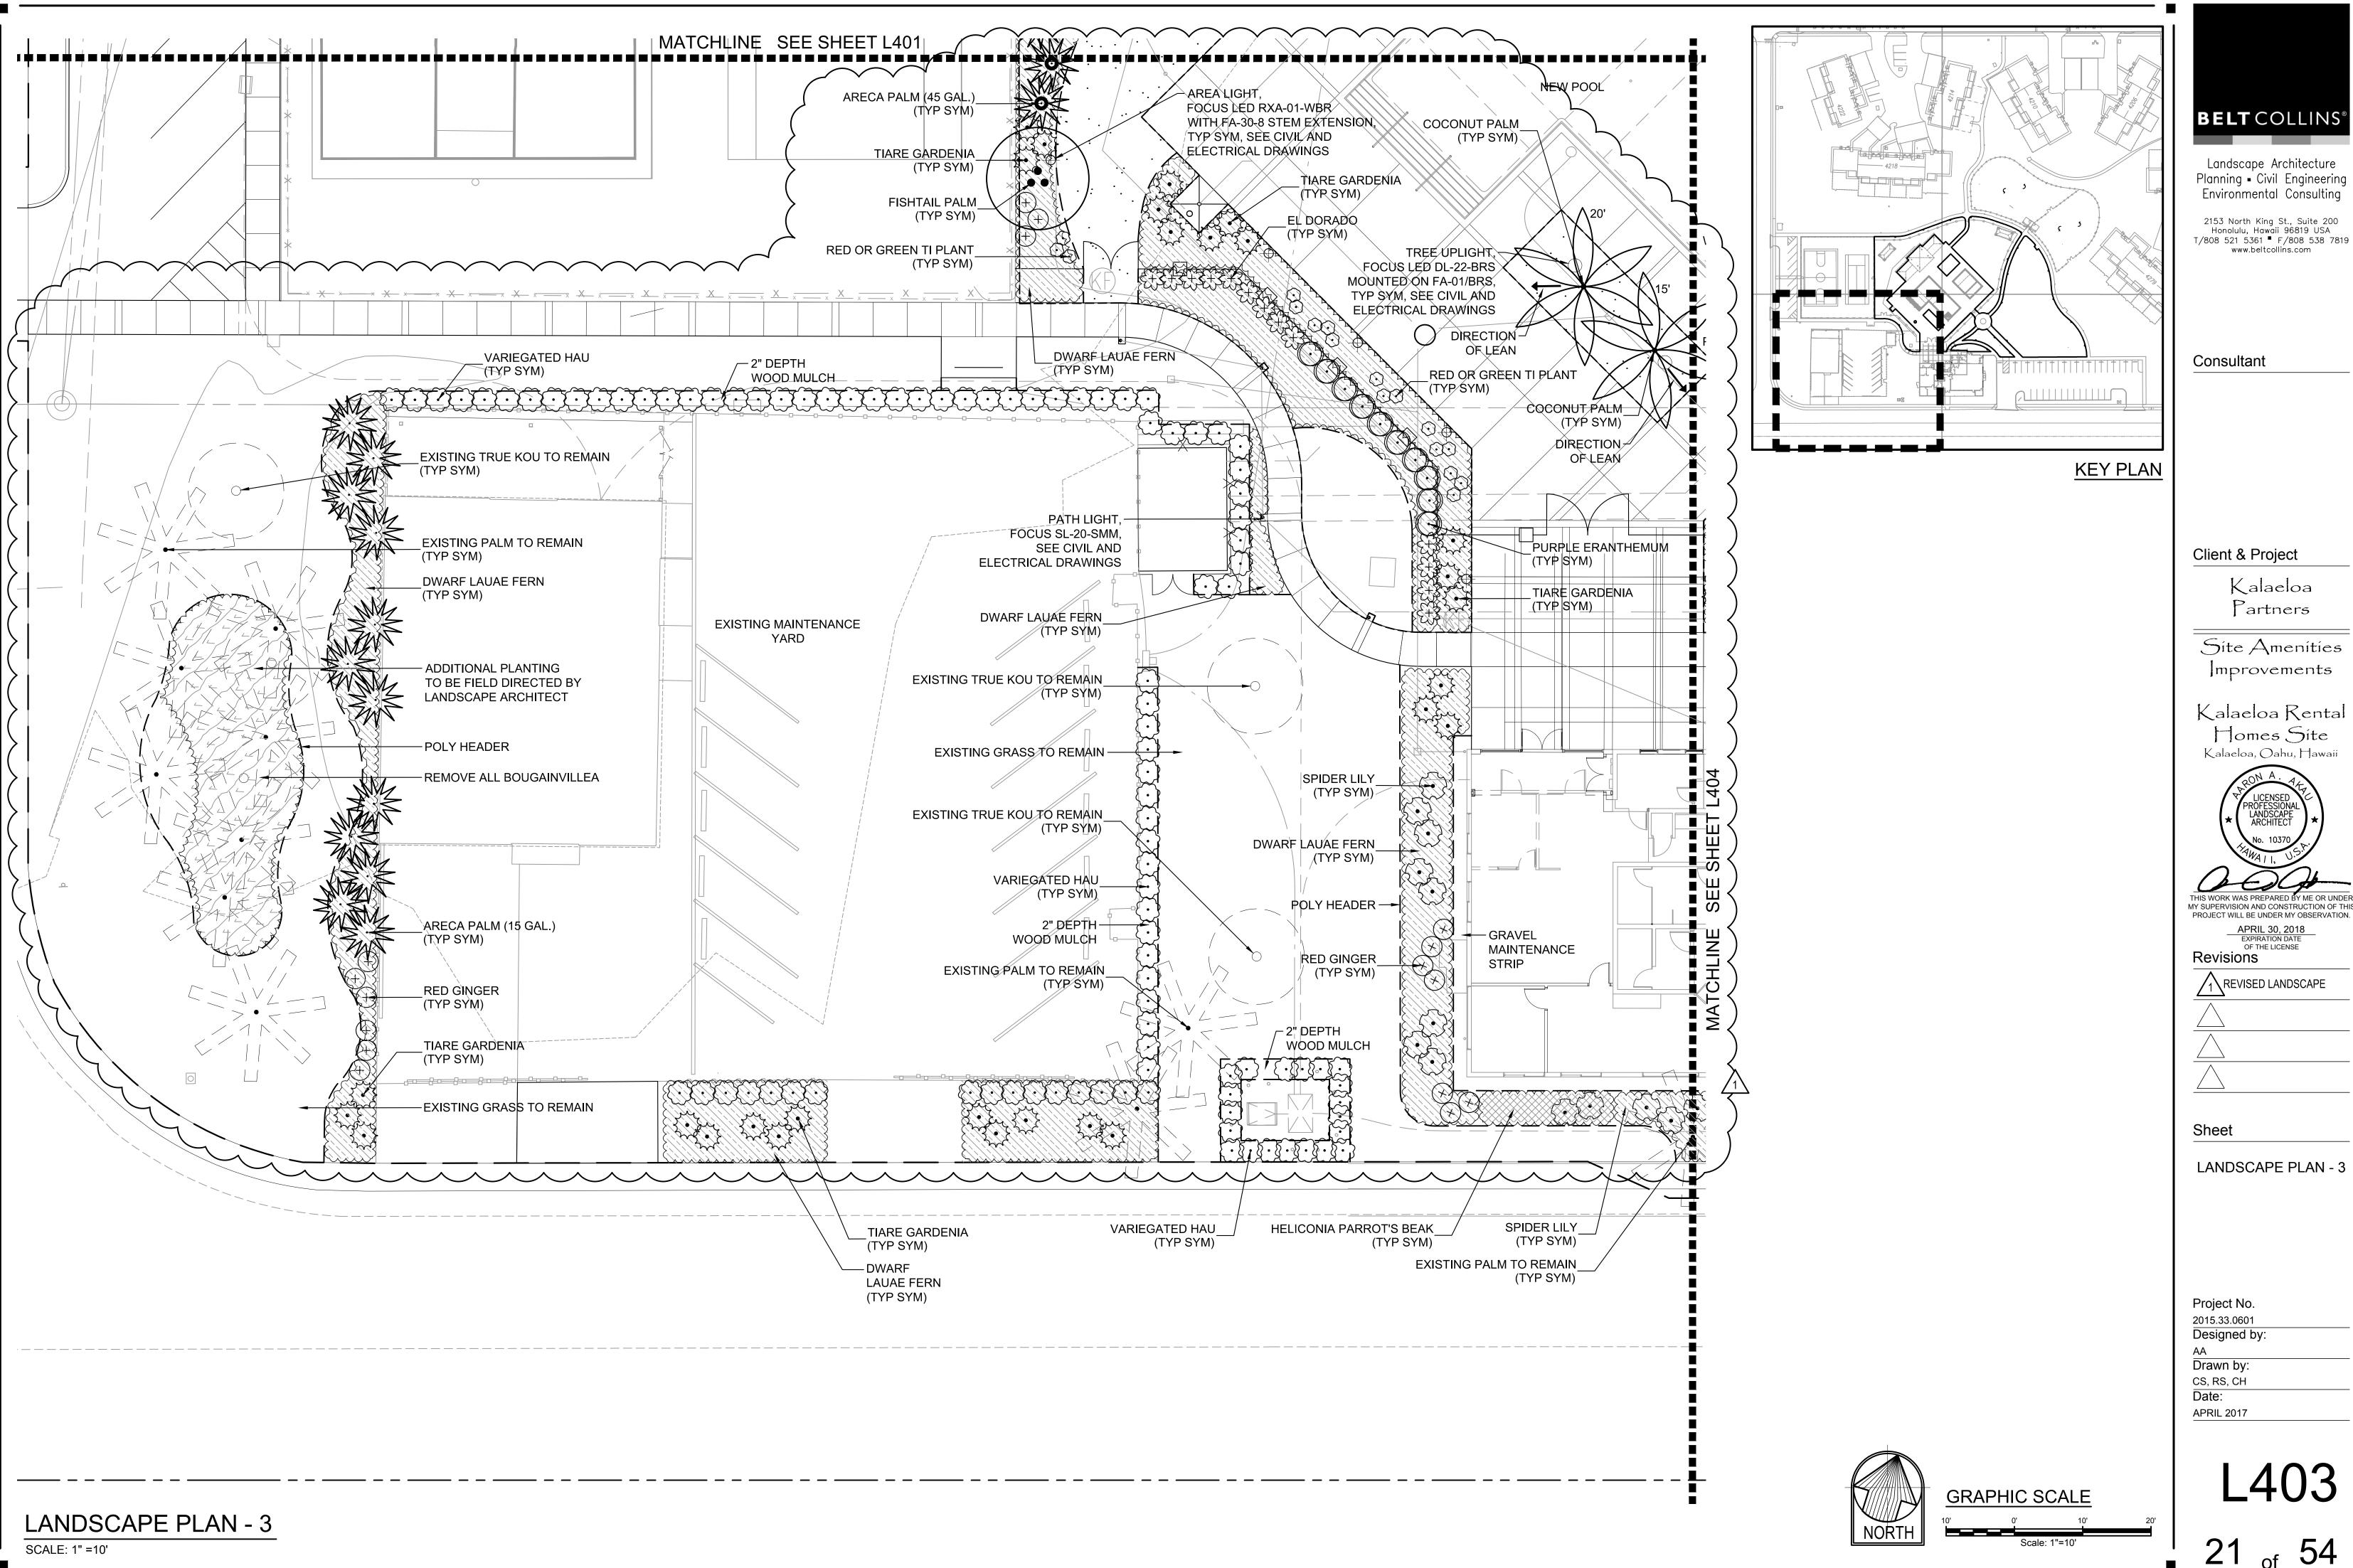Drawn by: CS, RS, CH



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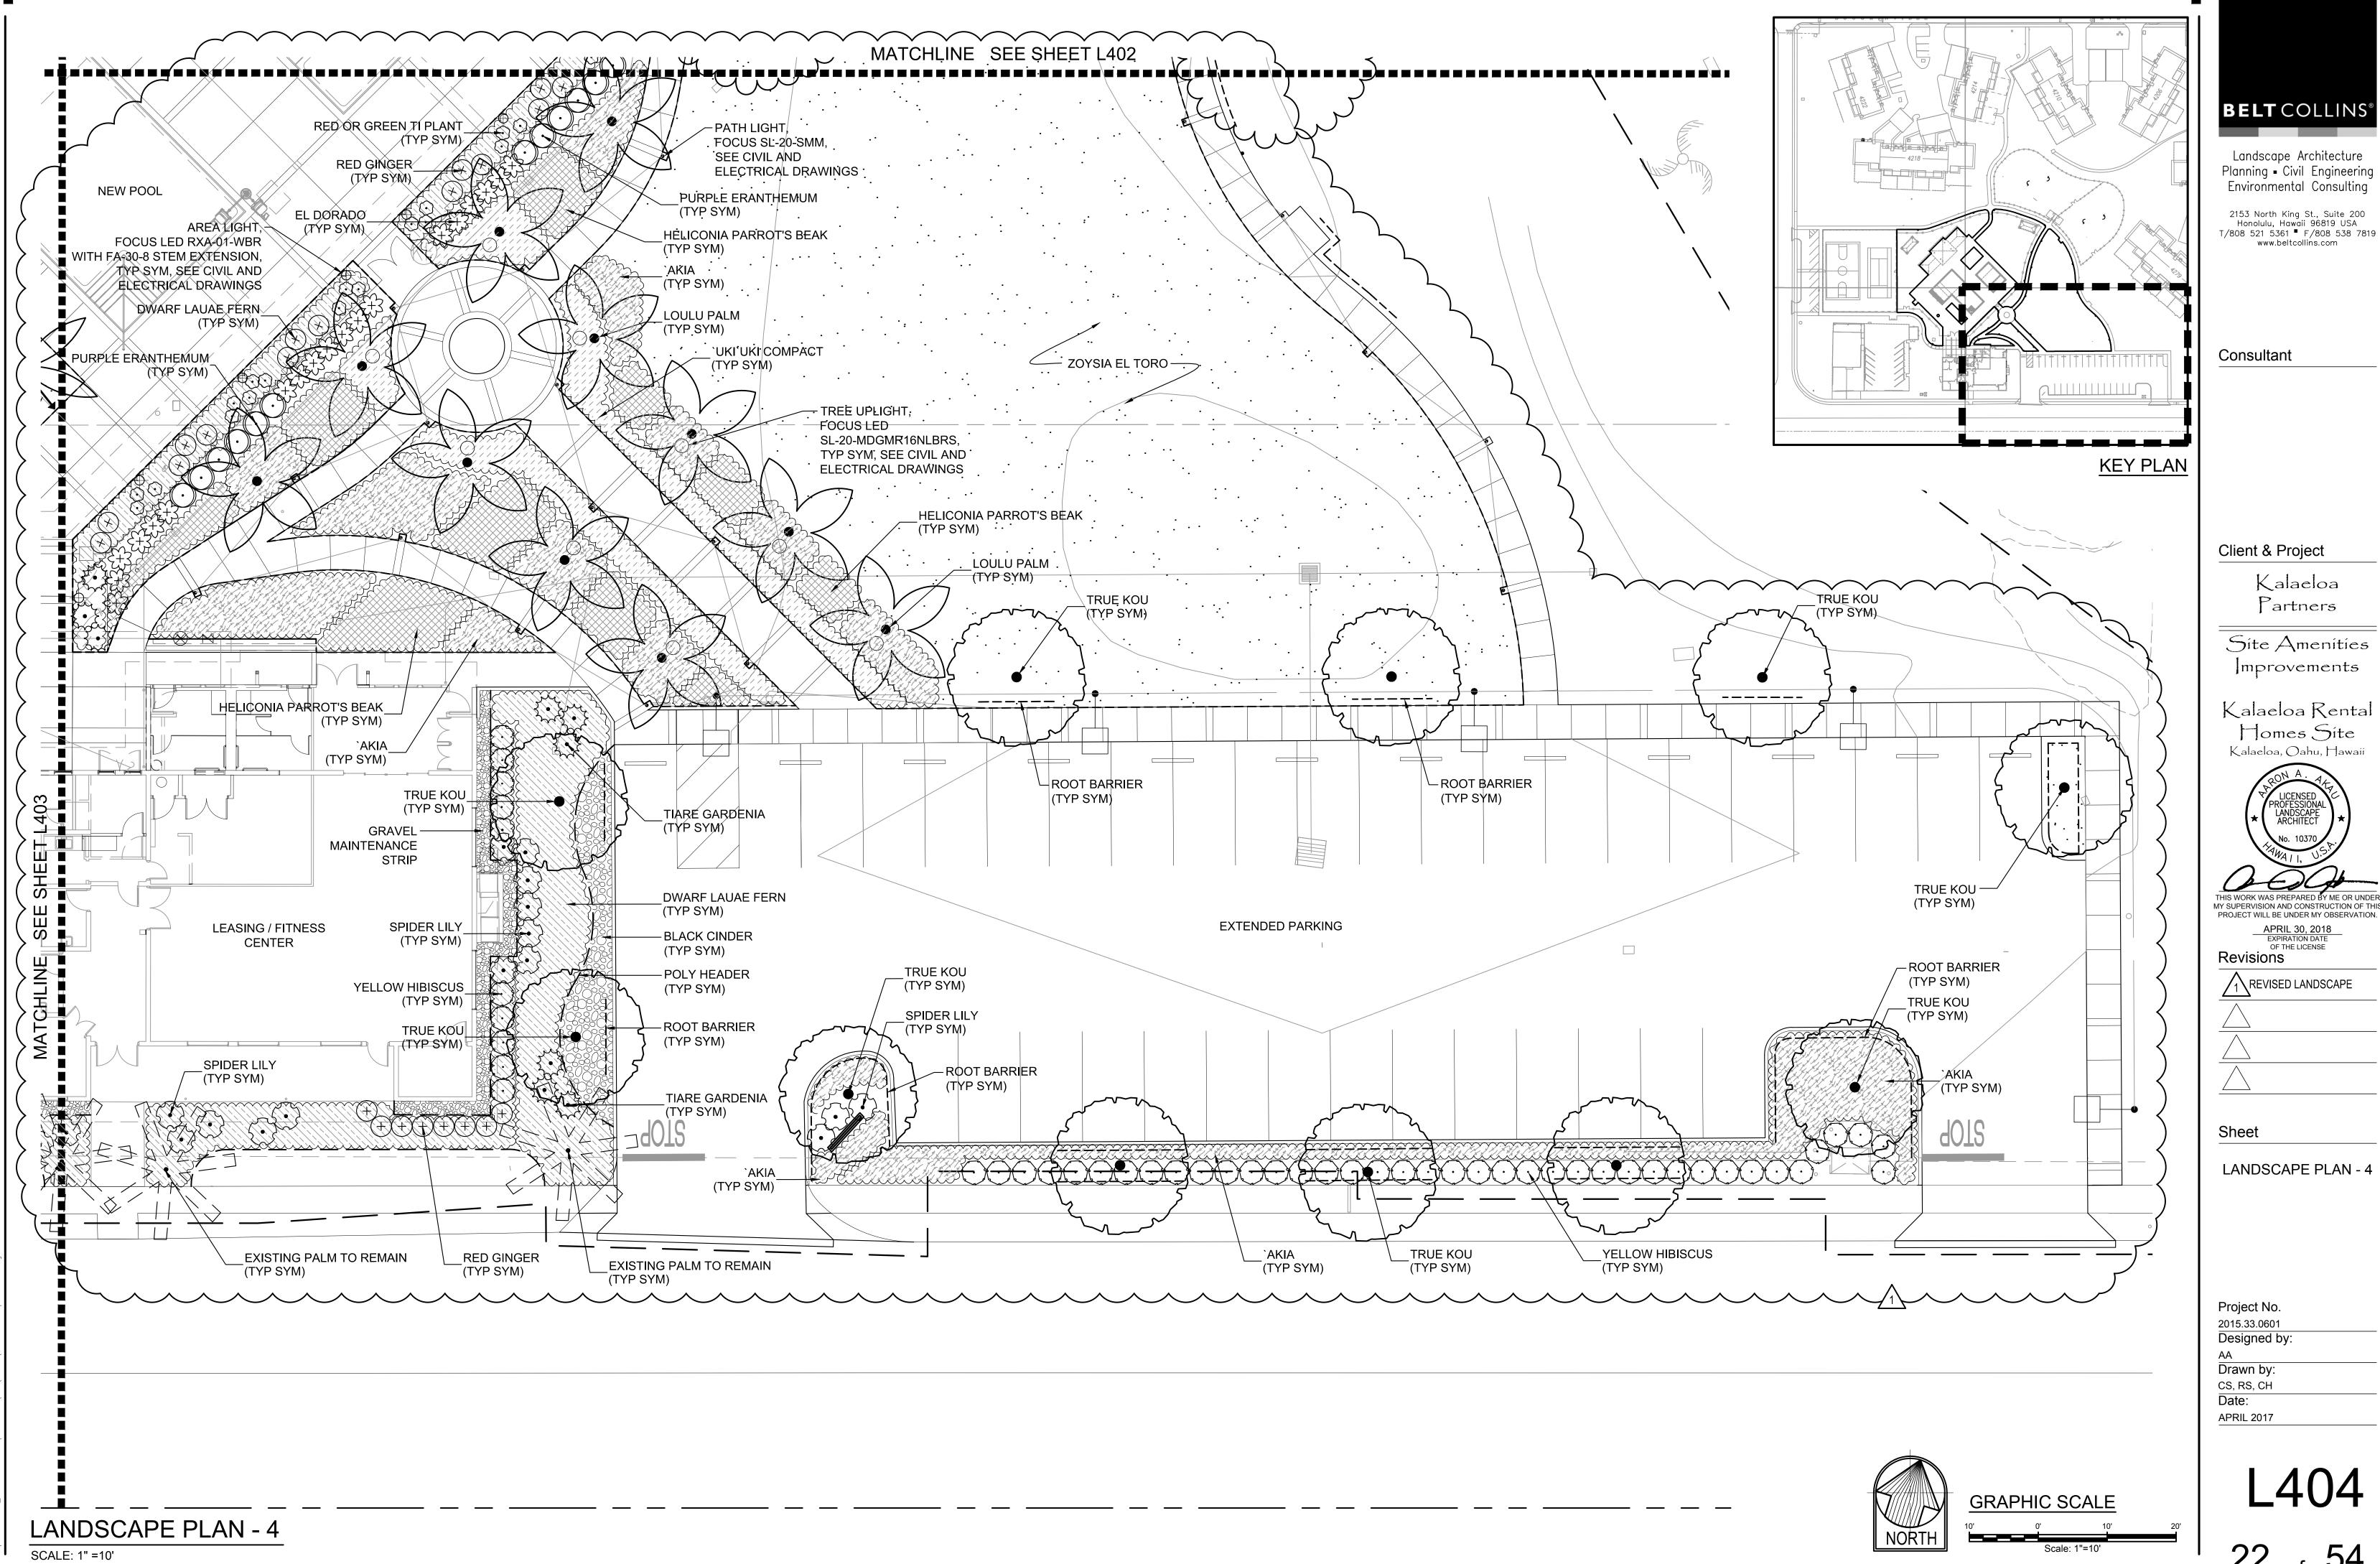
Revisions $\sqrt{1}$ REVISED LANDSCAPE

LANDSCAPE PLAN - 3

Project No. 2015.33.0601

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OF THE LICENSE

1 REVISED LANDSCAPE

LANDSCAPE PLAN - 4

Project No. 2015.33.0601

Drawn by: CS, RS, CH

TREES	DULE Toty	BOTANICAL NAME	COMMON NAME	I GAI	SIZE	TYP SYM	Ī	REMARKS
KEEO	QTY		COMMON NAME	GAL F.S.		I I I L D I M		
•	6	CARYOTA MITIS	FISHTAIL PALM	F.S.	8`-10` BRN. TRK. HT.			8' TRUNK HT.
	17	CHRYSALIDOCARPUS LUTESCENS	ARECA PALM	15 GAL	4`-6` HT. MIN.			4-5 CANES
	6	CHRYSALIDOCARPUS LUTESCENS	ARECA PALM	45 GAL	8` HT. MIN.			4-5 CANES
	8	COCOS NUCIFERA	COCONUT PALM	F.S.	15` - 20` BRN. TRK. HT. SEE PLAN			NO SCARRING ON TRK.
	11	CORDIA SUBCORDATA	TRUE KOU	25 GAL	6` - 8` HT.			STRAIGHT TRUNK
	5	CORDIA SUBCORDATA	EXISTING TRUE KOU TO REMAIN	F.S.				
	6	PLUMERIA OBTUSA	SINGAPORE PLUMERIA	25 GAL	6` - 8` HT.			
$\overline{}$								
23	11	PRITCHARDIA HILLEBRANDII	LOULU PALM	F.S.	8` BROWN TRUNK HEIGHT			
$\overline{\bullet}$	11	RHAPIS EXCELSA	RHAPIS PALM	15 GAL	4`-6` HT.			
£(•)}	7	SAMANEA SAMAN	MONKEYPOD	F.S.	8` - 10` HT.			STRAIGHT, ROUND CANOP
	13	VEITCHIA MERRILLII	EXISTING PALM TO REMAIN	EX		TO REMAIN		
SHDI IBS	OTV	POTANICAL NAME	COMMONINAME	GAL				REMARKS
	QTY 88	BOTANICAL NAME ALPINIA PURPURATA	COMMON NAME RED GINGER	7 GAL				INLIVIANINO
	10	CORDYLINE FRUTICOSA	RED TI	3 GAL				
\odot	91	CORDYLINE FRUTICOSA	RED OR GREEN TI PLANT	3 GAL				
\bigcirc	28	CRINUM ASIATICUM	SPIDER LILY	5 GAL				RUST FREE
***	57	GARDENIA TAITENSIS	TIARE GARDENIA	5 GAL				
\odot	78	HIBISCUS SPP.	YELLOW HIBISCUS	5 GAL				
\odot	101	HIBISCUS TILIACEUS VARIEGATUM	VARIEGATED HAU	5 GAL				36" O.C.
\odot	62	PSEUDERANTHEMUM ATROPURPUREUM	PURPLE ERANTHEMUM	3 GAL				36" O.C.
£ ; ;	104	PSEUDERANTHEMUM RETICULATUM	EL DORADO	3 GAL				36" O.C.
SHRUB AREAS	QTY	BOTANICAL NAME	COMMON NAME	POT			SPACING	REMARKS
	283	DIANELLA SANDWICENSIS	`UKI`UKI COMPACT	6" POT			18" o.c.	
	224	HELICONIA PSITTACORUM	HELICONIA PARROT'S BEAK	1 GAL			24" o.c.	
	2,600	MICROSORTIUM SCOLOPENDRIUM LAUAE IKI	DWARF LAUAE FERN	6" POT			24" o.c.	
	432	WIKSTROEMIA UVA-URSI	`AKIA	1 GAL			24" o.c.	
GROUND COVERS	QTY	BOTANICAL NAME	COMMON NAME	РОТ			SPACING	REMARKS
	21,594 SF	ZOYSIA JAPONICA	ZOYSIA EL TORO	STOLONS				

Converight 2012 Bolt Colling All Dights Docomed

FIELD I	FIELD DIRECTED PLANTING SCHEDULE								
SHRUBS	QTY	BOTANICAL NAME	COMMON NAME	GAL			REMARKS		
25 VIE	15	CODIAEUM VARIEGATUM	CROTON PETRA	5 GAL			FIELD DIRECTED BY LANDSCAPE ARCHITECT		
	25	CORDYLINE FRUTICOSA	GREEN TI	1 GAL			FIELD DIRECTED BY LANDSCAPE ARCHITECT		
\oplus	25	CORDYLINE FRUTICOSA	RED TI	3 GAL			FIELD DIRECT BY LANDSCAOE ARCHITECT		
**	15	CRINUM ASIATICUM	SPIDER LILY	5 GAL			FIELD DIRECTED BY LANDSCAPE ARCHITECT		
\odot	15	DODONAEA VISCOSA	'A'ALI'I	5 GAL			FIELD DIRECTED BY LANDSCAPE ARCHITECT		
\odot	15	GARDENIA TAITENSIS	TIARE GARDENIA	5 GAL			FIELD DIRECTED BY LANDSCAPE ARCHITECT		

MISCELLANI	MISCELLANEOUS								
405 CY	IMPORTED SCREENED SOIL (4" LAYER) POOL ENCLOSURE AREA ONLY								
17,302 SF	SOIL PREPARATION (1" LAYER HAWAIIAN EARTH PRODUCTS ORGANIC SOIL CONDITIONER / COMPOST, ROTO-TILL 6" DEEP INTO SOIL) FOR SHRUB AND GROUND COVER AREAS								
106.93 CY	MULCH (2" LAYER) FOR ALL SHRUB/GROUNDCOVER BEDS								
1,732 LF	POLY HEADER								
422 LF	ROOT BARRIER								
3.67 CY	NO. 3B FINE BLUE ROCK GRAVEL MAINTENANCE STRIP (3" LAYER)								
397 SF	WEED CONTROL FABRIC								
2.5 CY	BLACK CINDER (3" LAYER)								

PLANTING NOTES:

1. CONTRACTOR SHALL RESTORE ALL GRASS DAMAGED BY CONSTRUCTION AND MATCH EXISTING.

- 2. CONTRACTOR SHALL STORE AND MAINTAIN EXISTING TREES TO BE RELOCATED FROM THE BEGINNING OF CONSTRUCTION UNTIL THE TIME OF PLANTING.
- 3. PROVIDE 4" OF PLANTING SOIL OVER ALL PLANTING AREAS.
- 4. PROVIDE 2" COVER OF MULCH OVER ALL PLANTING AREAS.
- 5. BACKFILL MIX SHALL CONSIST OF FOUR (4) PARTS OF AMENDED IMPORTED PLANTING SOIL TO ONE (1) PART ORGANIC SOIL CONDITIONER (SEE SPECIFICATIONS). ADD ONE (1) POUND OF 10-30-10 FERTILIZER TO ONE (1) CUBIC YARD OF BACKFILL MIX. MIX THOROUGHLY ON PROJECT SITE PRIOR TO ANY PLANTING OPERATIONS.
- 6. INDICATED BACKFILL MIX IS FOR BIDDING PURPOSES ONLY. A SOIL ANALYSIS WITH RECOMMENDATIONS WILL BE REQUIRED AND TAKE PRECEDENCE OVER THE INDICATED MIXTURE.
- 7. PLANTING TABLETS FOR TREES AND SHRUBS SHALL BE AS FOLLOWS:

FIELD SPECIMEN	12 TABLET
25 GALLON	8 TABLETS
15 GALLON	5 TABLETS
5 GALLON	3 TABLETS
3 GALLON	2 TABLETS
1 GALLON	1 TABLET

USE SLOW RELEASE FERTILIZER TABLETS 20-10-5, 21 GRAM SIZE.

- 8. GROUNDCOVER SHALL BE PLANTED UNDER ALL TREES, PALMS AND SHRUBS (UNLESS OTHERWISE NOTED ON PLANS).
- 9. QUANTITIES ARE SHOWN FOR THE CONVENIENCE OF THE CONTRACTOR ONLY. THE CONTRACTOR SHALL PERFORM ITS OWN QUANTITY ESTIMATES FOR THE PURPOSES OF BIDDING AND CONSTRUCTION. THE CONTRACTOR SHALL PROVIDE PLANTS AND OTHER MATERIALS IN THE QUANTITIES NECESSARY TO COMPLETE THE INSTALLATION AS SHOWN ON THE DRAWINGS.
- 10. NEW ZOYSIA GRASS WITHIN POOL ENCLOSURE AREA AND NEW OPEN PARK AREA ONLY. ALL OTHER GRASS AREA TO REMAIN.

11. IMPORTED SCREENED SOIL FOR POOL ENCLOSURE AND NEW OPEN PARK AREA ONLY. SEE SHEET L400.

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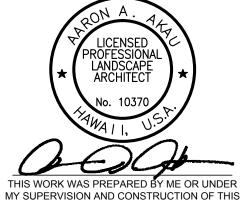
Consultant

Client & Project

Kalaeloa Partners

Site Amenities Improvements

Kalaeloa Rental Homes Síte Kalaeloa, Oahu, Hawaii



PROJECT WILL BE UNDER MY OBSERVATION.

APRIL 30, 2018

EXPIRATION DATE
OF THE LICENSE

Revisions

1 REVISED LIST AND NO
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Sheet

PLANT MATERIAL SCHEDULE AND NOTES

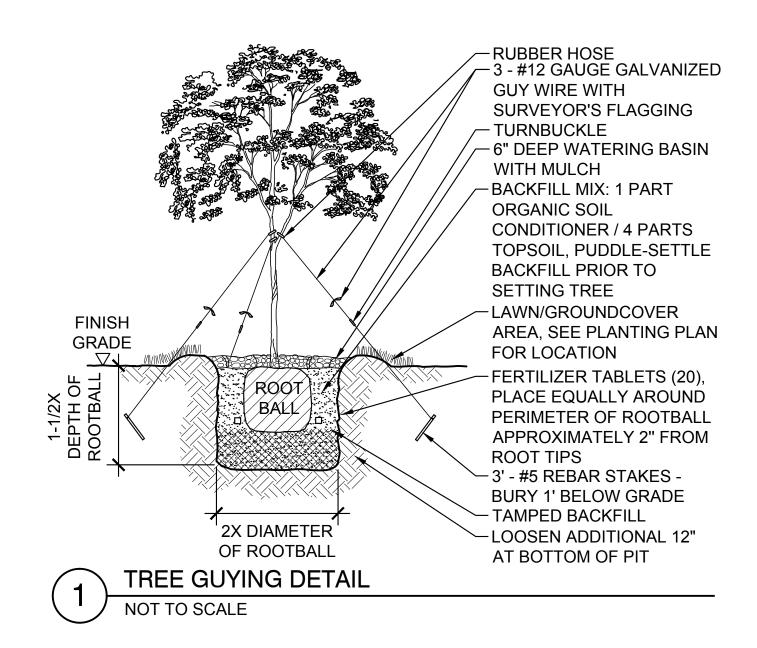
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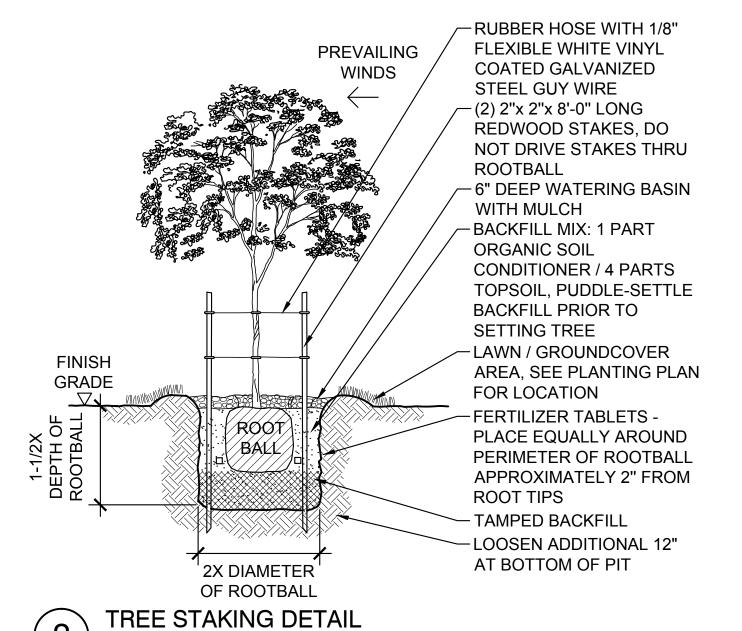
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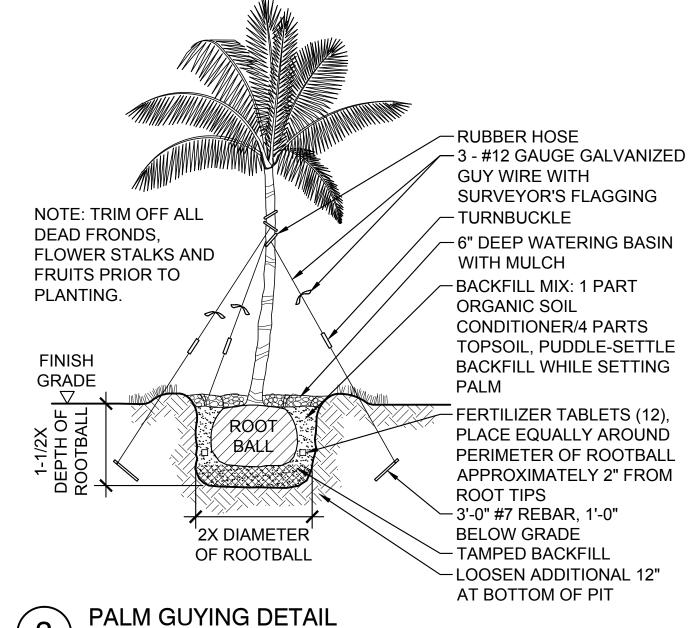
CS, RS, CH Date:

APRIL 2017

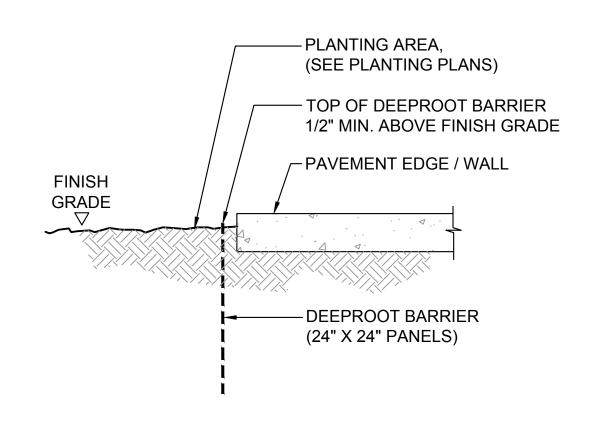
L405







-GROUNDCOVER PLANT



INSTALL AS PER MANUFACTURER'S INSTRUCTIONS.

A = SPECIFIED DIMENSION ON CENTER 'O.C.' B = STAGGER PLANTING WITH ADJACENT ROW(S) DIMENSION 'A' DIVIDED BY 2


STAGGERED GROUNDCOVER

NOT TO SCALE


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NOT TO SCALE

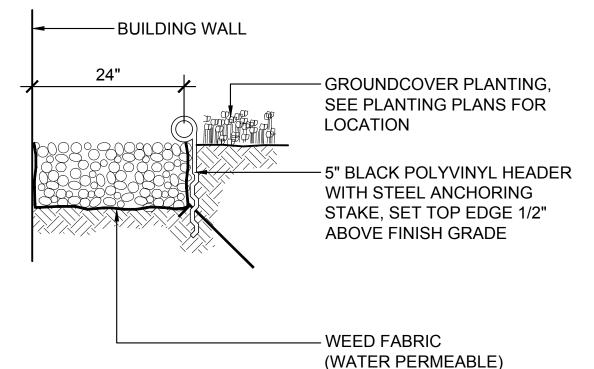
ROOT BARRIER DETAIL NOT TO SCALE



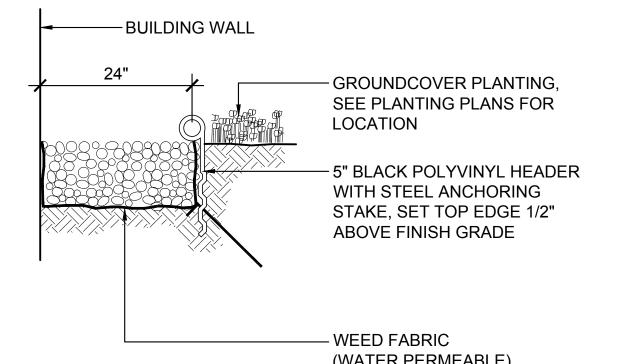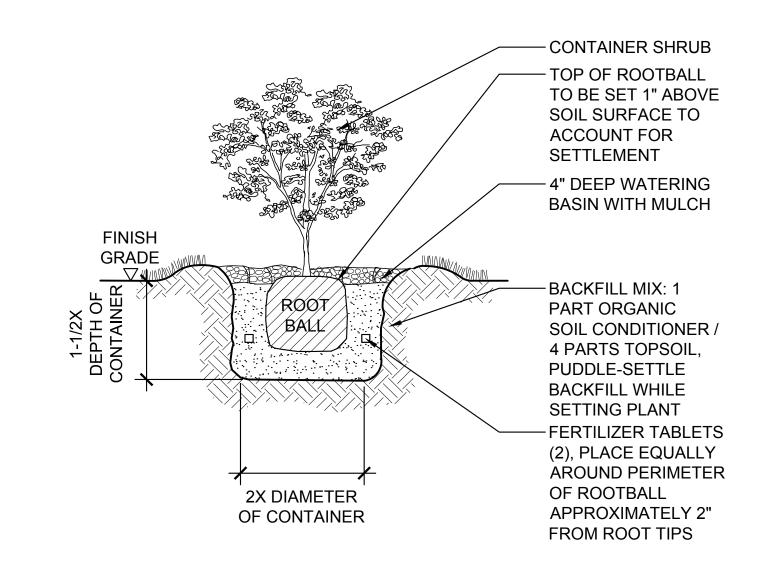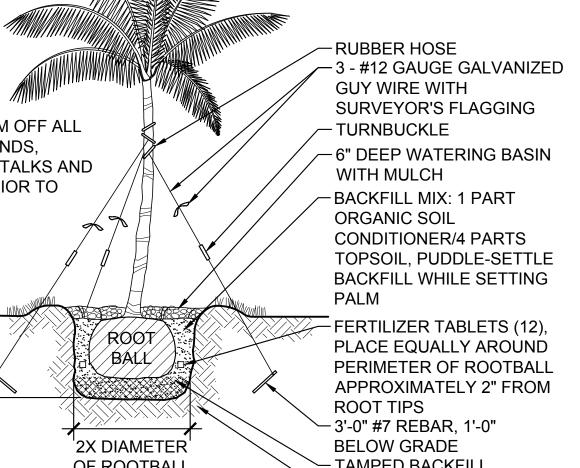
POLY HEADER / GRAVEL DETAIL NOT TO SCALE











Client & Project Kalaeloa Partners

> Improvements Kalaeloa Rental Homes Site

Site Amenities

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APRIL 30, 2018
EXPIRATION DATE OF THE LICENSE

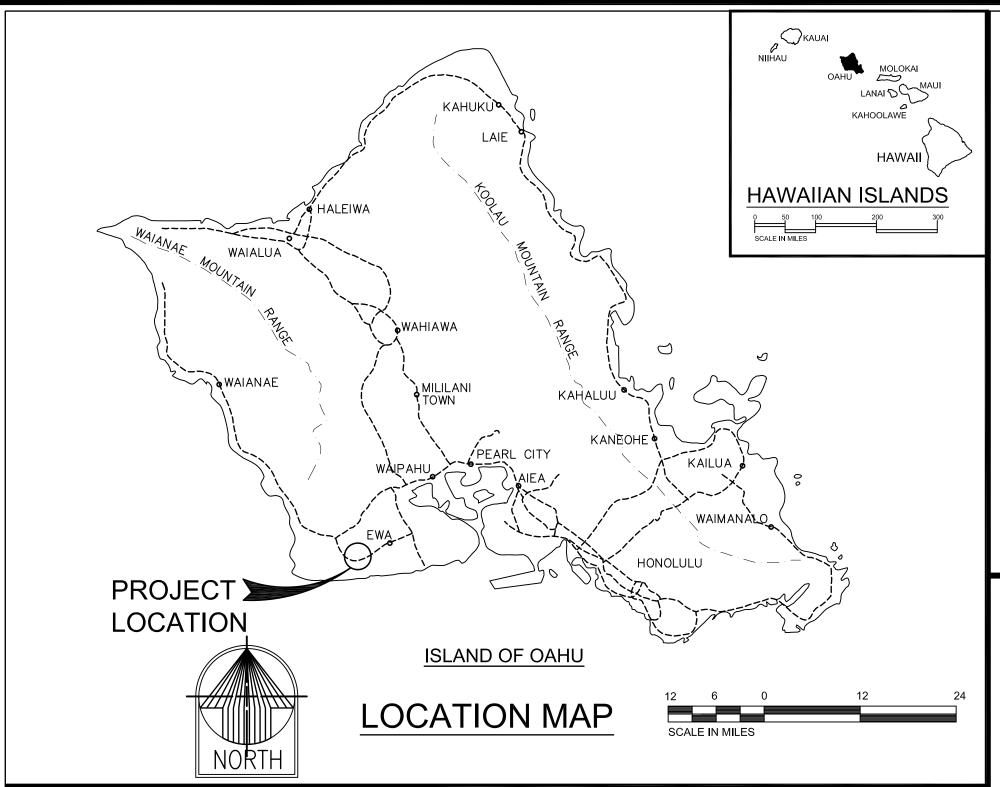
Revisions

Sheet

PLANTING DETAILS

Project No. 2015.33.0601 Designed by:

Drawn by: CS, RS, CH Date:



PROJECT

SITE

SCALE IN FEET

VICINITY MAP

SITE AMENITIES IMPROVEMENTS SWIMMING POOL KALAELOA RENTAL HOMES SITE

LOCATED AT: KALAELOA, OAHU, HAWAII TMK: FIRST DIVISION, 9-1-013:014

PREPARED FOR: DINAPOLI CAPITAL PARTNERS 5532 LILLEHAMMER LANE, SUITE 200 PARK CITY, UT 84098

DRAWING INDEX

DWG. No.	SHT. No.	DESCRIPTION
1.	WF001	GENERAL NOTES & DRAWING INDEX
2.	WF002	OVERALL SITE PLAN
3.	WF101	SWIMMING POOL PLAN
4.	WF102	SWIMMING POOL SHELL PLAN
5.	WF103	SWIMMING POOL DEPTH MARKER PLAN
6.	WF104	CHILDREN'S POOL PLAN
7.	WF105	CHILDREN'S POOL SHELL PLAN
8.	WF106	CHILDREN'S POOL DEPTH MARKER PLAN
9.	WF201	SECTIONS
10.	WF202	SECTIONS
11.	€WF203	SECTIONS
12.	WF204	SECTIONS
13.	WF300	SWIMMING POOLS PIPE RUNS PLAN
14.	WF301	SWIMMING POOL FITTINGS PLAN
15.	WF302	SWIMMING POOL PIPING SCHEMATIC
16.	WF303	CHILDREN'S POOL FITTINGS PLAN
17.	WF304	CHILDREN'S POOL PIPING SCHEMATIC
18.	WF401	EQUIPMENT LAYOUT, LIST AND SYSTEM ANALYSIS
19.	WF501	TYPICAL DETAILS
20.	WF502	TYPICAL DETAILS
21.	WF503	TYPICAL DETAILS
22.	WF504	TYPICAL DETAILS
23.	WF601	SWIMMING POOL LIGHTING PLAN
24.	WF602	CHILDREN'S POOL LIGHTING PLAN
25.	WF701	EQUIPMENT PAD ELECTRICAL PLAN, SINGLE LINE DIAGRAM PANEL SCHEDULE, ENERGY BUDGET

PLUMBING STANDARDS

- CROSS-CONNECTION SHALL BE PREVENTED BY:
 - APPROVED PRESSURE VACUUM BREAKER <u>FEBCO #765</u> INSTALLED AT 12" ABOVE FLOOD LEVEL.
- BACKWASH OF FILTER SHALL BE PIPED TO:
 - IRRIGATION ON SITE.
 - SANITARY SEWER THROUGH AN APPROVED AIR-GAP.
- 3. TO EMPTY POOL, DRAIN TO DRYWELL VIA FILTRATION BACKWASH OR PORTABLE PUMP.

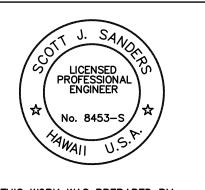
ELECTRICAL STANDARDS FOR SWIMMING POOLS

- THE FOLLOWING IS A BRIEF SUMMARY OF THE REQUIREMENTS FOR
 - FOR SPECIFIC DETAILS AND EXCEPTIONS, REFER TO ARTICLE 680A-E, NATIONAL ELECTRICAL CODE, 2008 EDITION.
- ALL ELECTRICAL EQUIPMENT TO BE U/L APPROVED FOR THE PURPOSE.
- BONDING CONDUCTOR FOR WATER FEATURE REINFORCING STEEL AND OTHER METALLIC EQUIPMENT TO BE #8 AWG SOLID COPPER CONDUCTOR.
- NO ATTACHMENT PLUG RECEPTACLES SHALL BE INSTALLED WITHIN 10 FEET OF THE INSIDE WALLS OF POOLS. ALL 125-VOLT RECEPTACLES LOCATED WITHIN 20 FEET FROM THE WATER FEATURE SHALL BE PROTECTED BY A GROUND-FAULT CIRCUIT INTERRUPTER (GFCI).
- IF LIGHTING FIXTURES AND LIGHTING OUTLETS ARE LOCATED:
- SEE ARTICLE 680 FOR EXCEPTIONS TO (A) AND (B) ABOVE. SWITCHING DEVICES ON THE PROPERTY MUST BE LOCATED AT LEAST 5
- UNDERGROUND WIRING SHALL NOT BE PERMITTED UNDER THE POOL OR UNDER THE AREA EXTENDING 5 FEET HORIZONTALLY FROM THE INSIDE WALL OF THE POOL.
- ANY UNDERWATER LIGHTING FIXTURE OVER 15 VOLTS SHALL BE PROTECTED
- FOUNTAINS, FOUNTAIN POOLS, ORNAMENTAL DISPLAY POOLS AND **REFLECTOR POOLS:**
 - LIGHTING FIXTURES, SUBMERSIBLE PUMPS AND OTHER SUBMERSIBLE EQUIPMENT, CORD AND PLUG-CONNECTED EQUIPMENT SHALL BE PROTECTED BY A GFCI.
- CONDUIT REQUIREMENTS:
 - A.) MINIMUM SIZE: 3/4 INCH UNLESS OTHERWISE SPECIFIED.
 - B.) UNDERGROUND INSTALLATIONS AT POOL ENVELOPE SCHEDULE 40
 - C.) IN OR UNDER SLAB ON GRADE 40 PVC CONDUIT OR PLASTIC COATED RIGID STEEL CONDUIT.
 - D.) IN SLAB ABOVE GRADE 40 PVC CONDUIT.
 - WET AND DAMP LOCATIONS GALVANIZED RIGID STEEL CONDUIT .
 - DRY LOCATIONS CONCEALED: ELECTRICAL METALLIC TUBING. EXPOSED: GALVANIZED RIGID STEEL CONDUIT.
- **WIRING METHODS:**
 - A.) USE SOLID CONDUCTOR FOR FEEDERS AND BRANCH CIRCUITS 10 AWG AND SMALLER.
 - B.) USE STRANDED CONDUCTORS FOR CONTROL CIRCUITS.
 - USE CONDUCTORS NO SMALLER THAN 12 AWG FOR POWER AND
 - D.) USE CONDUCTORS NO SMALLER THAN 14 AWG FOR CONTROL CIRCUITS. USE 10 AWG CONDUCTORS FOR 20 AMPERE, 120 VOLT BRANCH
 - CIRCUITS LONGER THAN 75 FEET.
 - F.) USE 10 AWG CONDUCTORS FOR 20 AMPERE, 277 VOLT BRANCH CIRCUITS LONGER THAN 200 FEET.
 - G.) COMBINE UP TO THREE 1 POLE 20 AMP CIRCUITS IN ONE CONDUIT
 - USING OPPOSITE PHASE LEGS ONLY.
 - H.) USE ONLY SERVICE-ENTRANCE CABLE FOR UNDERGROUND INSTALLATION IN CONDUIT.

GENERAL SPECIFICATIONS

- 1. ALL MATERIALS AND ALL WORKMANSHIP SHALL COMPLY WITH
- ALL APPLICABLE STATE AND LOCAL CODES AND REGULATIONS.
- 2. ALL GUNITE SHALL BE 3500 PSI MINIMUM AT 28 DAYS.
- ALL REINFORCING SHALL CONFORM TO ASTM-A615, GRADE 40.
- 4. ALL PIPING SHALL BE PVC, SCHEDULE 40/80 WITH EXCEPTIONS AS NOTED.
- SUPPORTING SOIL SHALL BE UNDISTURBED, UNIFORM, NATURAL SOIL CAPABLE OF SUPPORTING 1000 POUNDS PER SQUARE FOOT. IF ANY OTHER CONDITIONS ARE ENCOUNTERED, BUILDER SHALL NOTIFY ENGINEER.





		DATE	DESCRIPTION
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GENERAL NOTES AND DRAWING INDEX

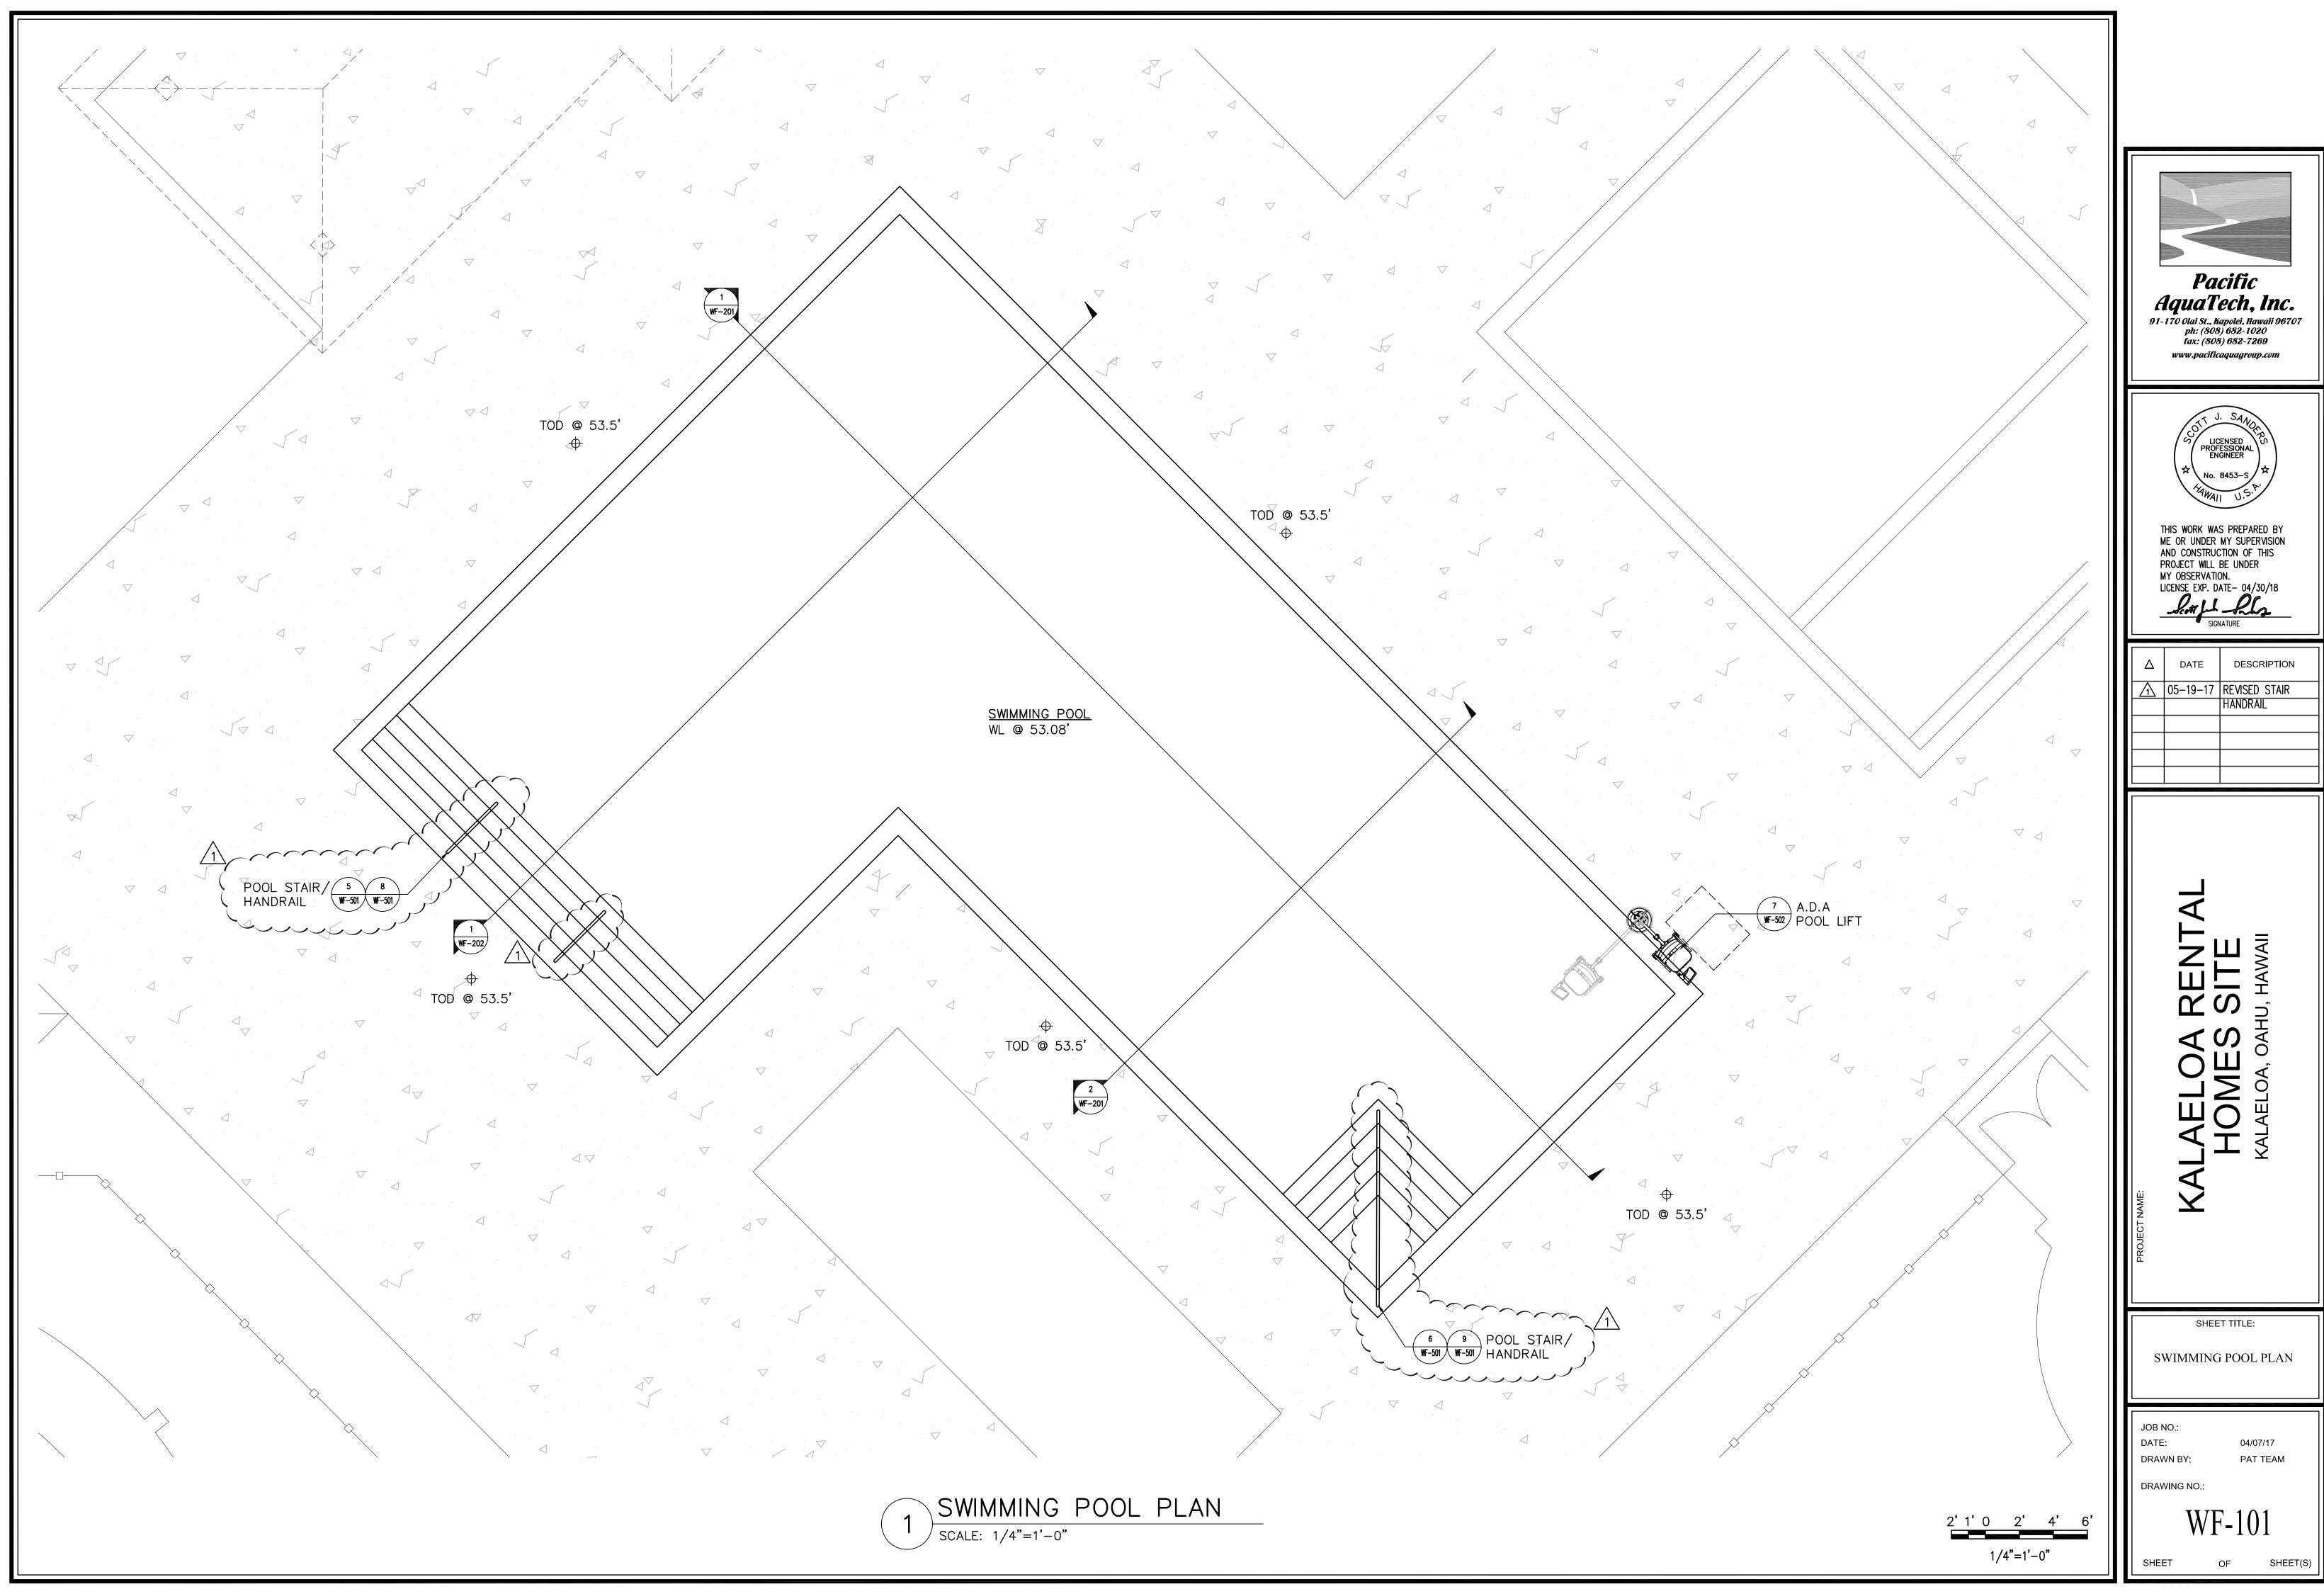
04/07/17

PAT TEAM

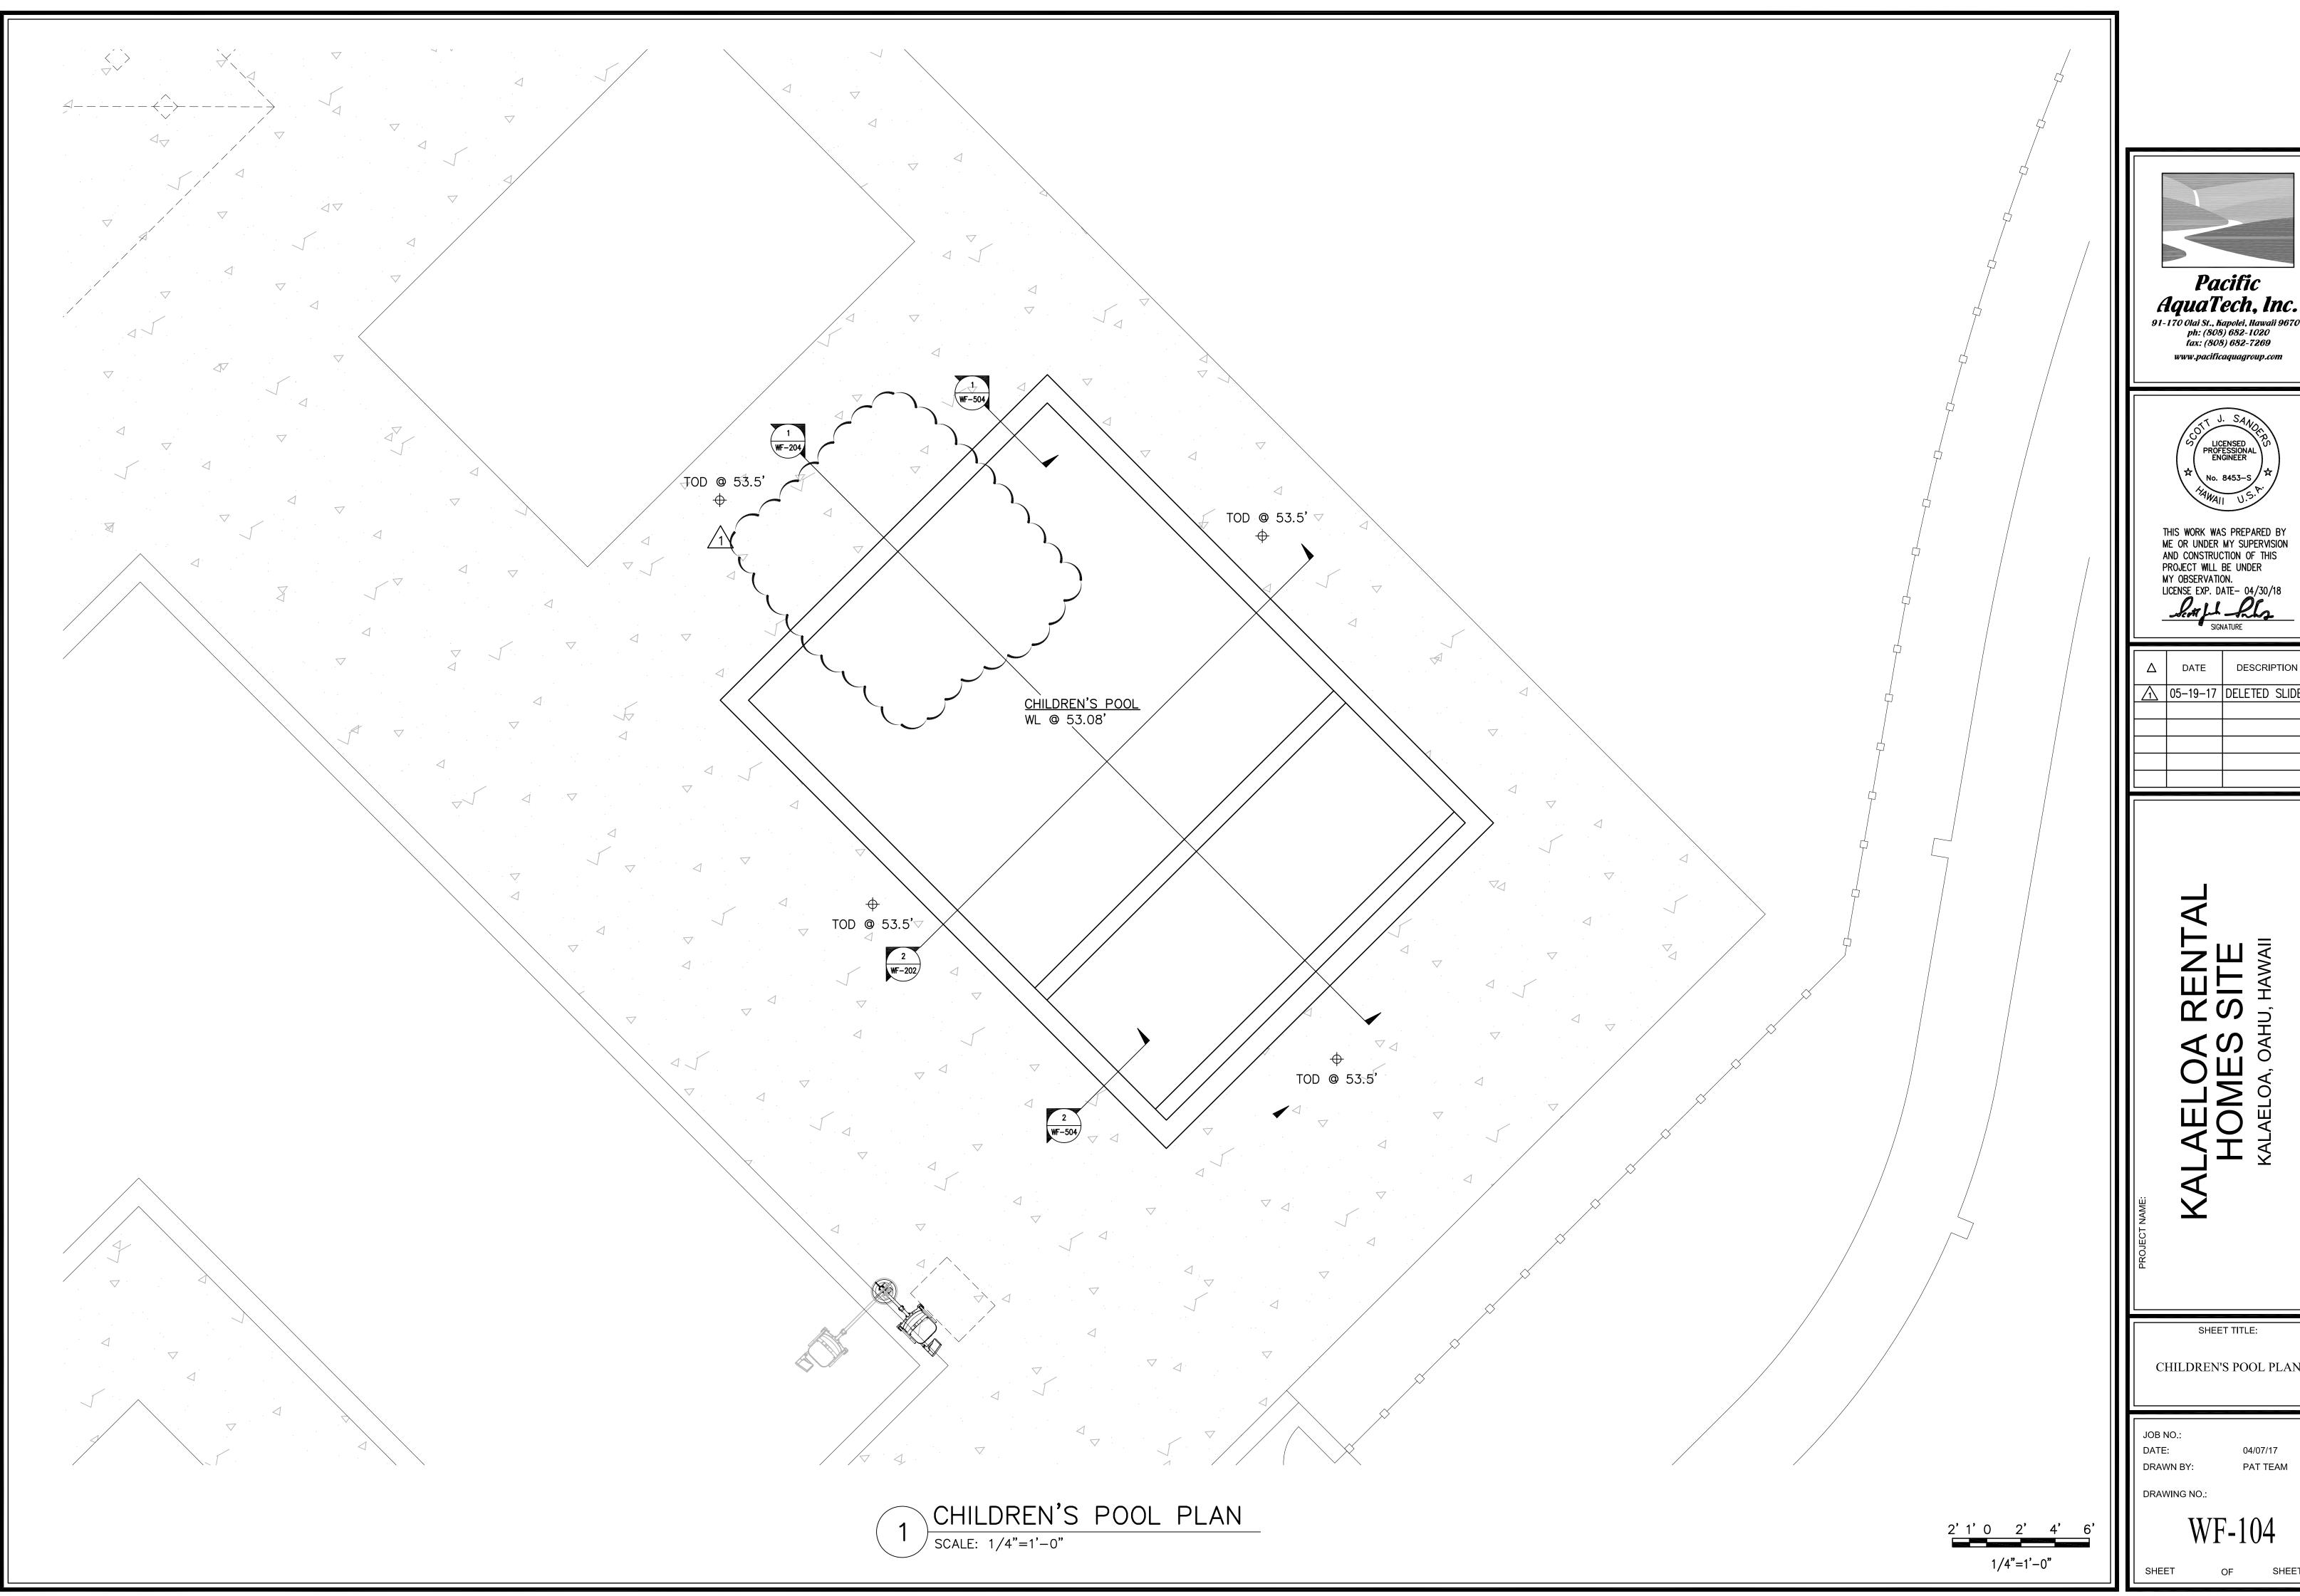
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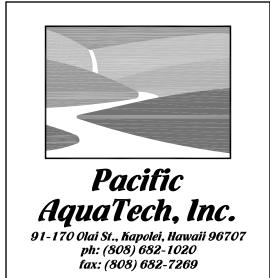
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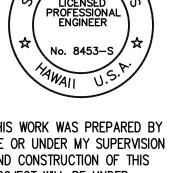


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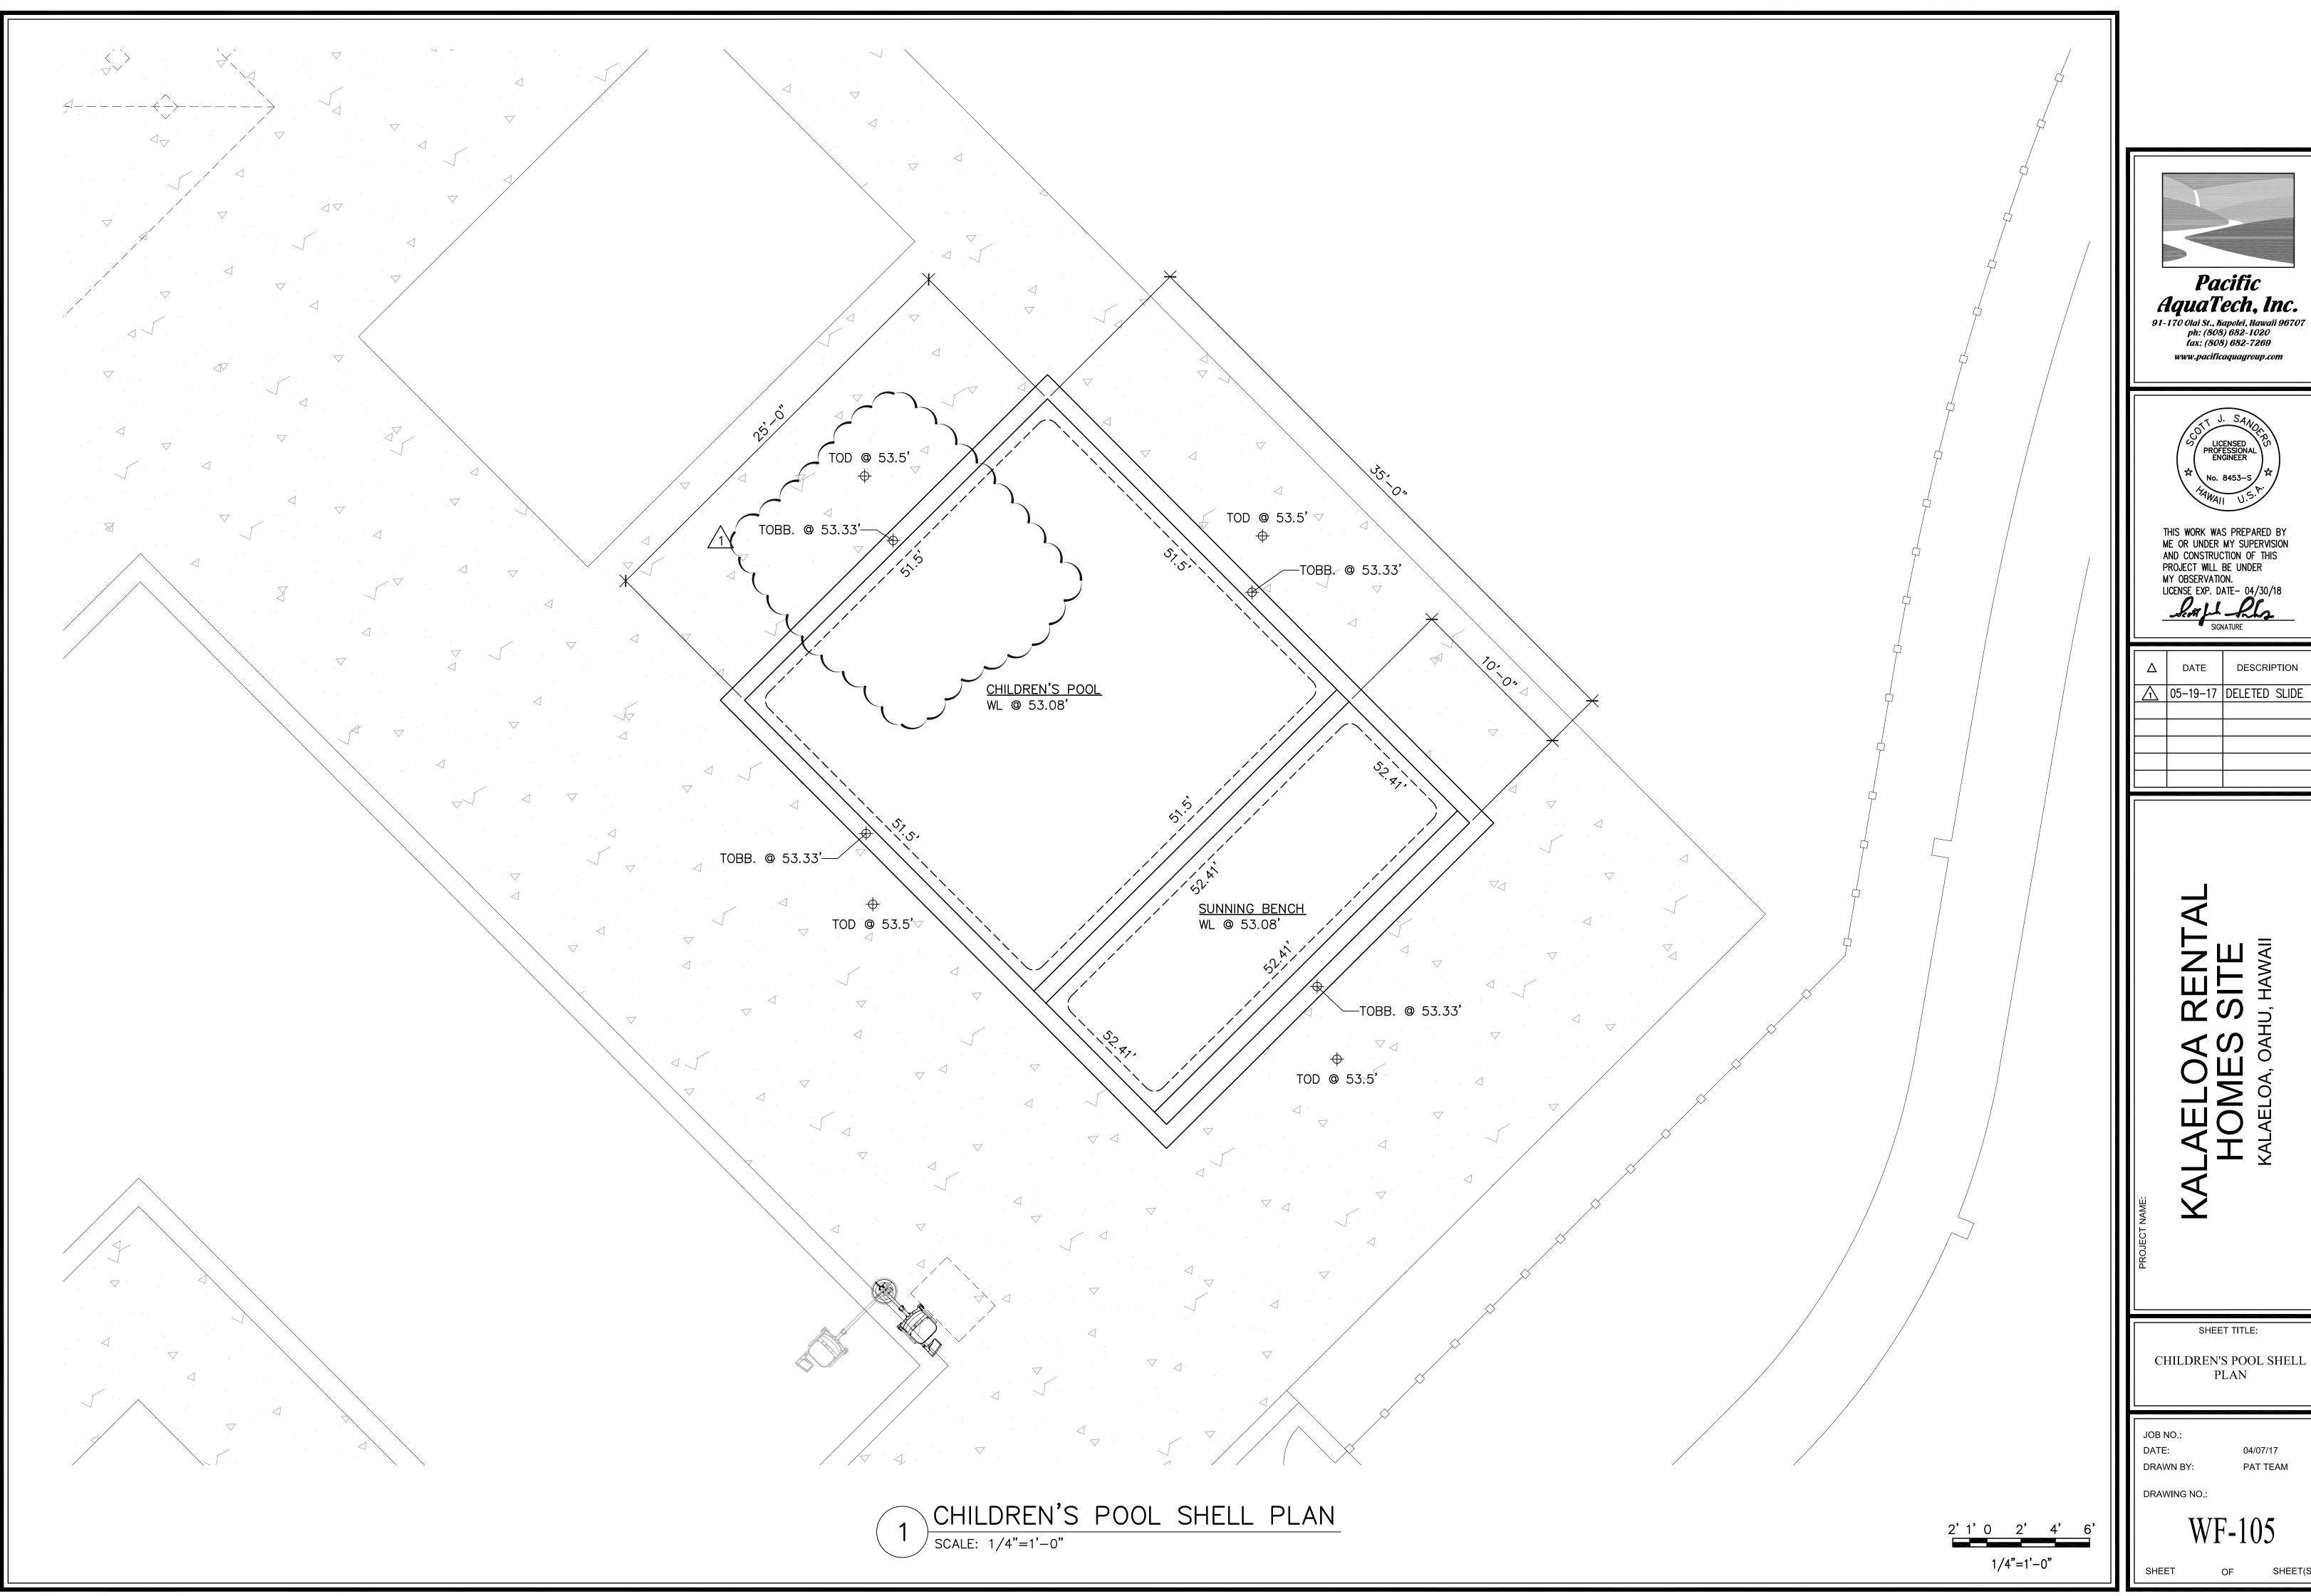




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CHILDREN'S POOL PLAN








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CHILDREN'S POOL SHELL PLAN



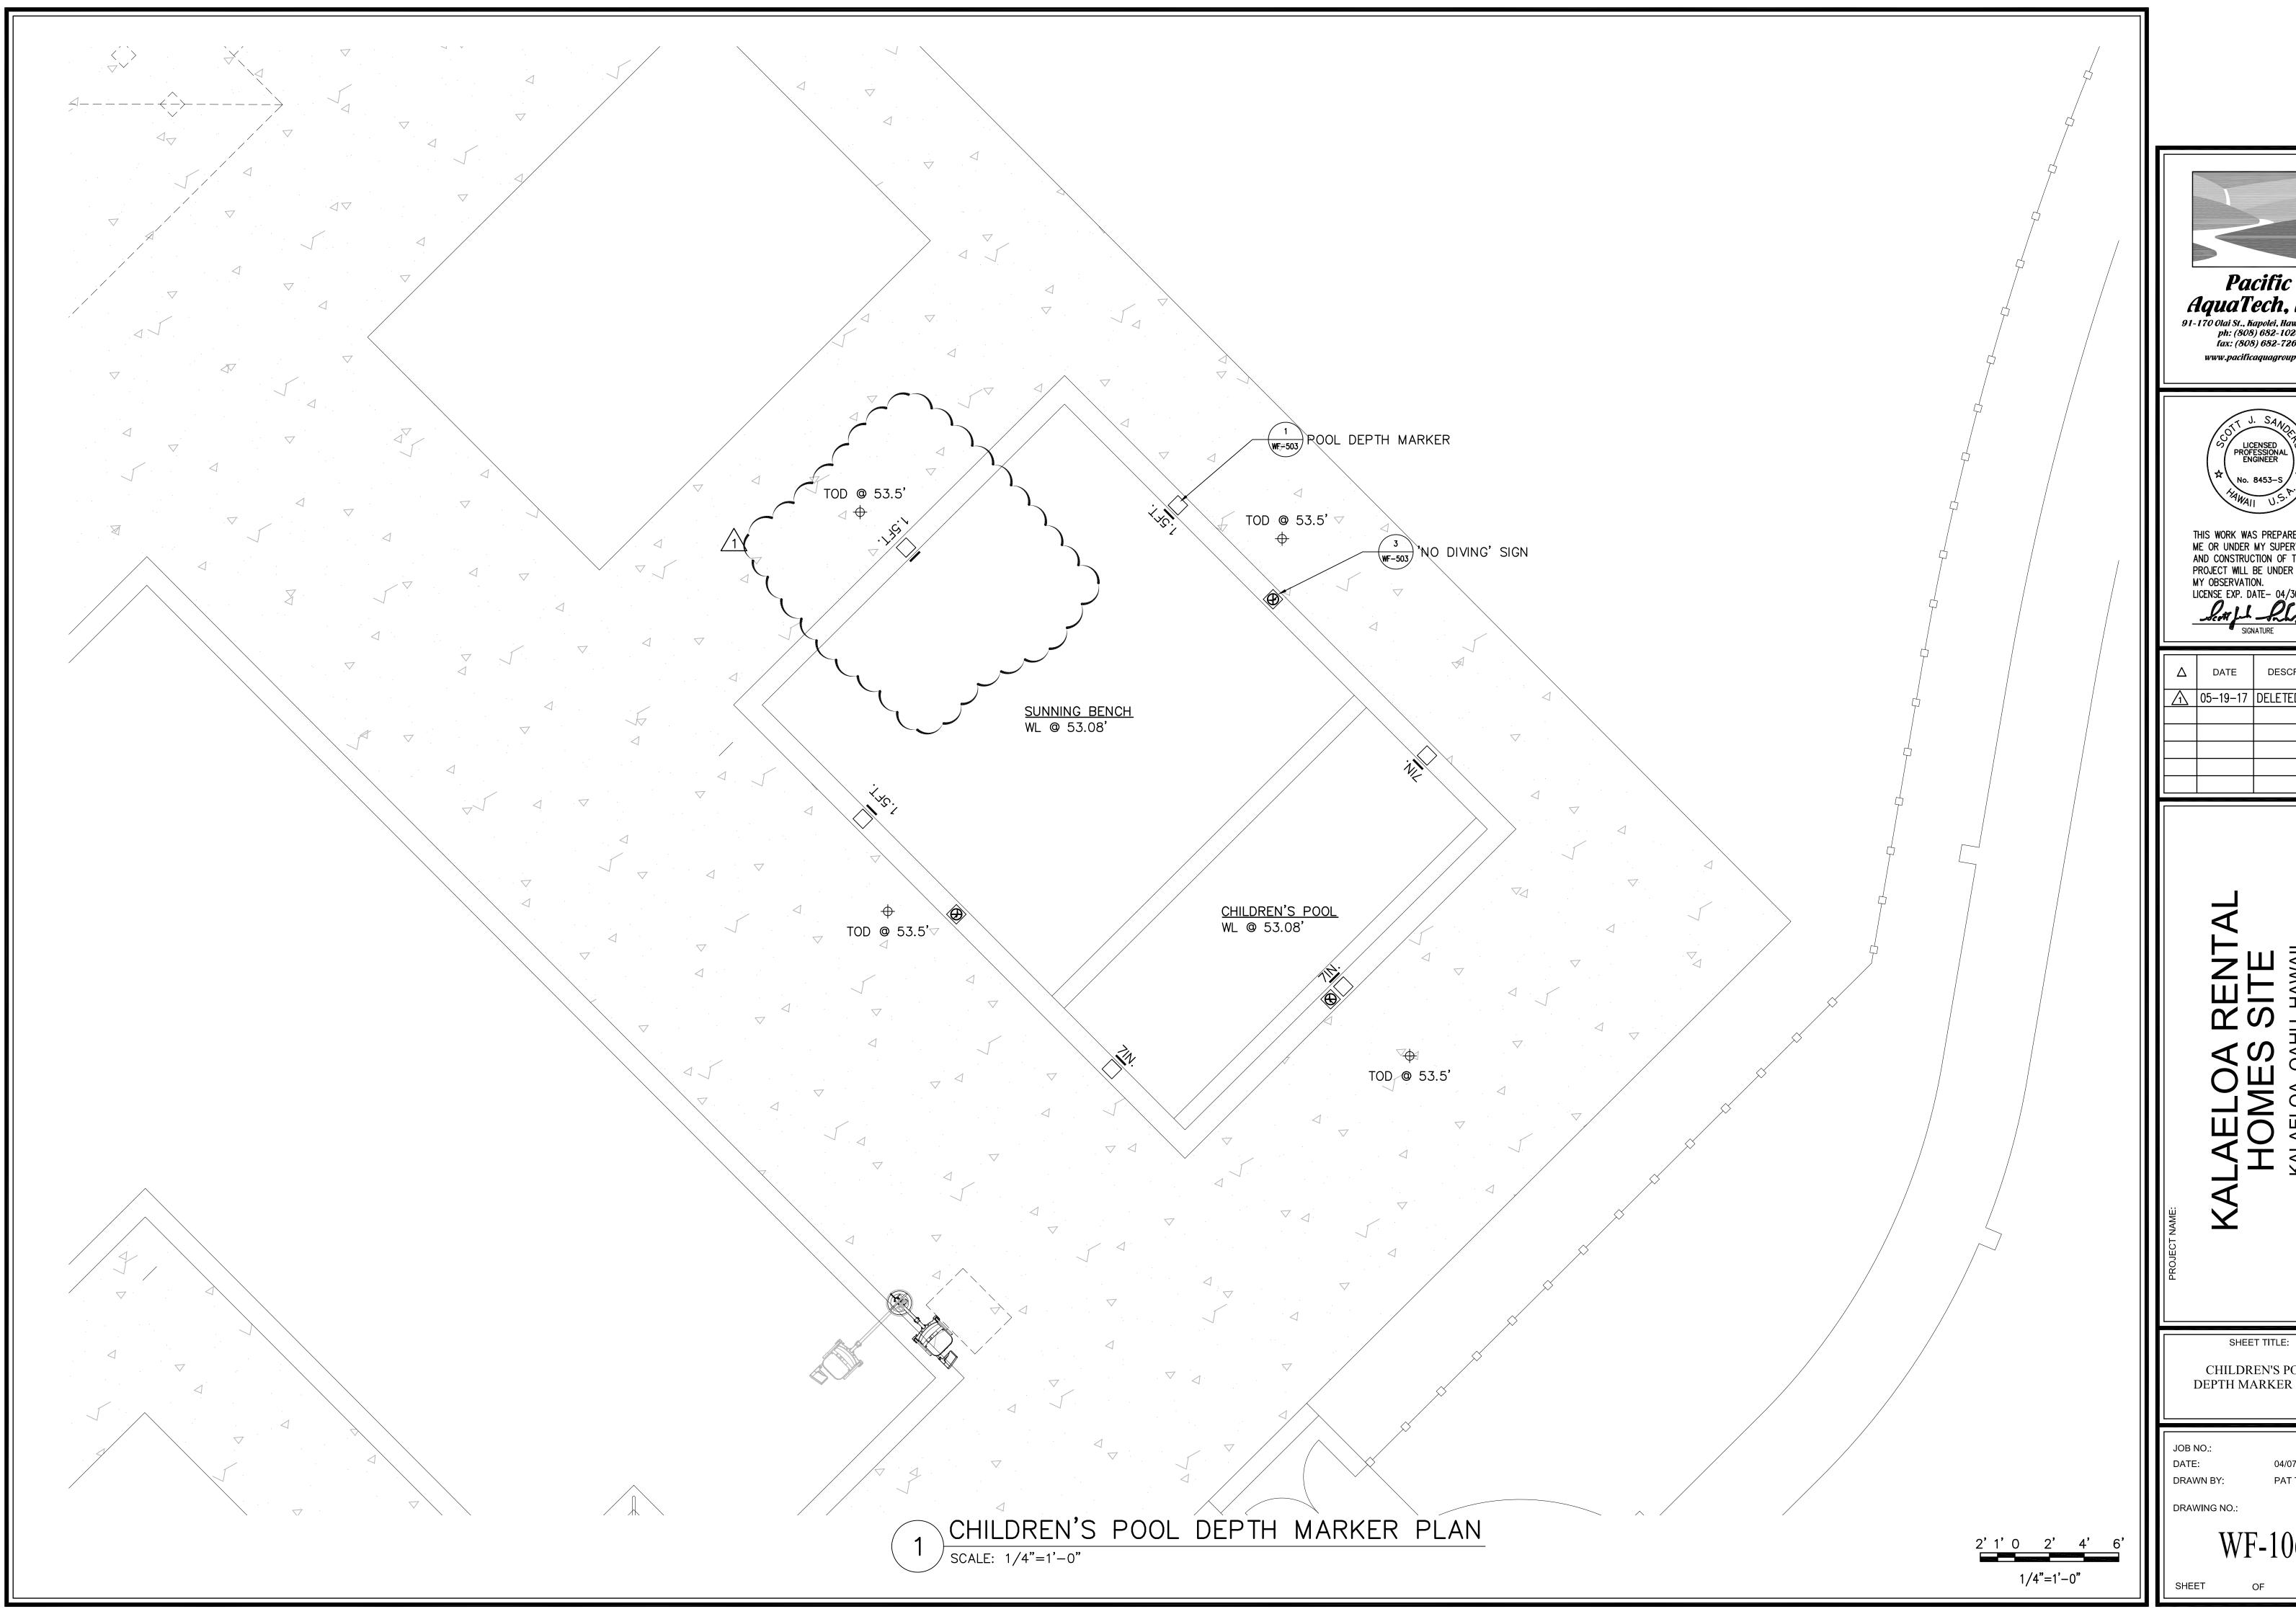

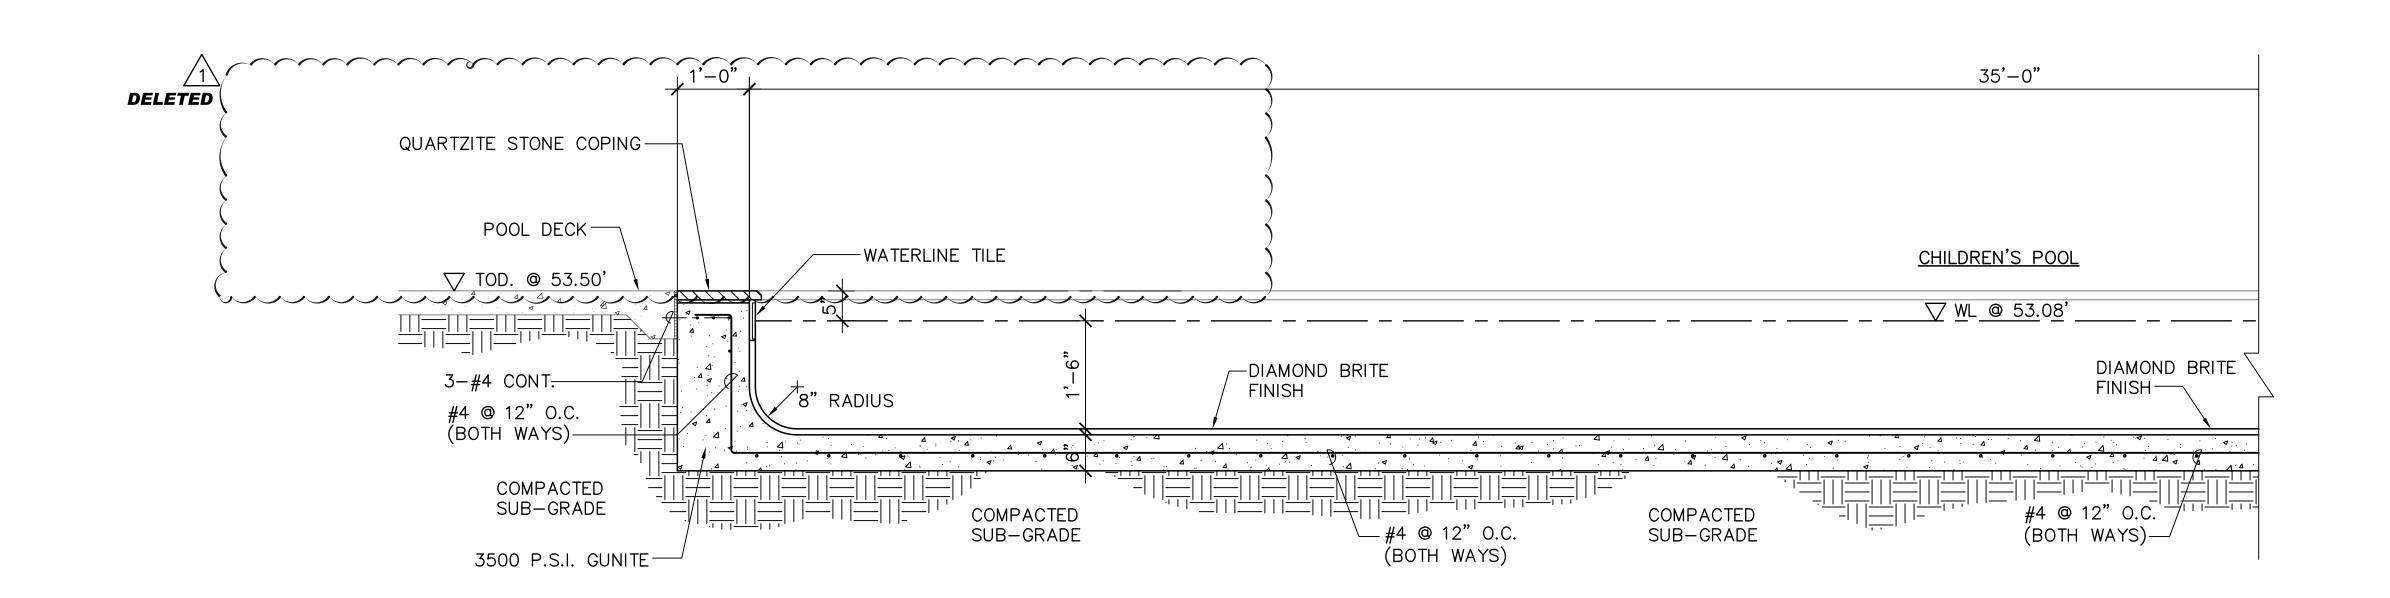
91-170 Olai St., Kapolei, Hawaii 96707 ph: (808) 682-1020 fax: (808) 682-7269 www.pacificaquagroup.com

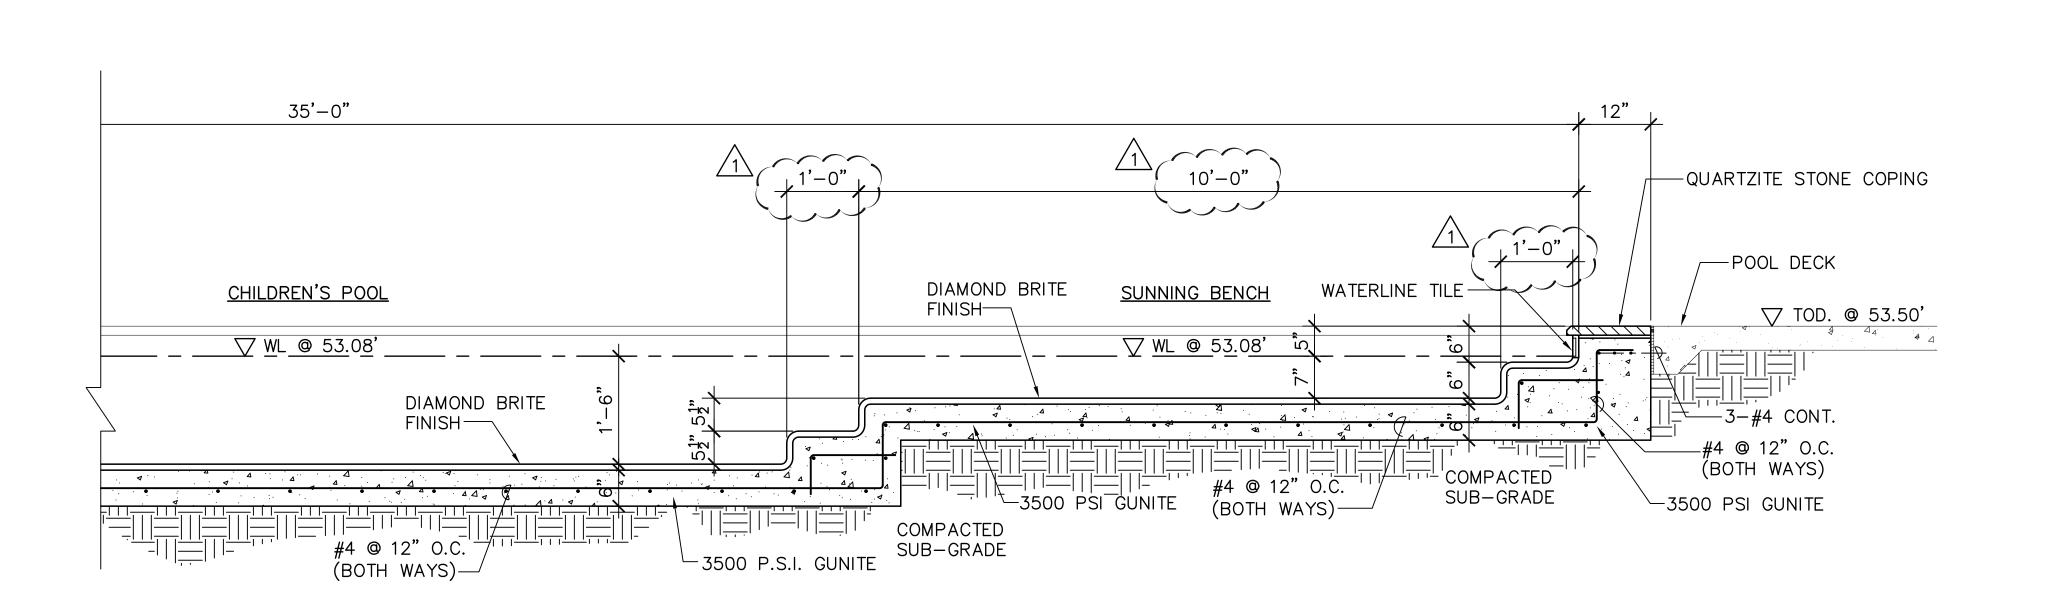


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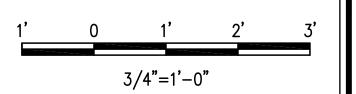
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CHILDREN'S POOL DEPTH MARKER PLAN













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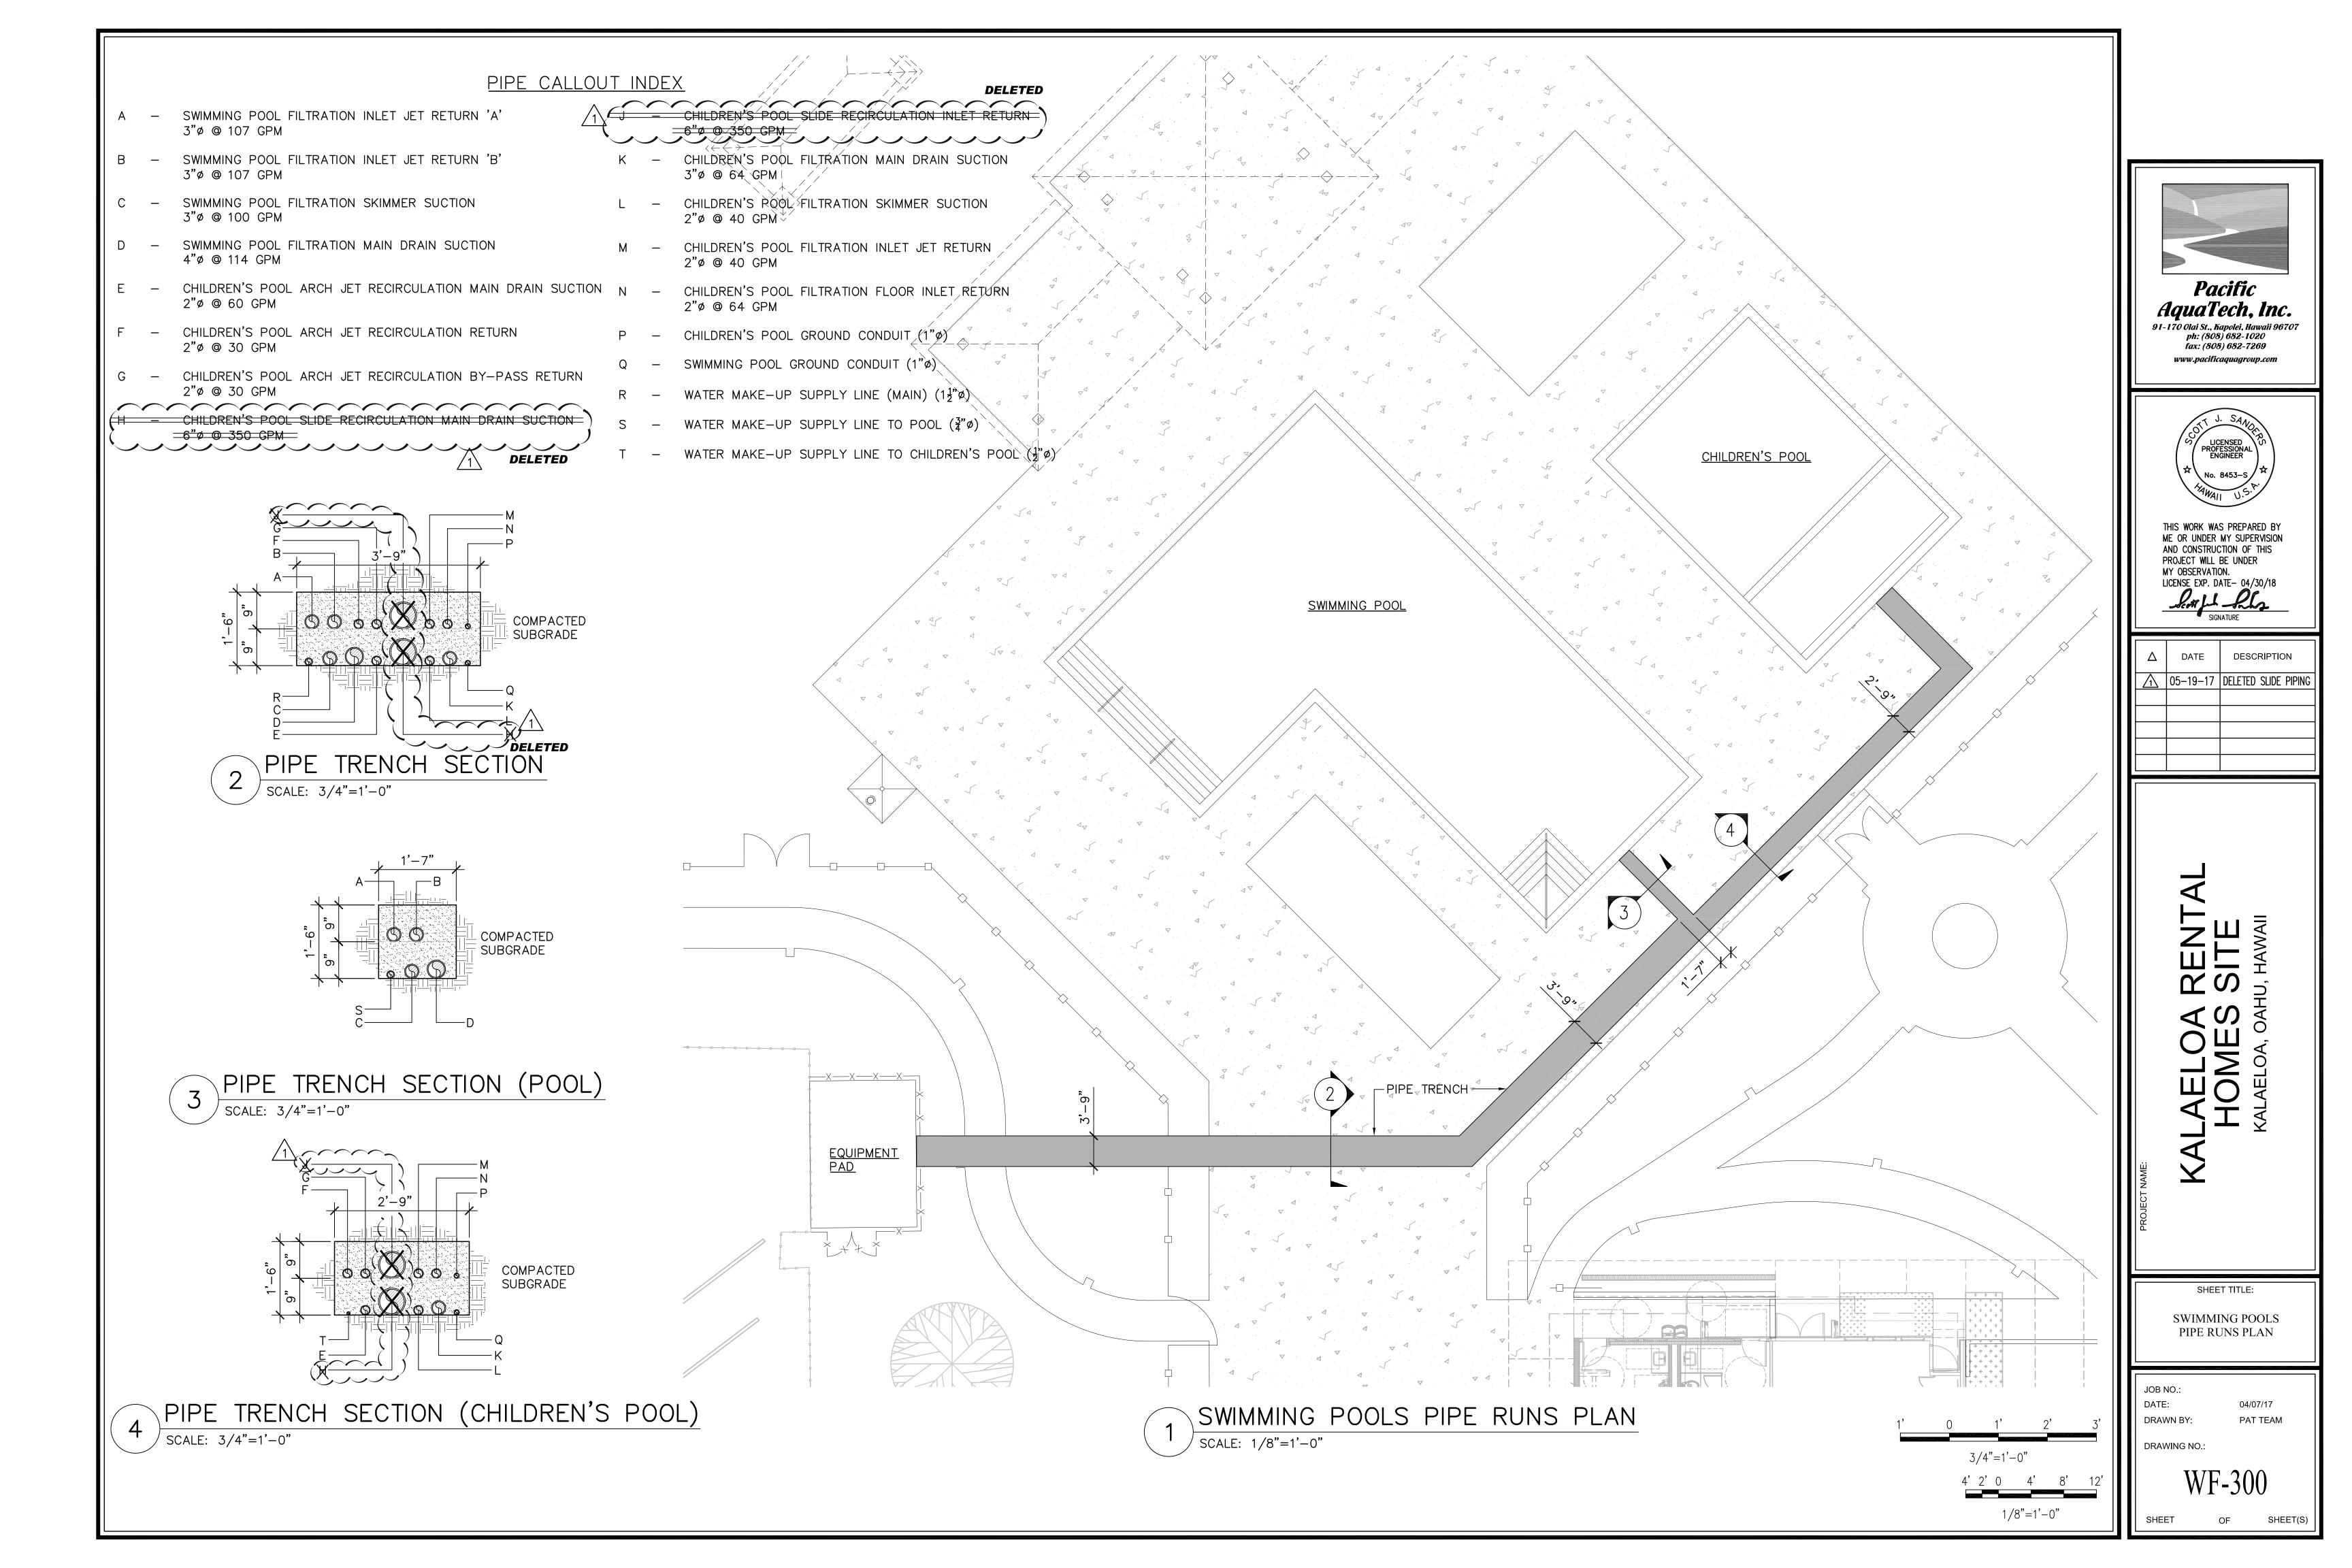
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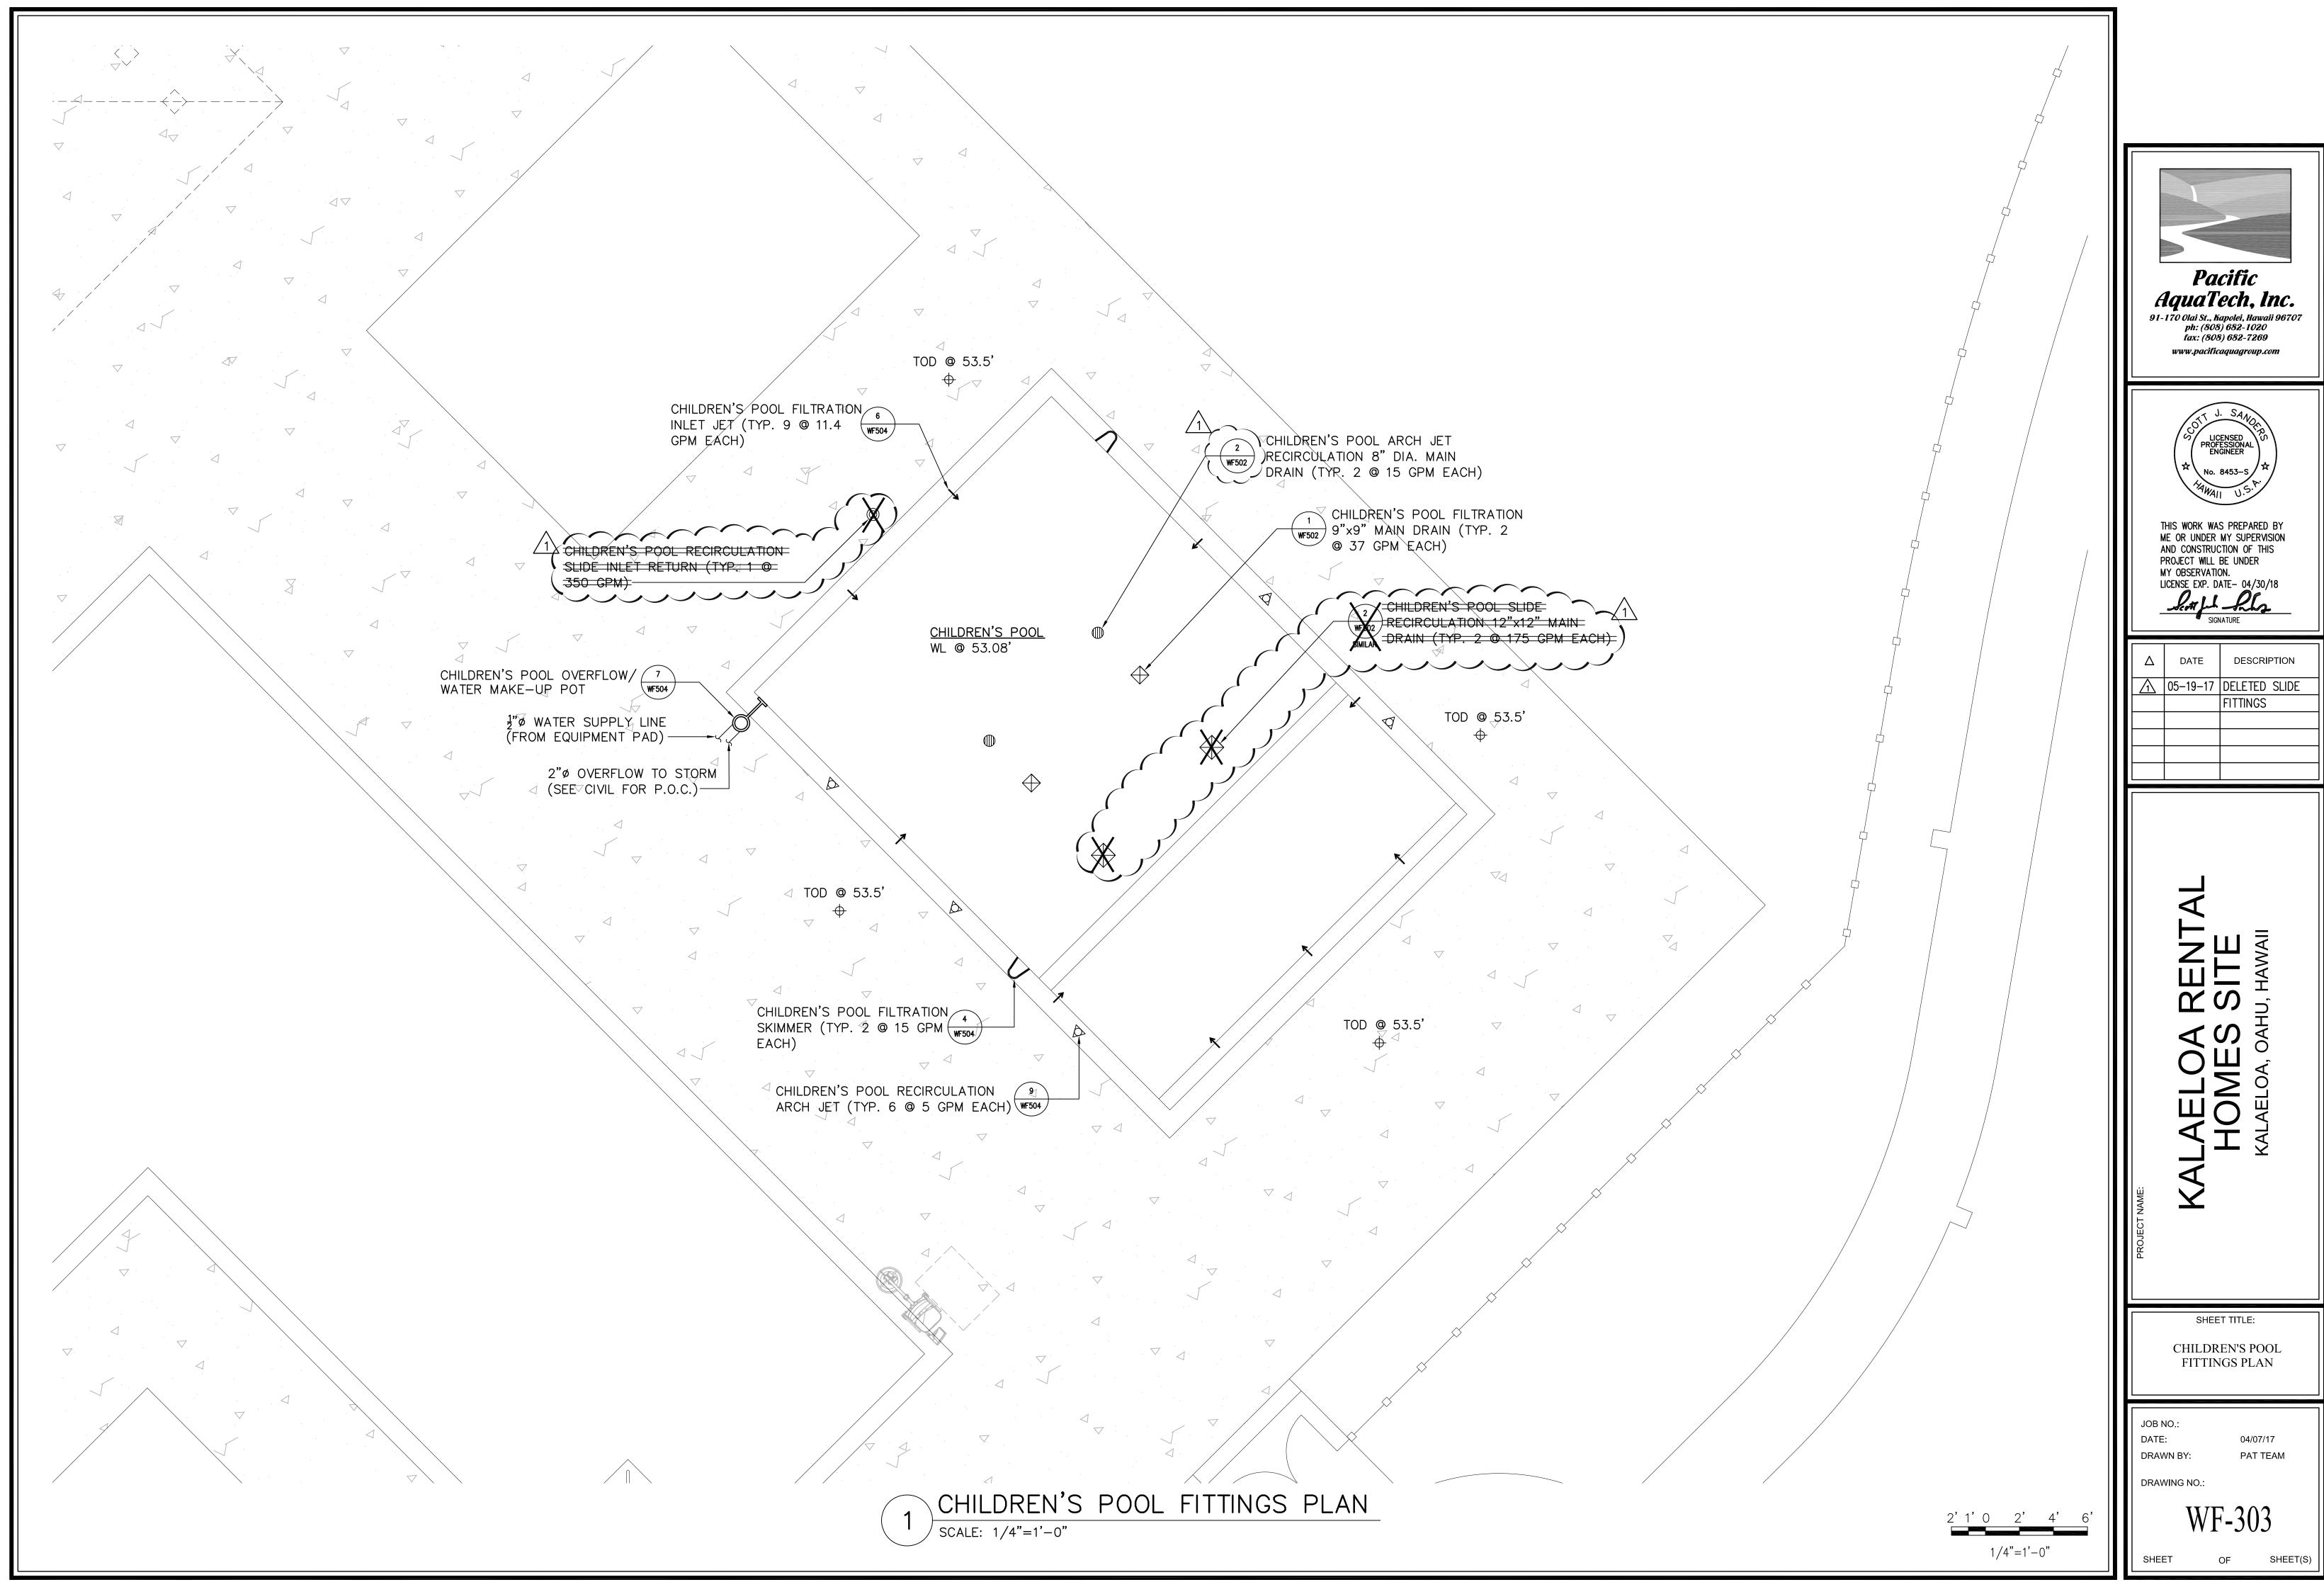
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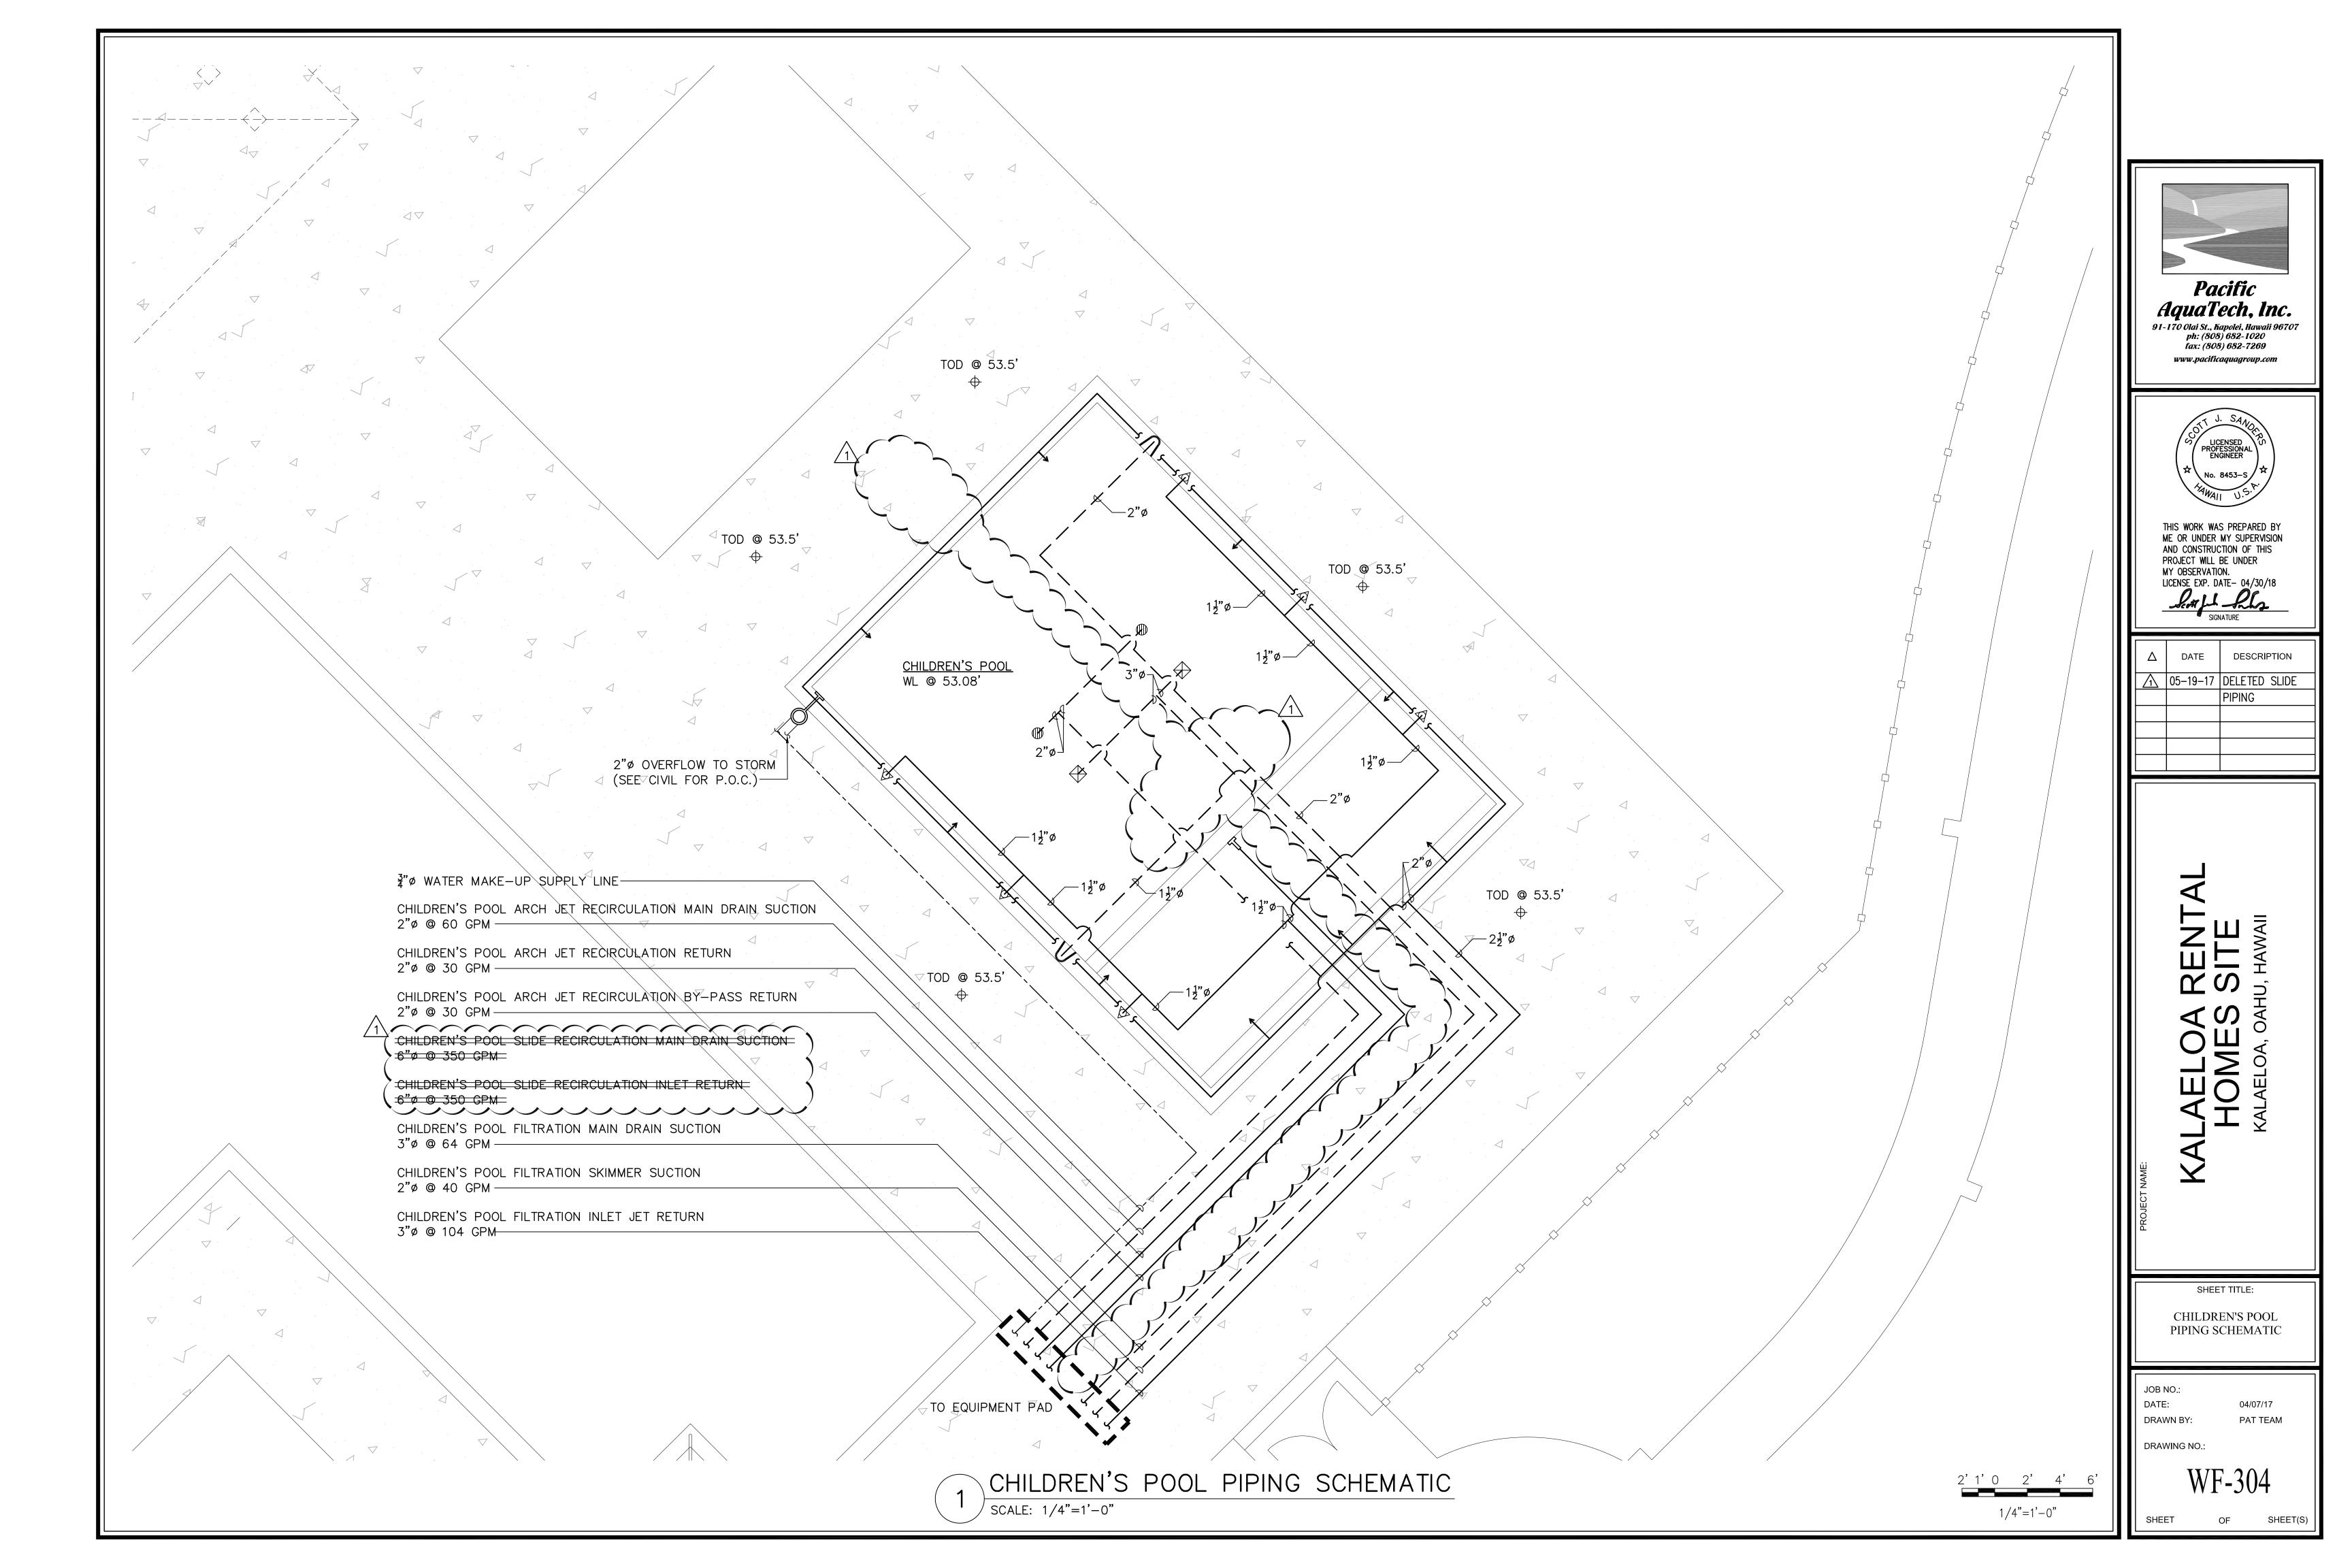
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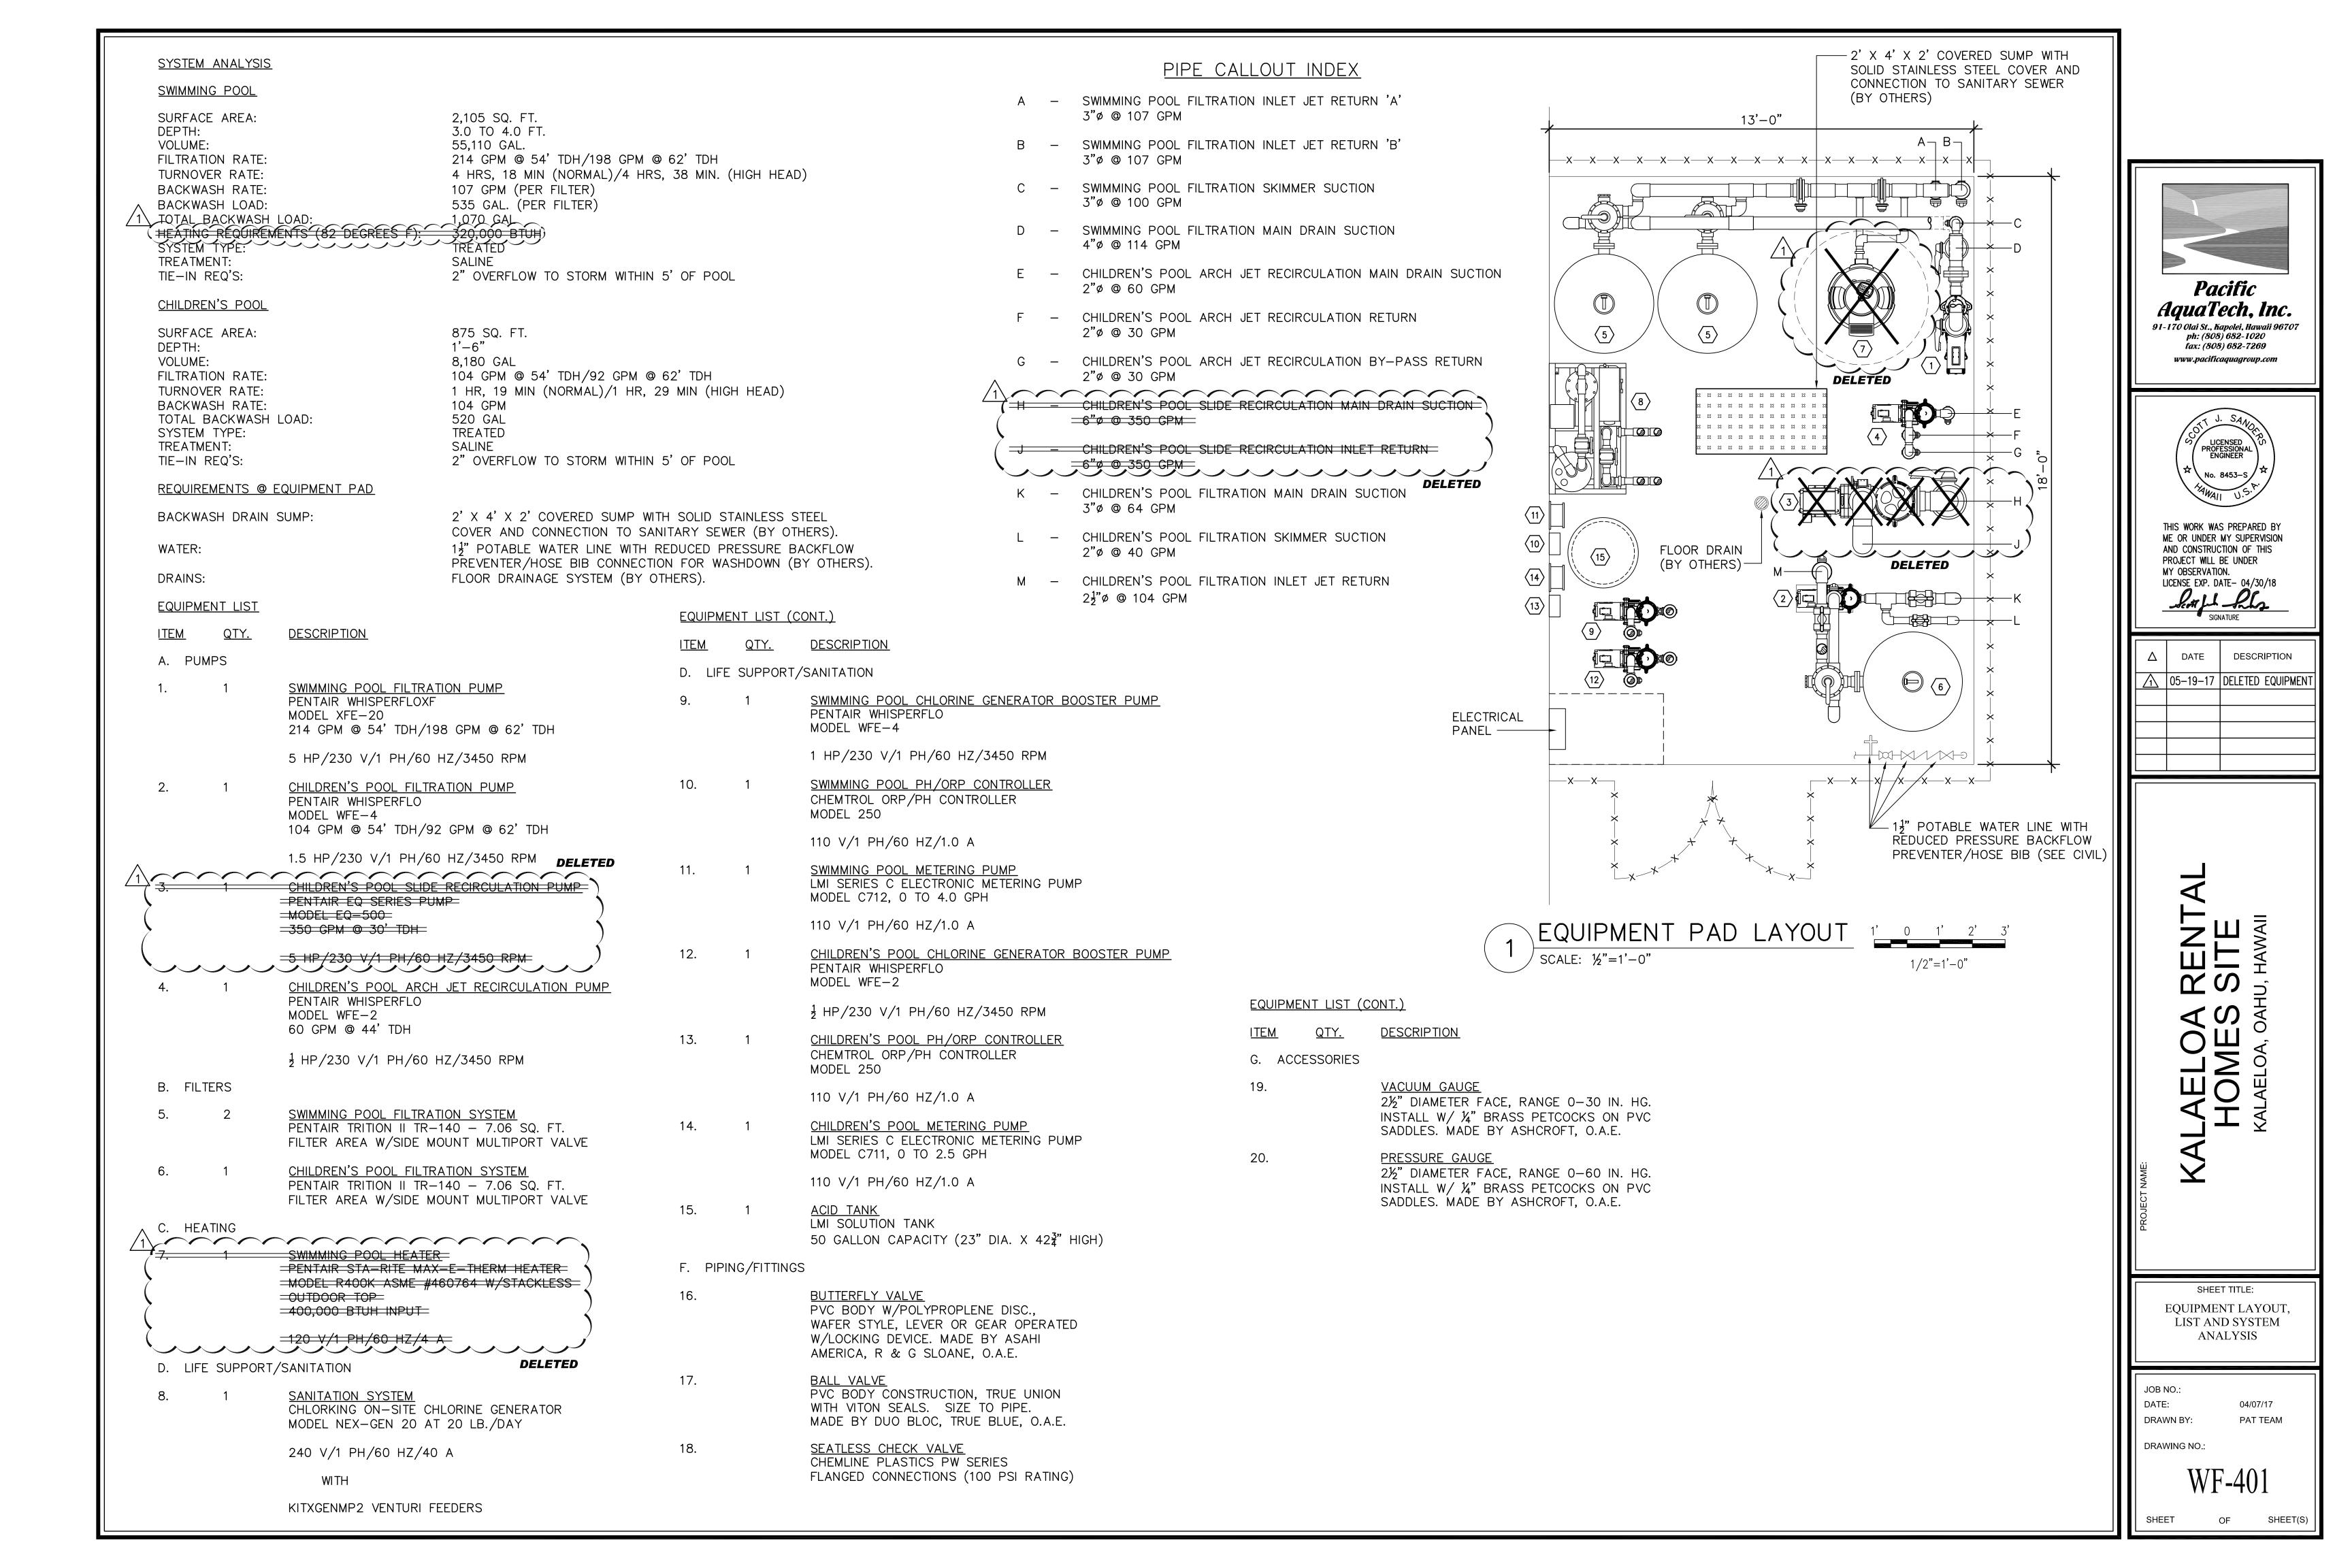
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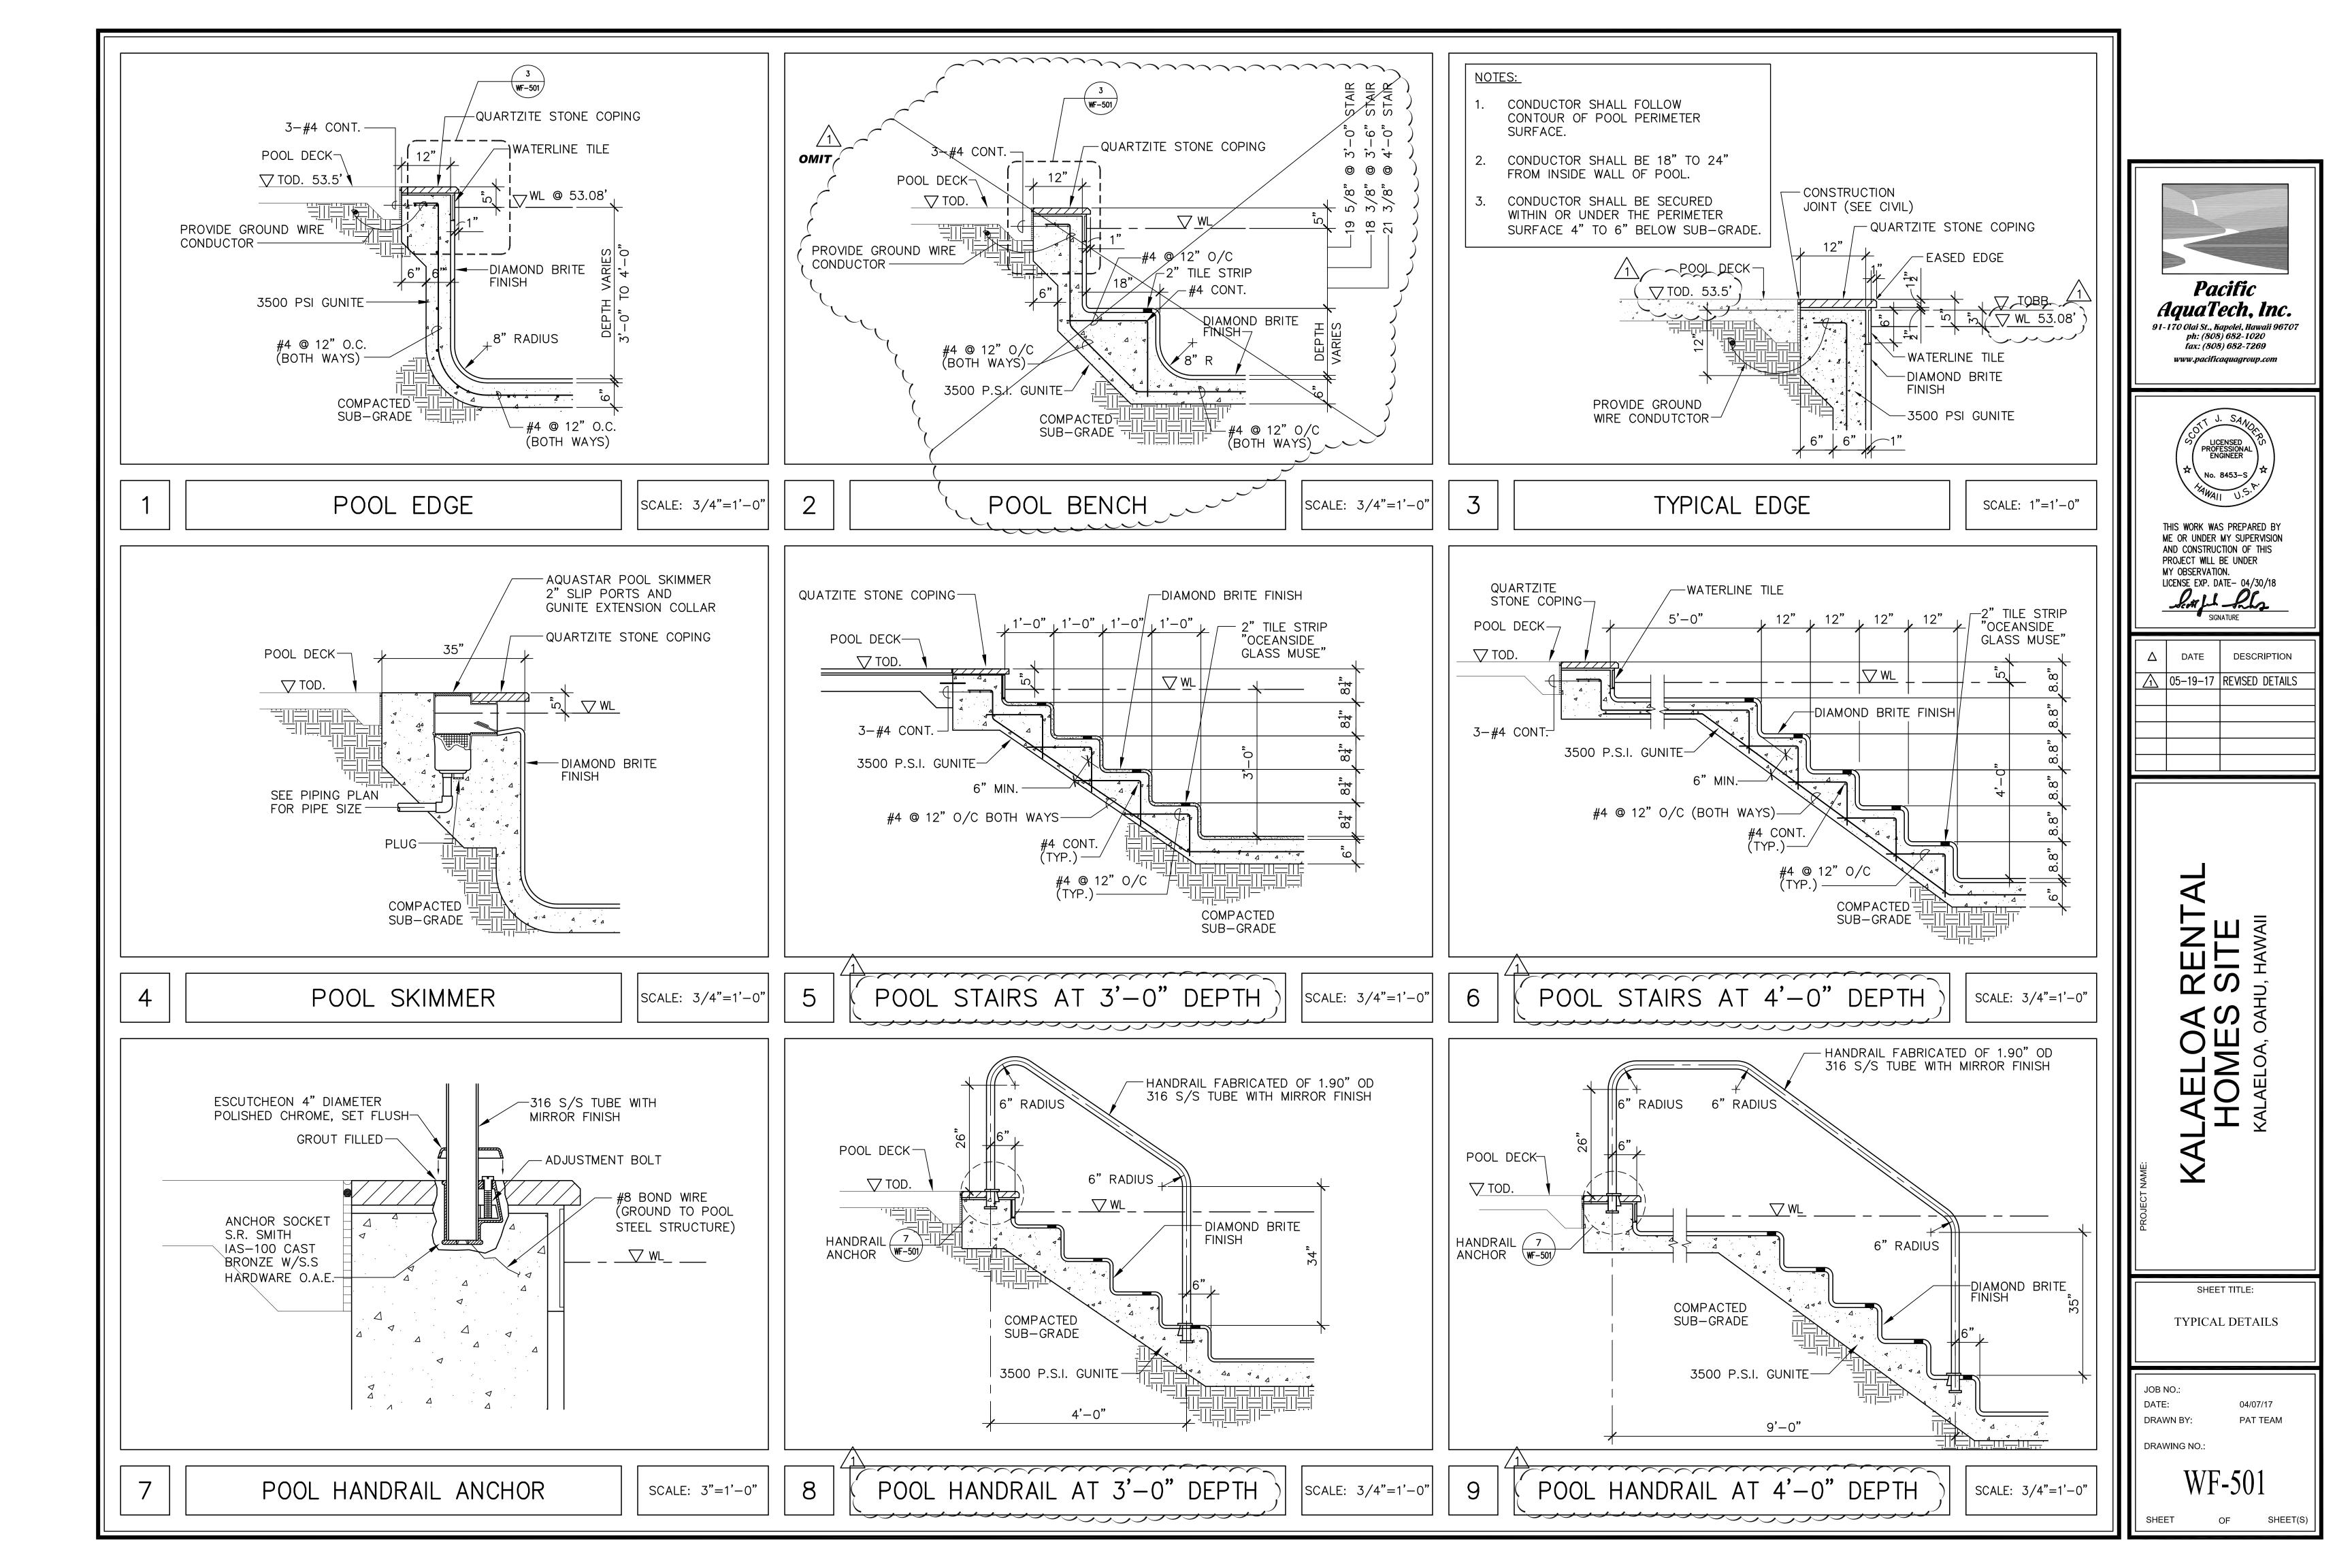


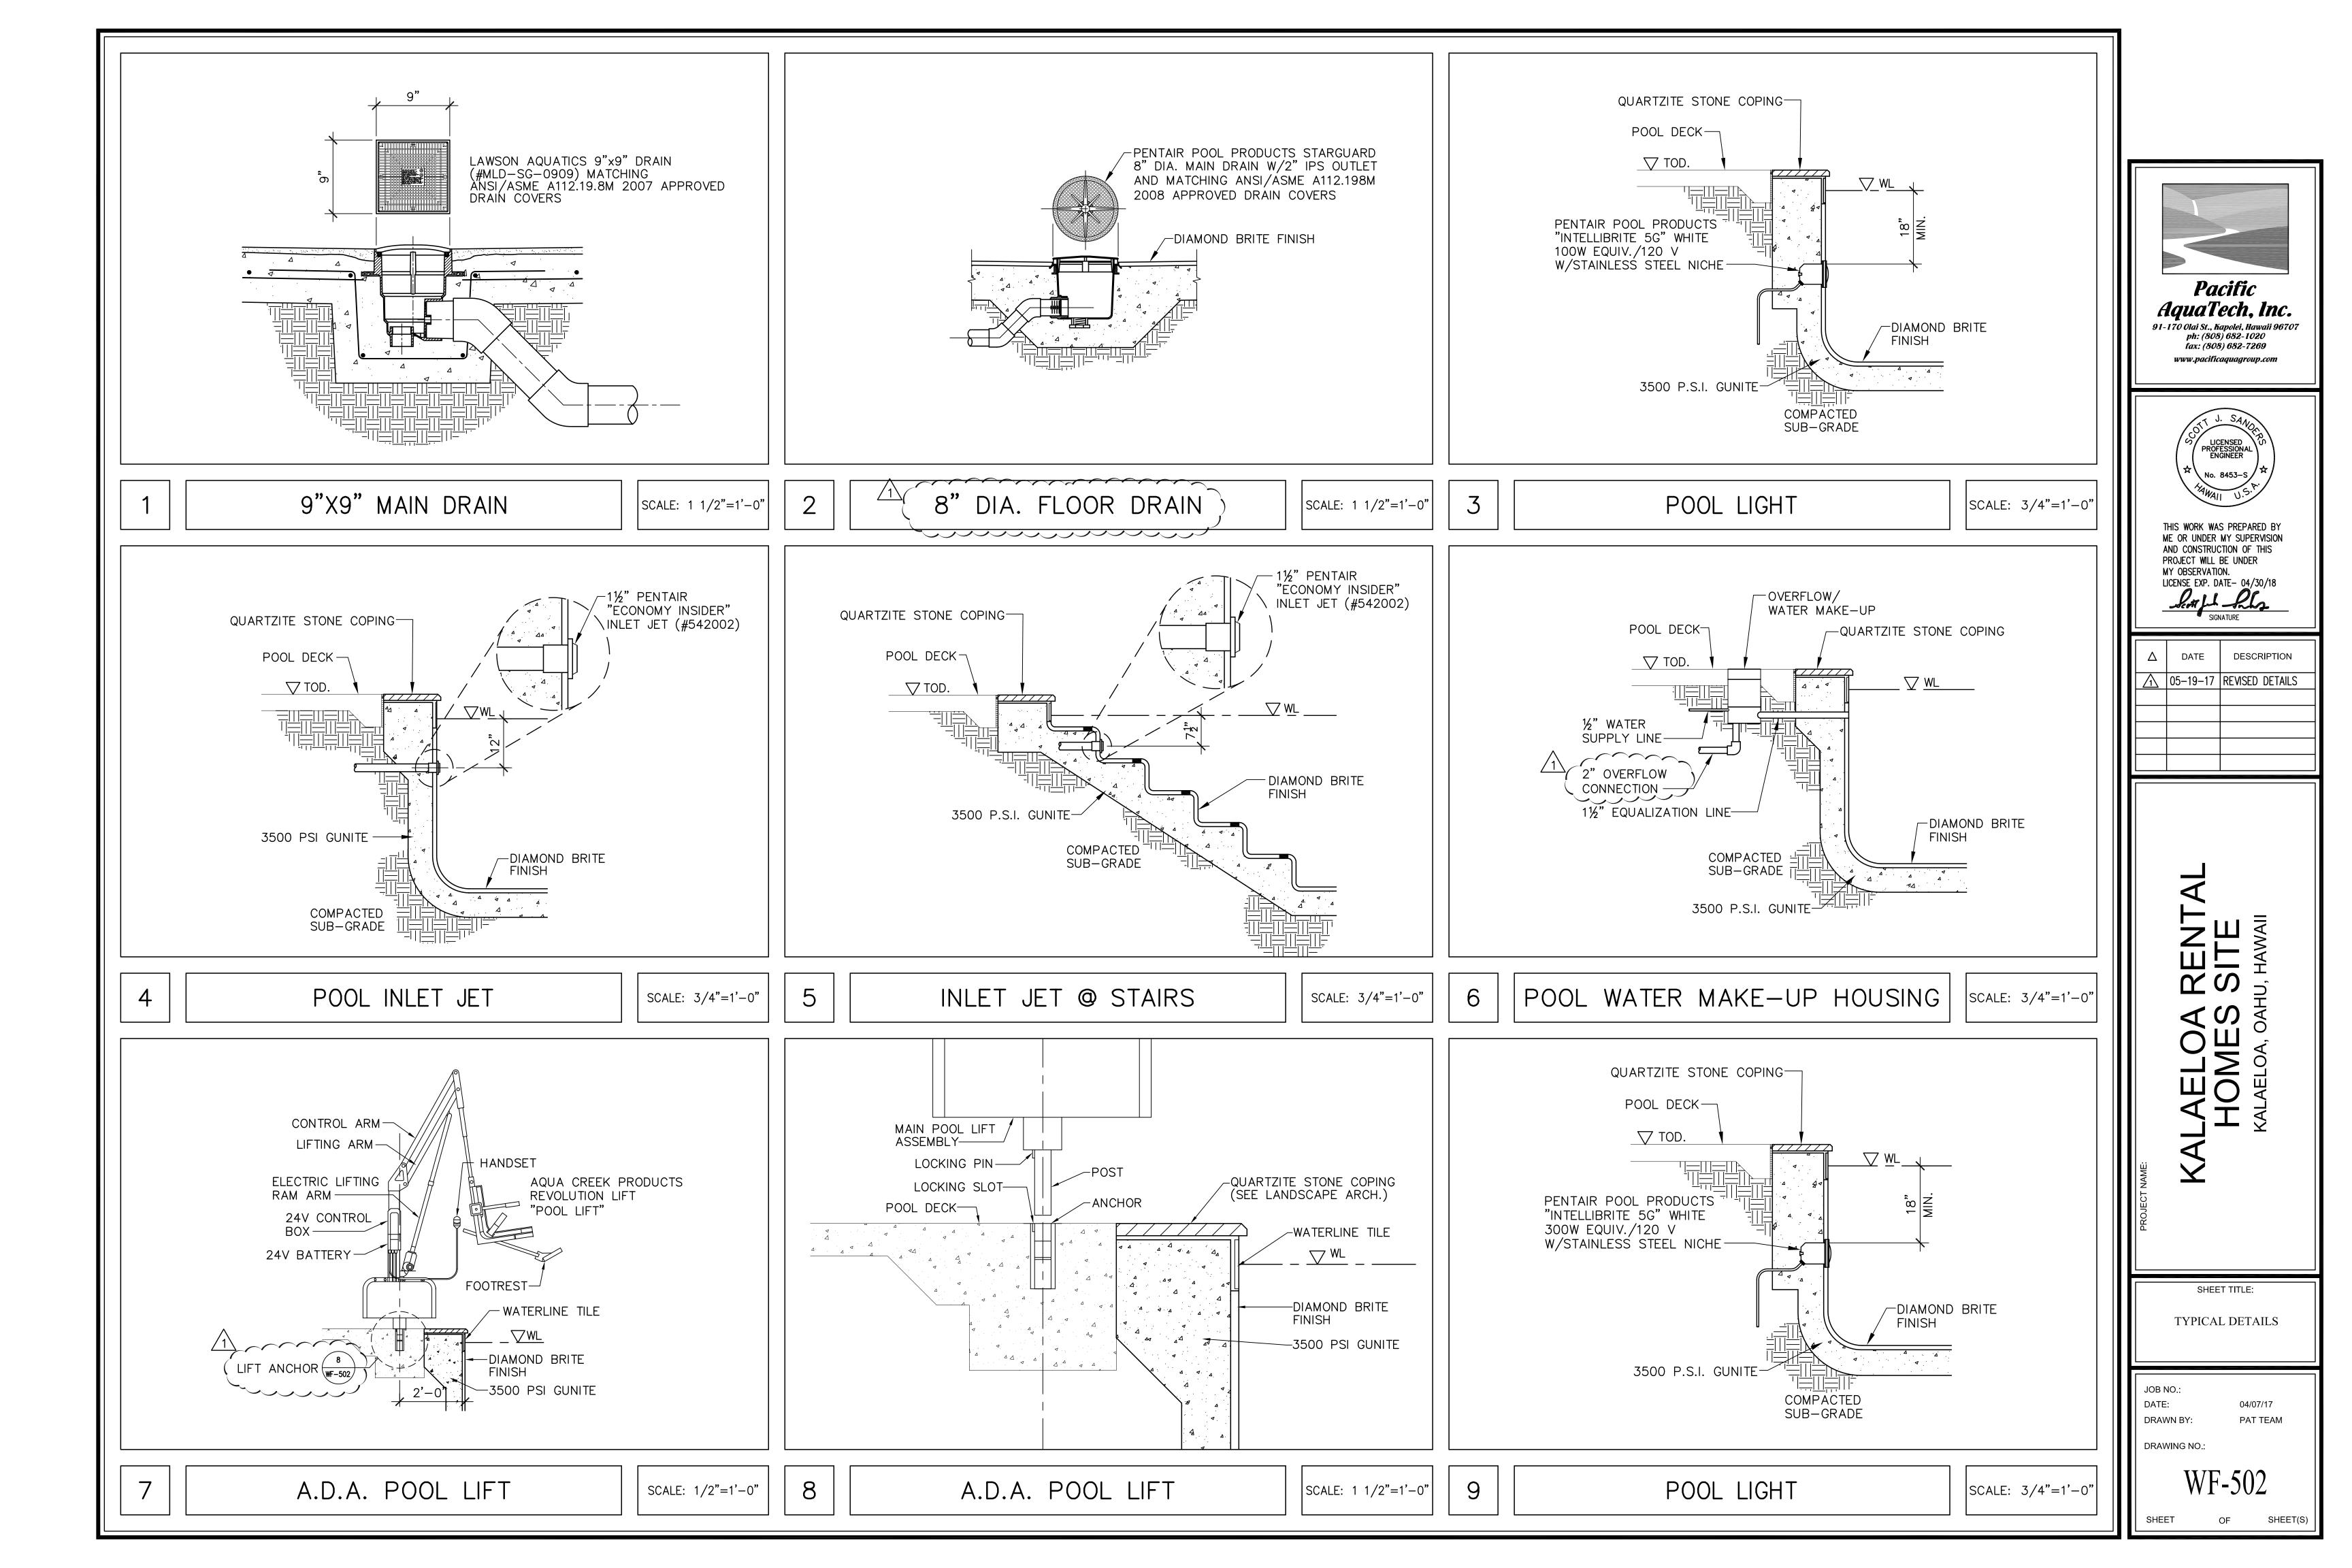


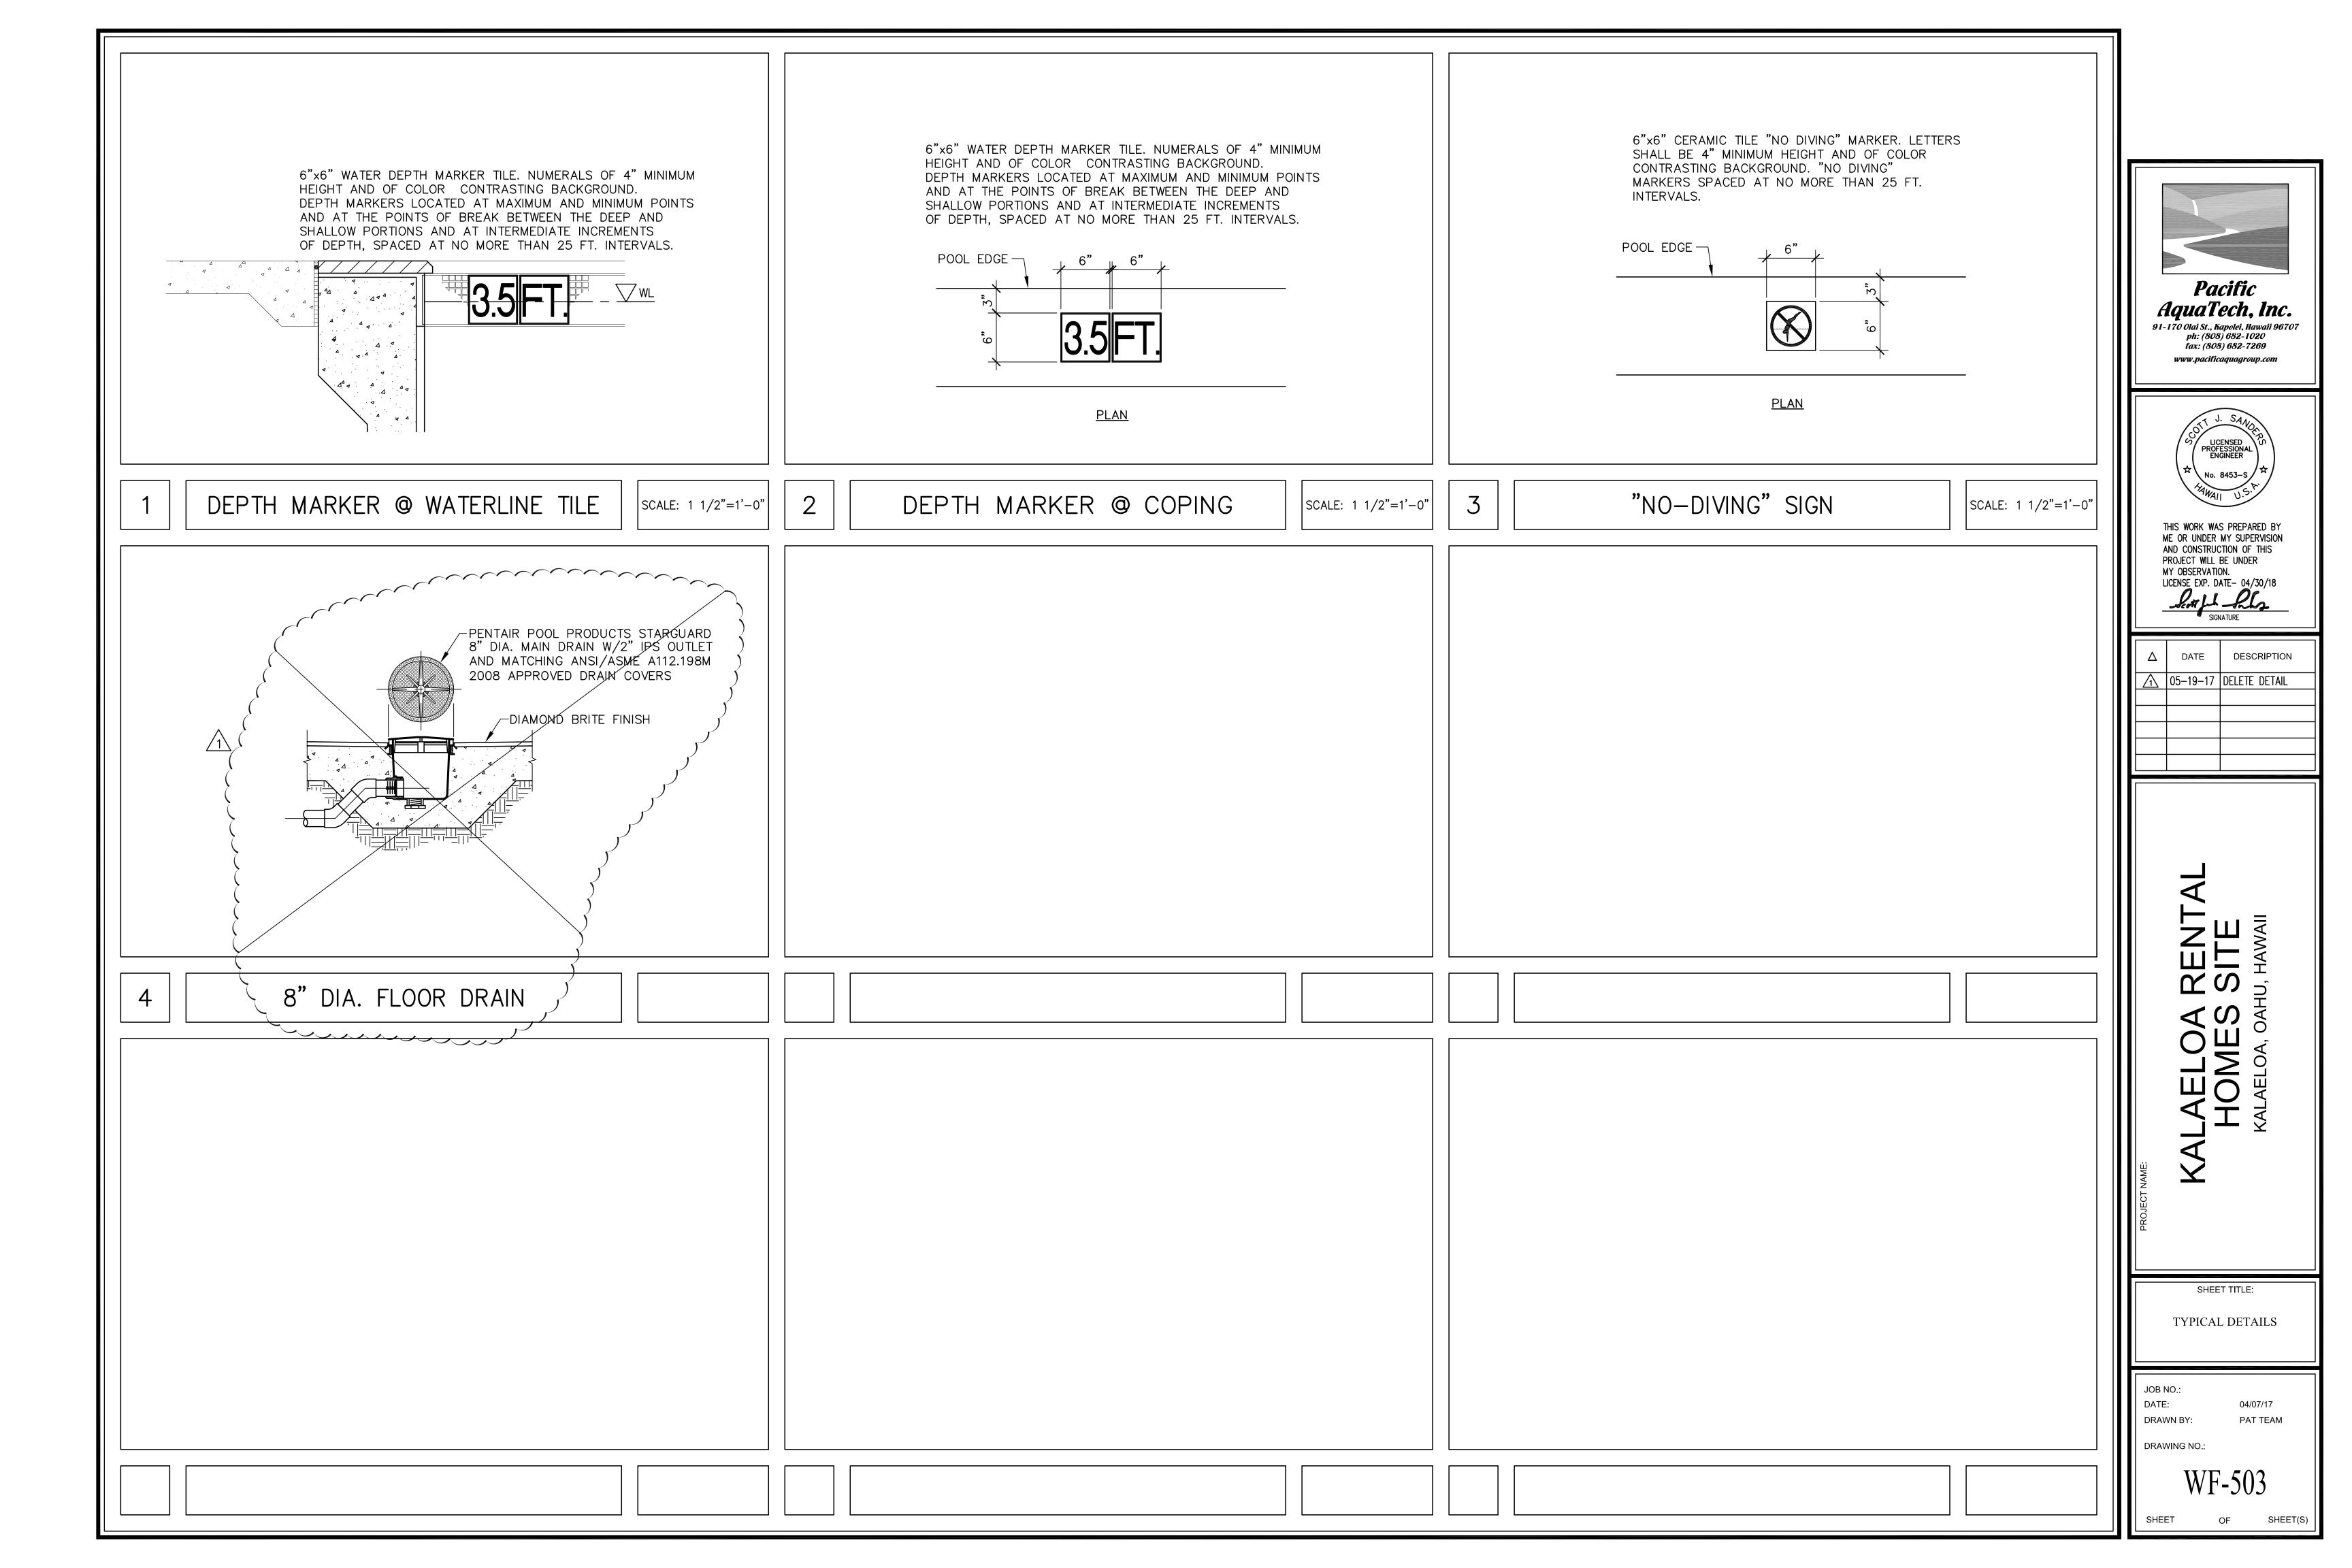
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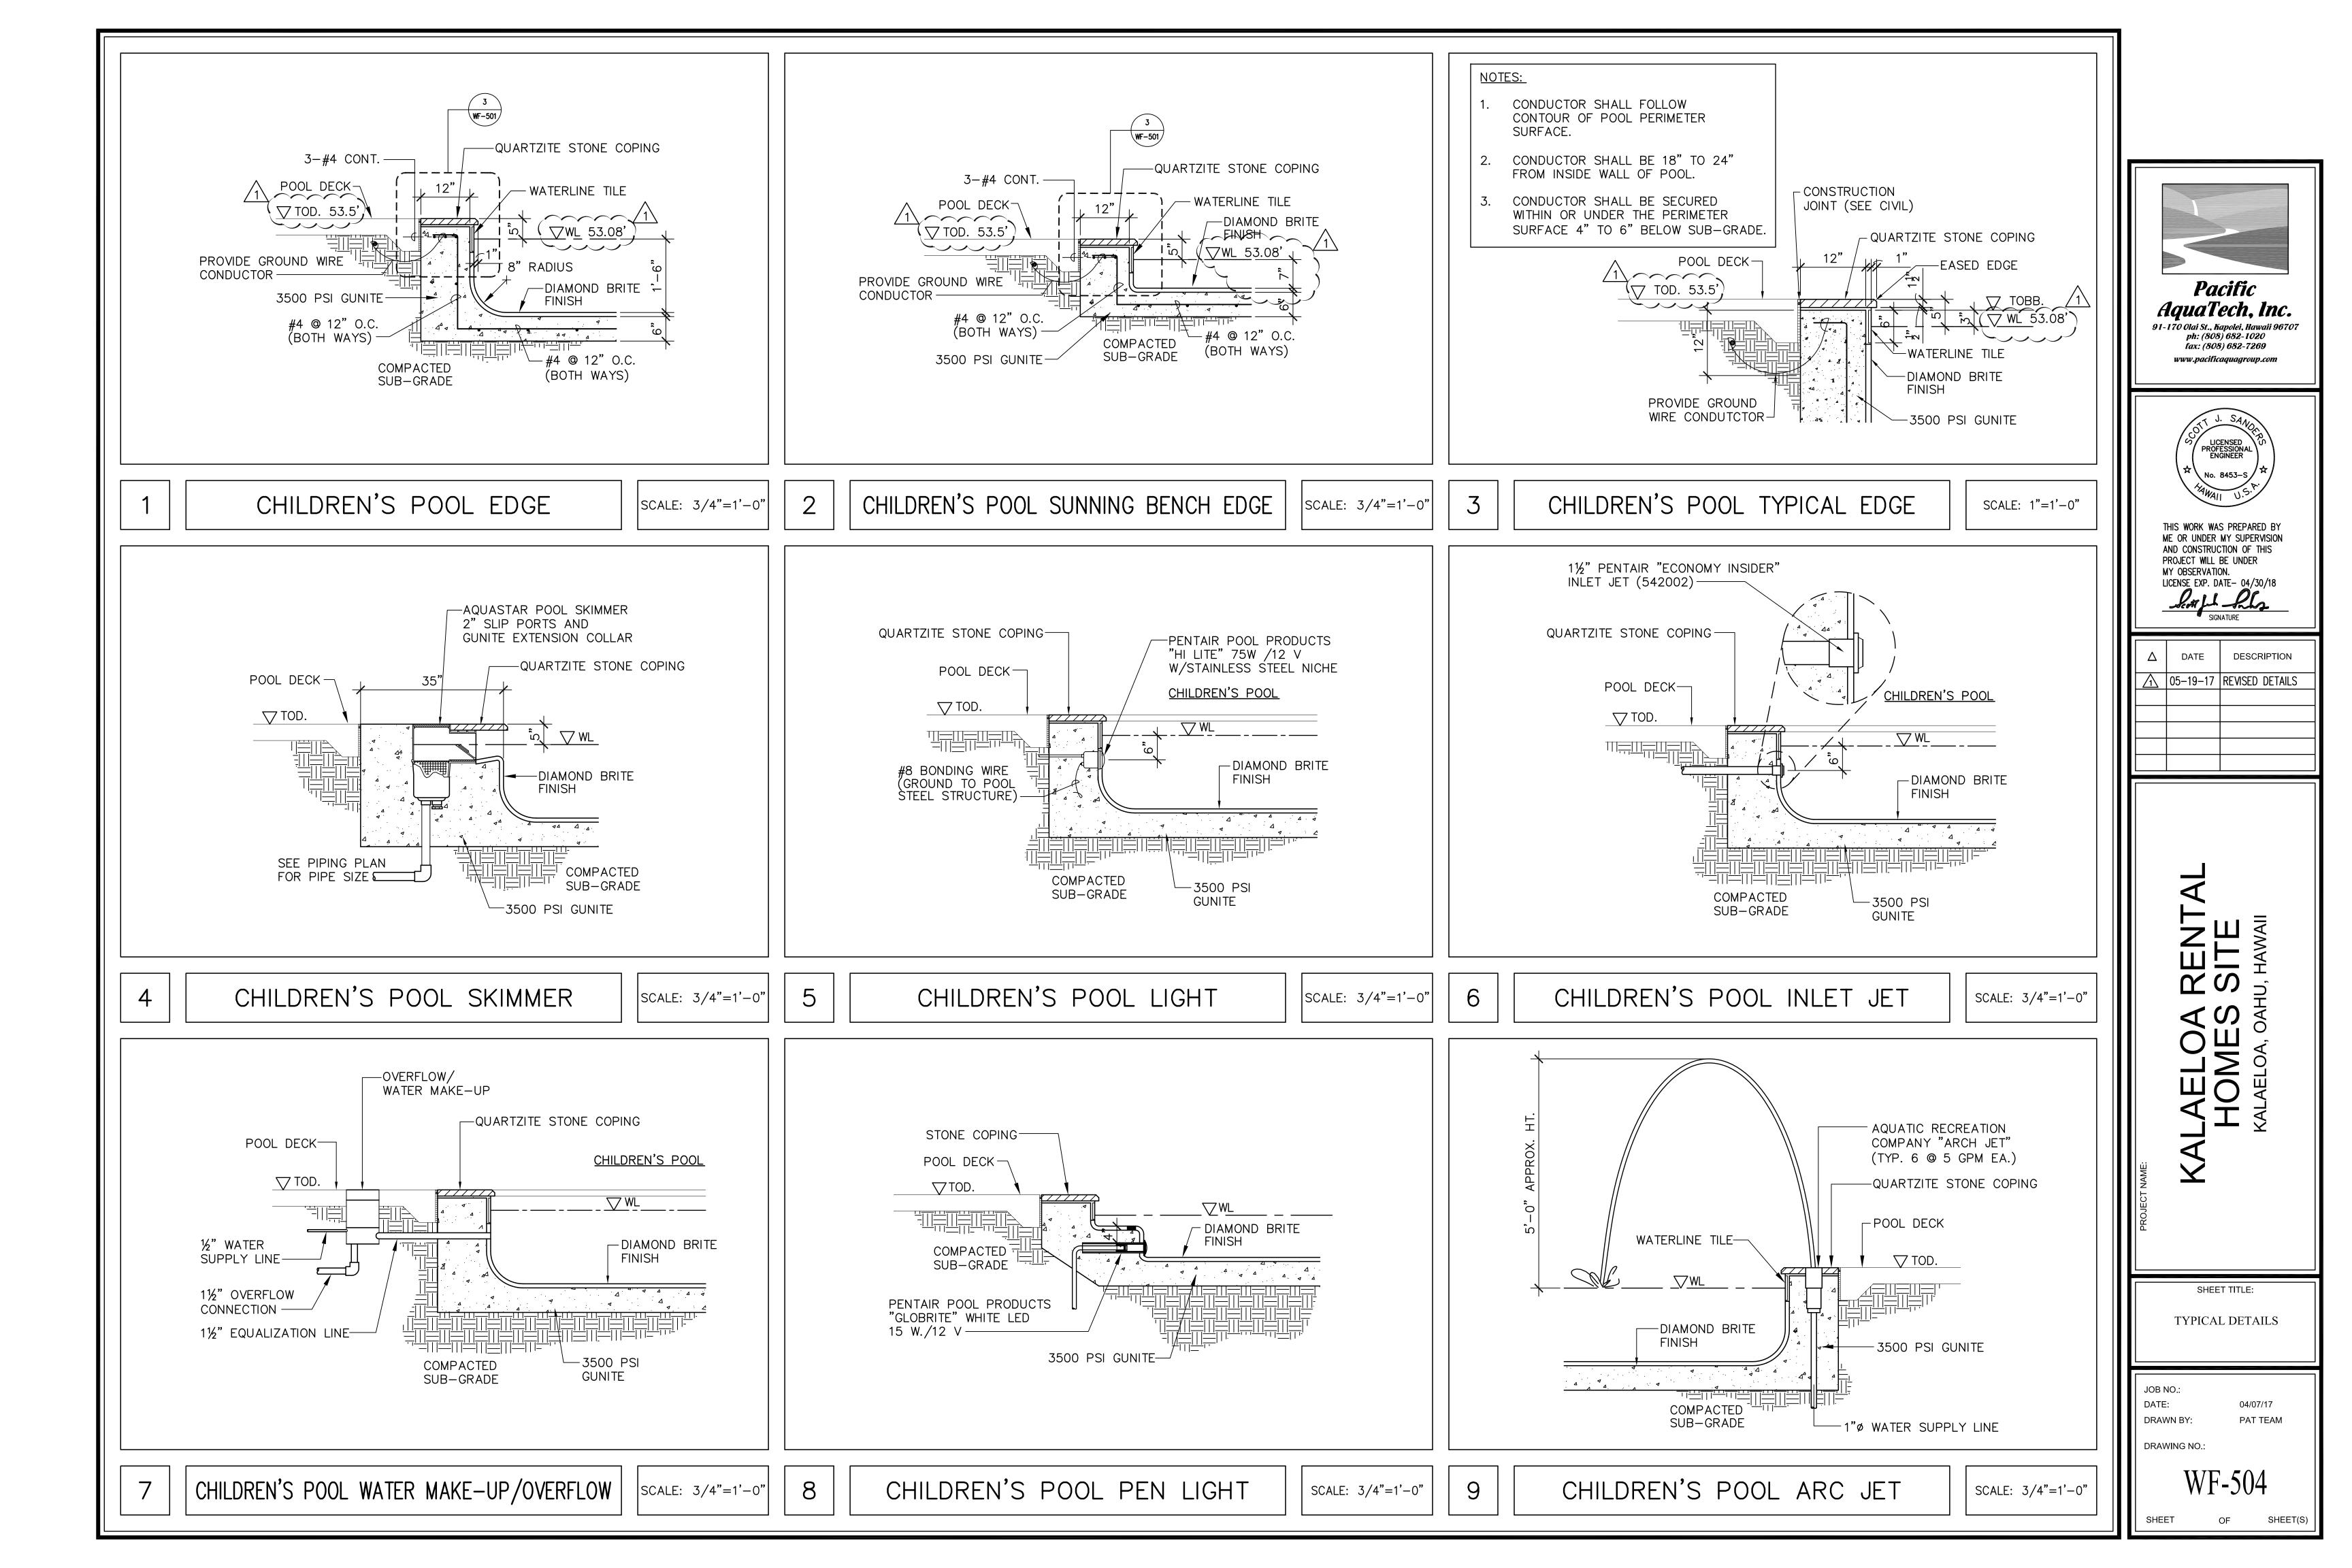


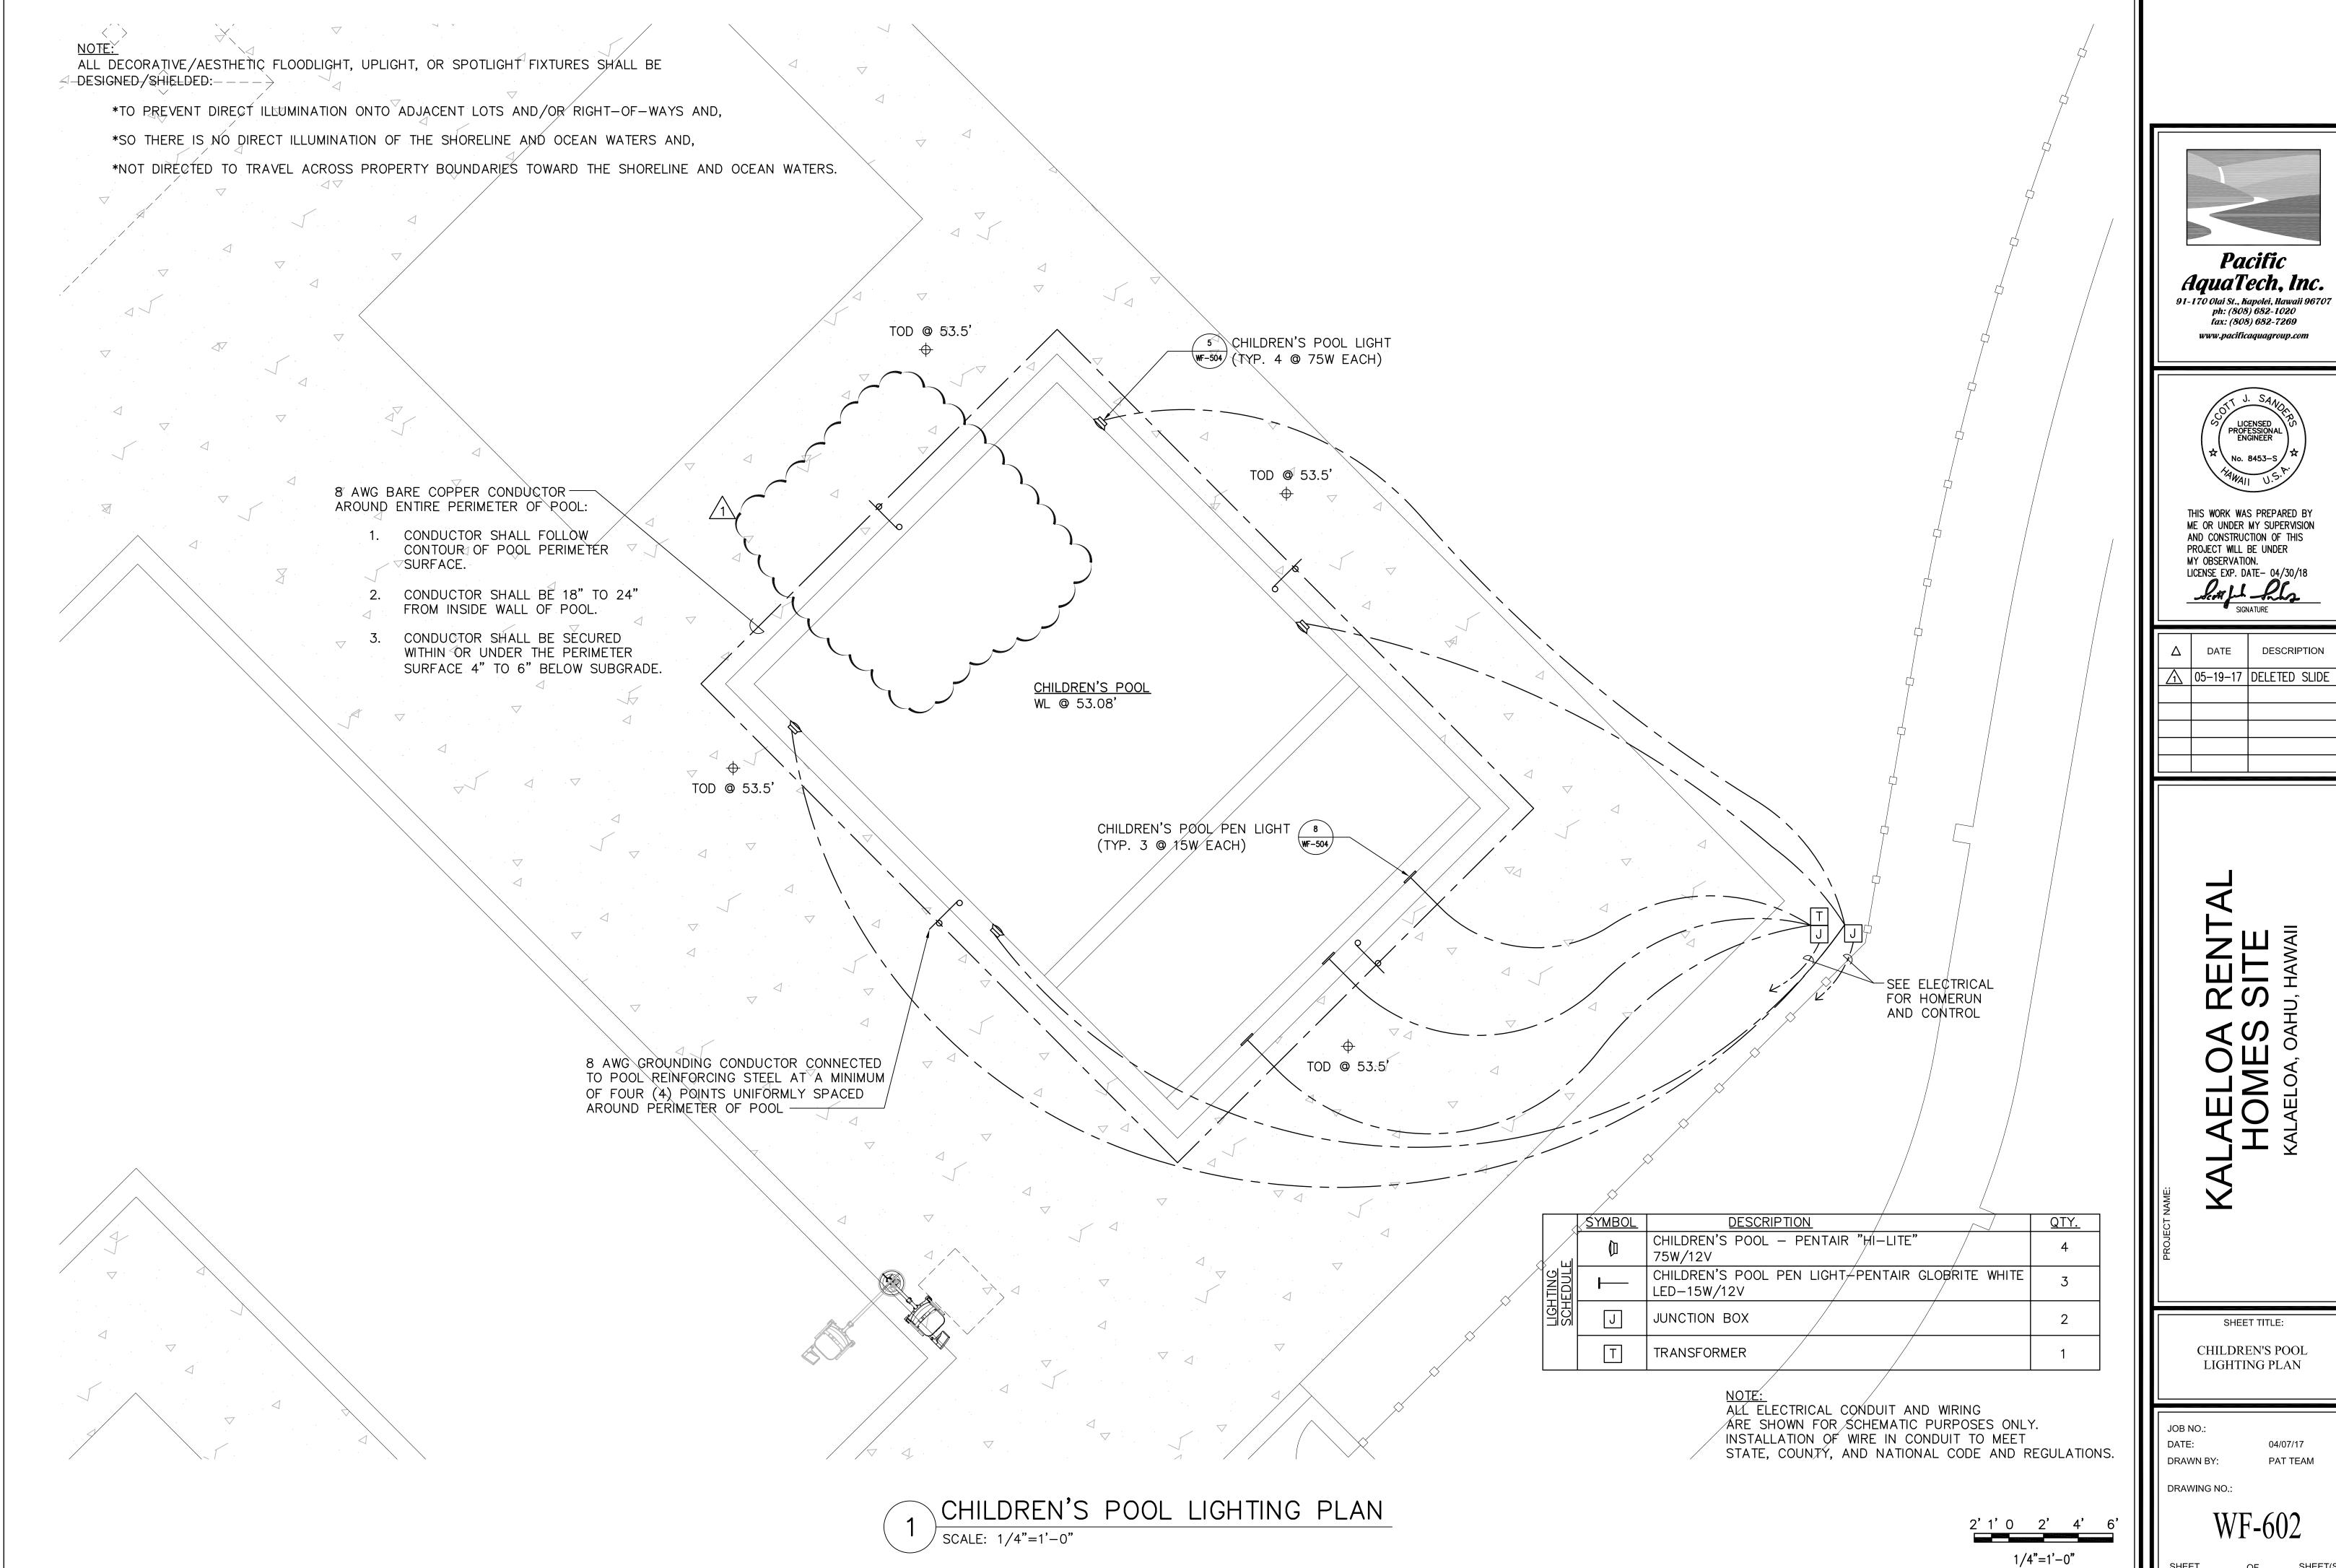













Pacific AquaTech, Inc.

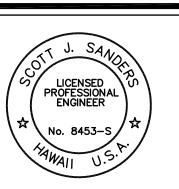



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Δ	DATE	DESCRIPTION
Λ	05-19-17	DELETED SLIDE

SHEET TITLE:

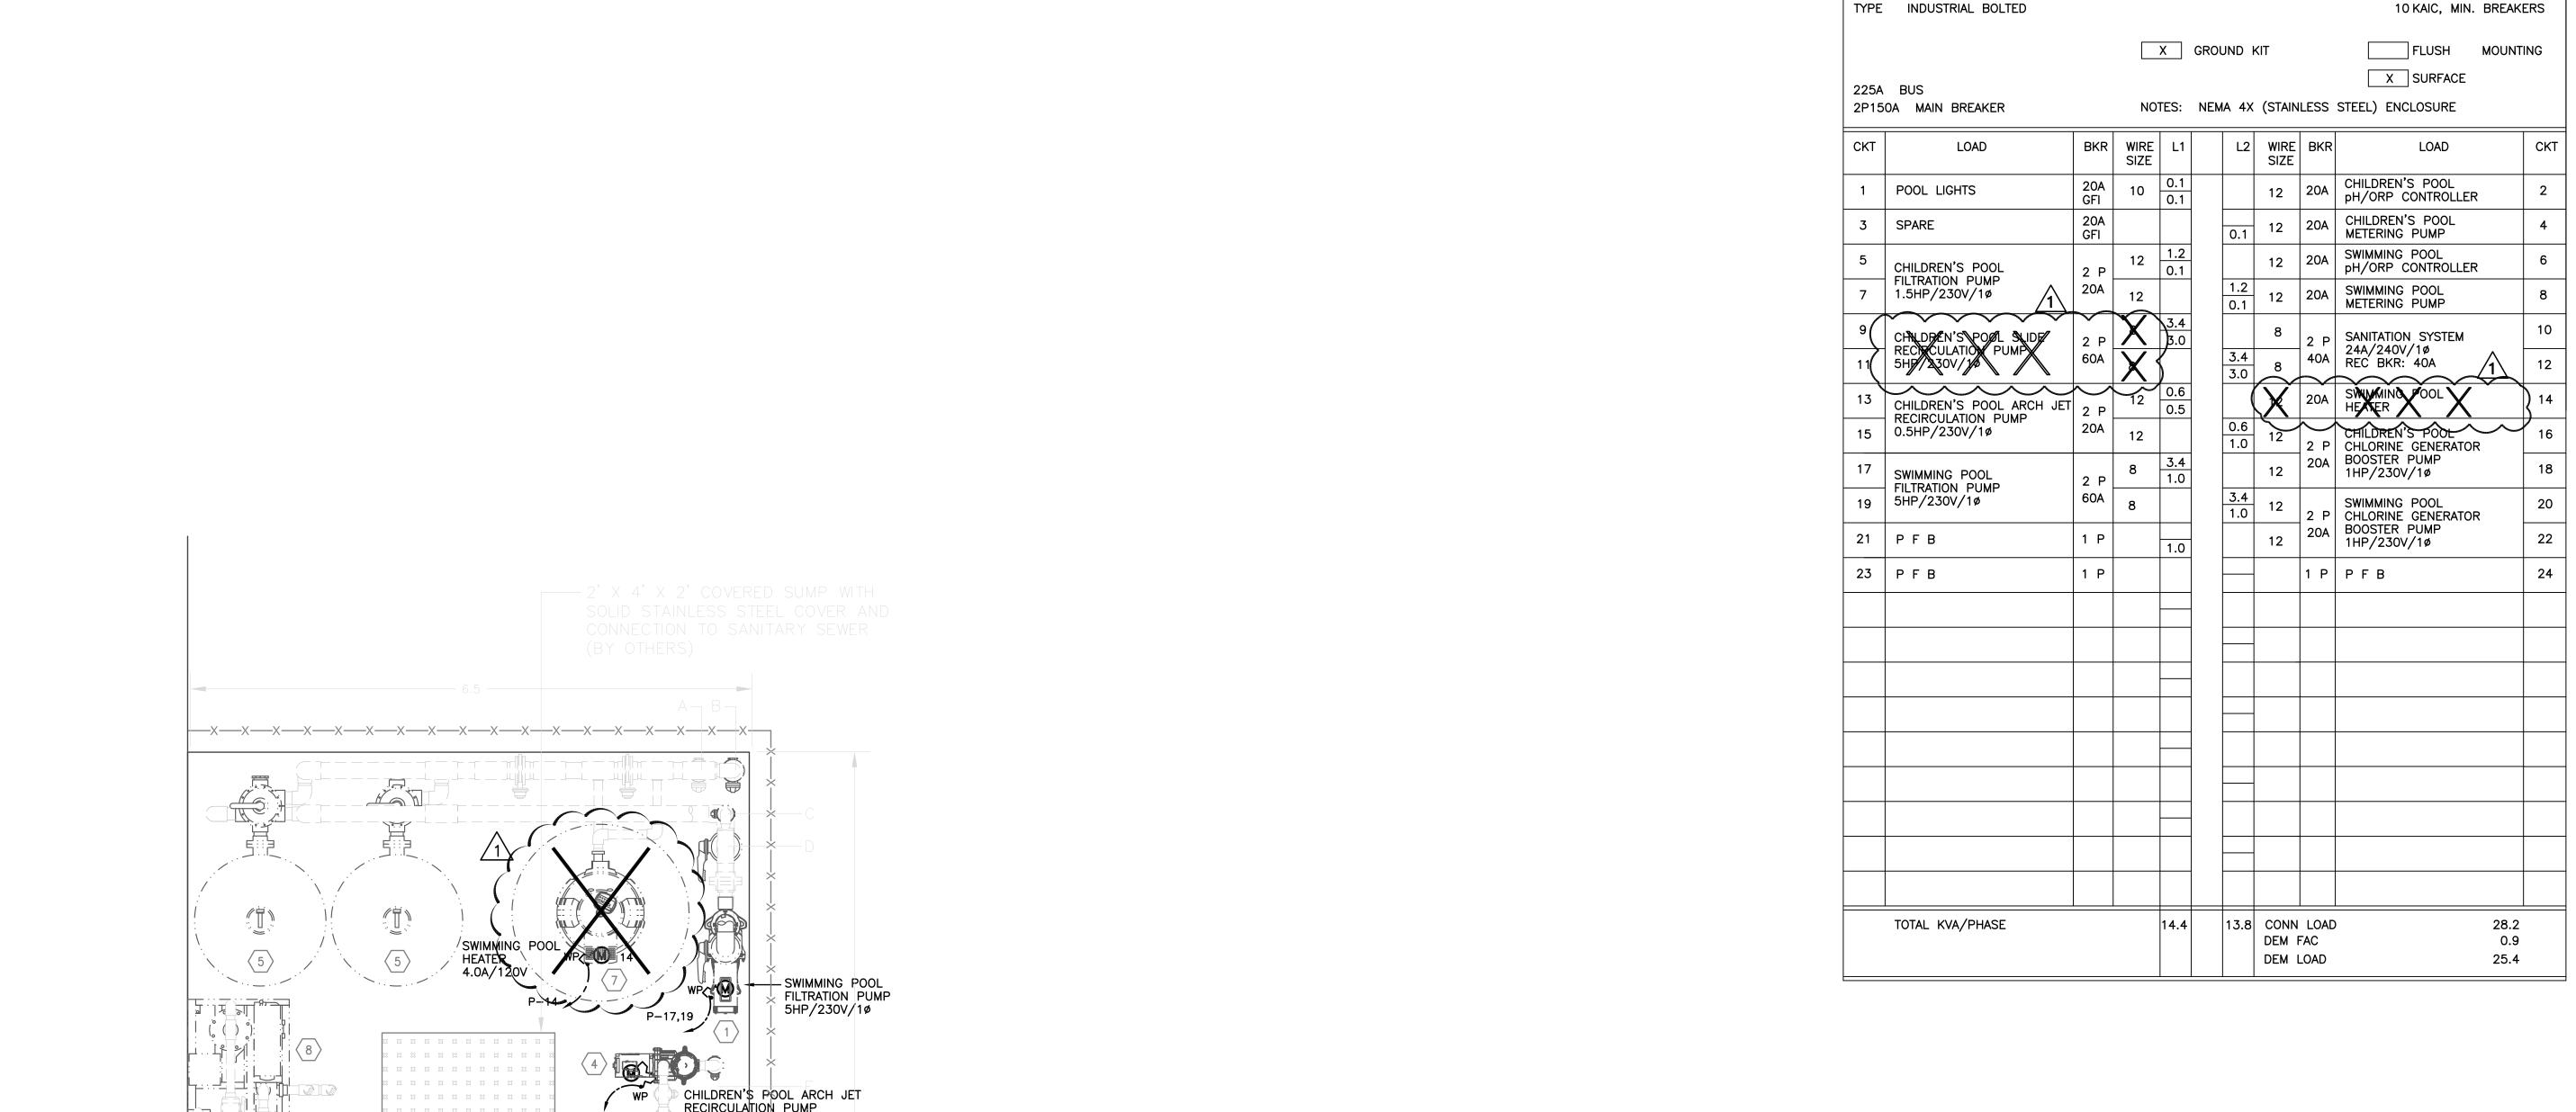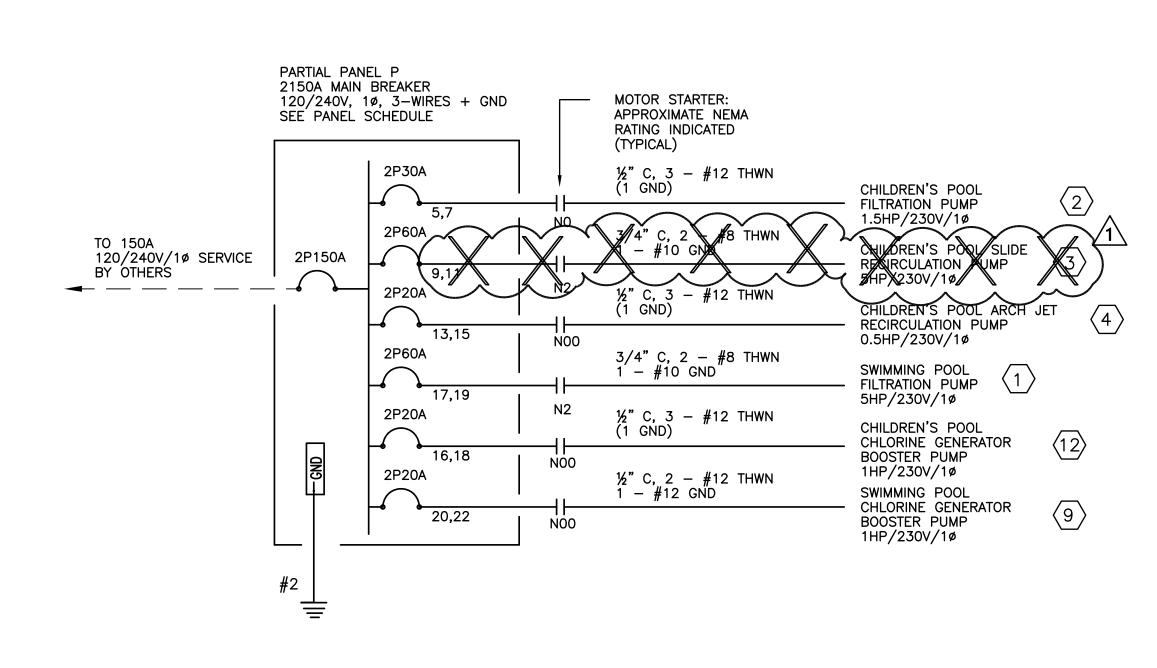PAT TEAM





SINGLE LINE DIAGRAM SCALE: NONE

NOTE: NO INTERIOR LIGHTING WORK

CITY AND COUNTY OF HONOLULU REVISED ORDINANCE CHAPTER 32 HONOLULU COUNTY CODE, 1990, AS AMENDED

To the best of my knowledge, this project's design substantially conforms to the Building Energy code for: Building Component Systems

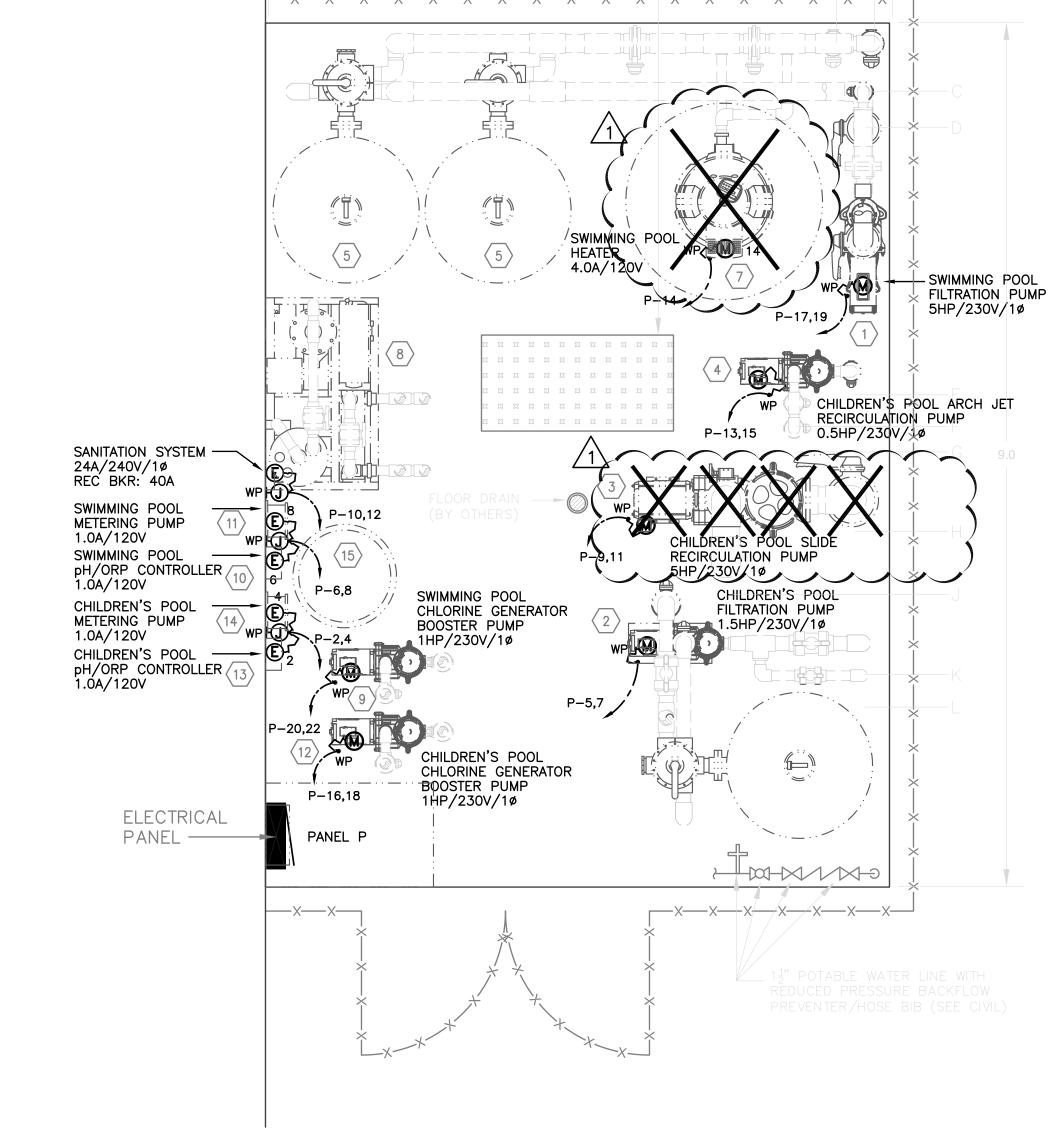
X Electrical Component Systems Mechanical Component Systems

Daniel Vin Signature:

Date: <u>03/31/2017</u>

Darrel Itano Name: President, Itano & Associates, Inc. 4367-E License No.:


OF



EQUIPMENT PAD ELECTRICAL PLAN

1/2"=1'-0"

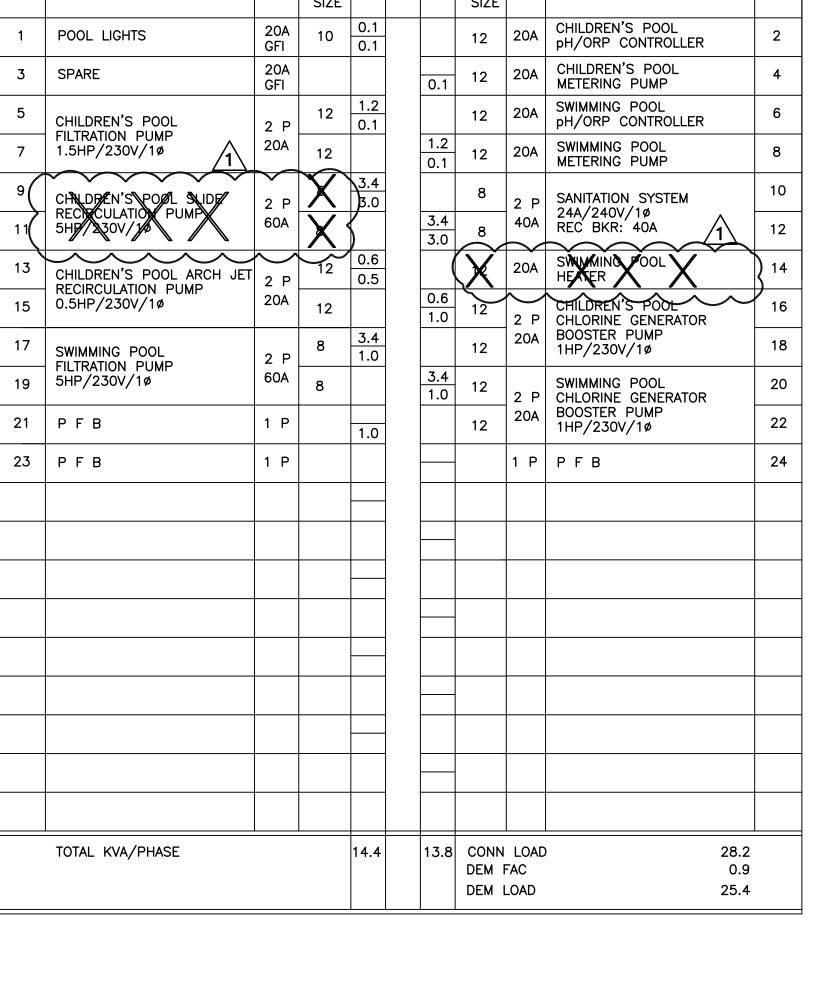SCALE: ½"=1'-0"



120 / 240 VOLTS 1 PHASE 3 WIRE

PANEL P

Pacific

AquaTech, Inc.

91-170 Olai St., Kapolei, Hawaii 96707

ph: (808) 682-1020 fax: (808) 682-7269

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PROFESSIONAL

ENGINEER

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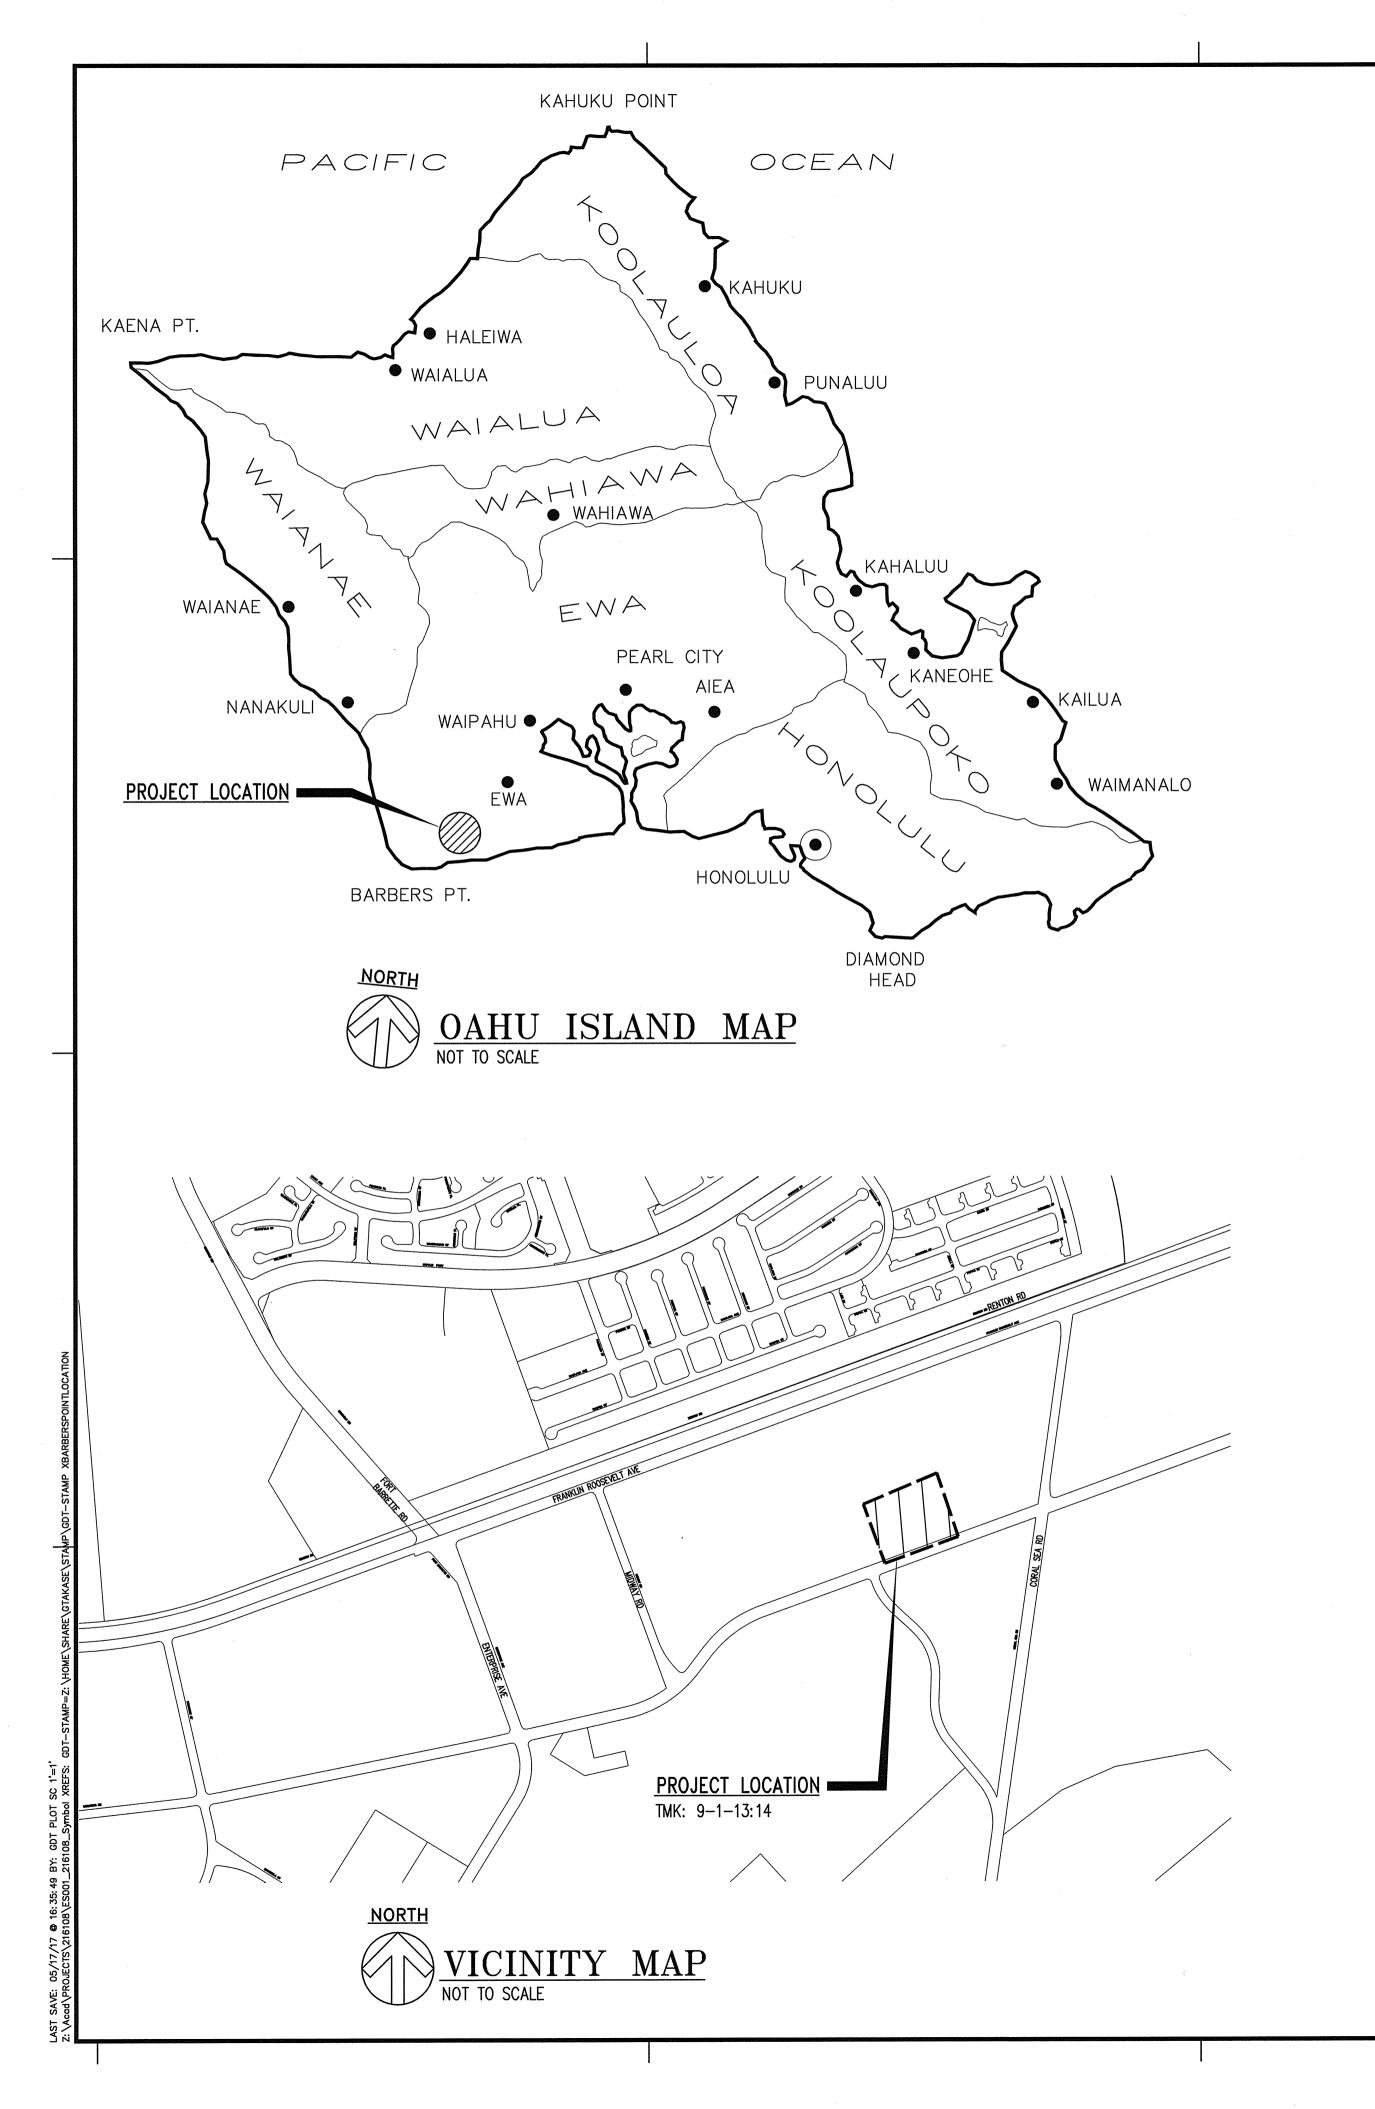
MY OBSERVATION.

EQUIPMENT PAD ELECTRICAL PLAN, SINGLE LINE DIAGRAM, PANEL SCHEDULE, **ENERGY BUDGET**


JOB NO.:

DRAWING NO.:

DATE: 04/07/17 PAT TEAM DRAWN BY:



		ELECTRICAL SYMBOLS	
	ITEM	DESCRIPTION	
	[2]	EXST. HECO HANDHOLE	
	[] []	EXST. HECO TRANSFORMER	
		METER PEDESTAL, SEE SHEET ES003	
•	——s—	SECURITY/KEY ENTRY DUCTLINE	
	L	LIGHT DUCTLINE	
		ELECTRIC/SIGNAL DUCTLINE WITH DESIGNATORS; INDICATES TYPE "A"	
	A (3E)	DUCT SECTION WITH "3E" DUCTS. SEE SHEET ES003 FOR DUCT SECTIONS	
	A 35	AND CONDUIT SCHEDULES	
<u>/1\</u>	LV LOW VOLTAGE, DIRECT BURIED RATED CABLE, 2#12, 6" MIN DEPTH.		
>		<u> </u>	
	<u> </u>	DIRECT BURIAL - 12V TRANSFORMER, FOCUS INDUSTRIES: DB-12-75E	
	\oplus	UPLIGHT, 12V, SEE LANDSCAPE PLANS FOR LOCATION AND TYPE	
	+	LANDSCAPE LIGHT, 12V, SEE LANDSCAPE PLANS FOR LOCATION AND TYPE	
		AREA LIGHT, SEE SHEET ES004	
·		WALKWAY LIGHT, BEACHSIDE LIGHTING L-017-B-120V-5W-A-NFL-HS17-2	
		PRIVATE 17"X30" POLYMER HANDHOLE	
	<u> — е— —</u>	EXST. ELECTRICAL DUCTLINE	
	xex	REMOVE CABLES FROM EXST. ELECTRICAL DUCTLINE, ABANDON IN PLACE.	
	X	DEMOLISH OR ABANDON IN PLACE WHEN NOTED.	

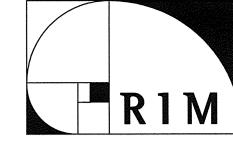

ARCHITECTS | GUAM CALIFORNIA ALASKA 851 FORT STREET, SUITE 200 HONOLULU, HAWAII 96813 Phone: 808.550.0844 Fax: 808.585.9445



Ronald N.S. Ho & Associates, Inc. Electrical Engineers 2153 North King Street, Suite 201 Honolulu, Hawaii 96819



PERMIT SET

OFFICE G KALAELOA HOUSING RENOVATION 4285 INDEPENDENCE RD, KAPOLE

MARK DATE DESCRIPTION

PROJECT NO: 163042 DRAWN BY : CAD CHECKED BY:

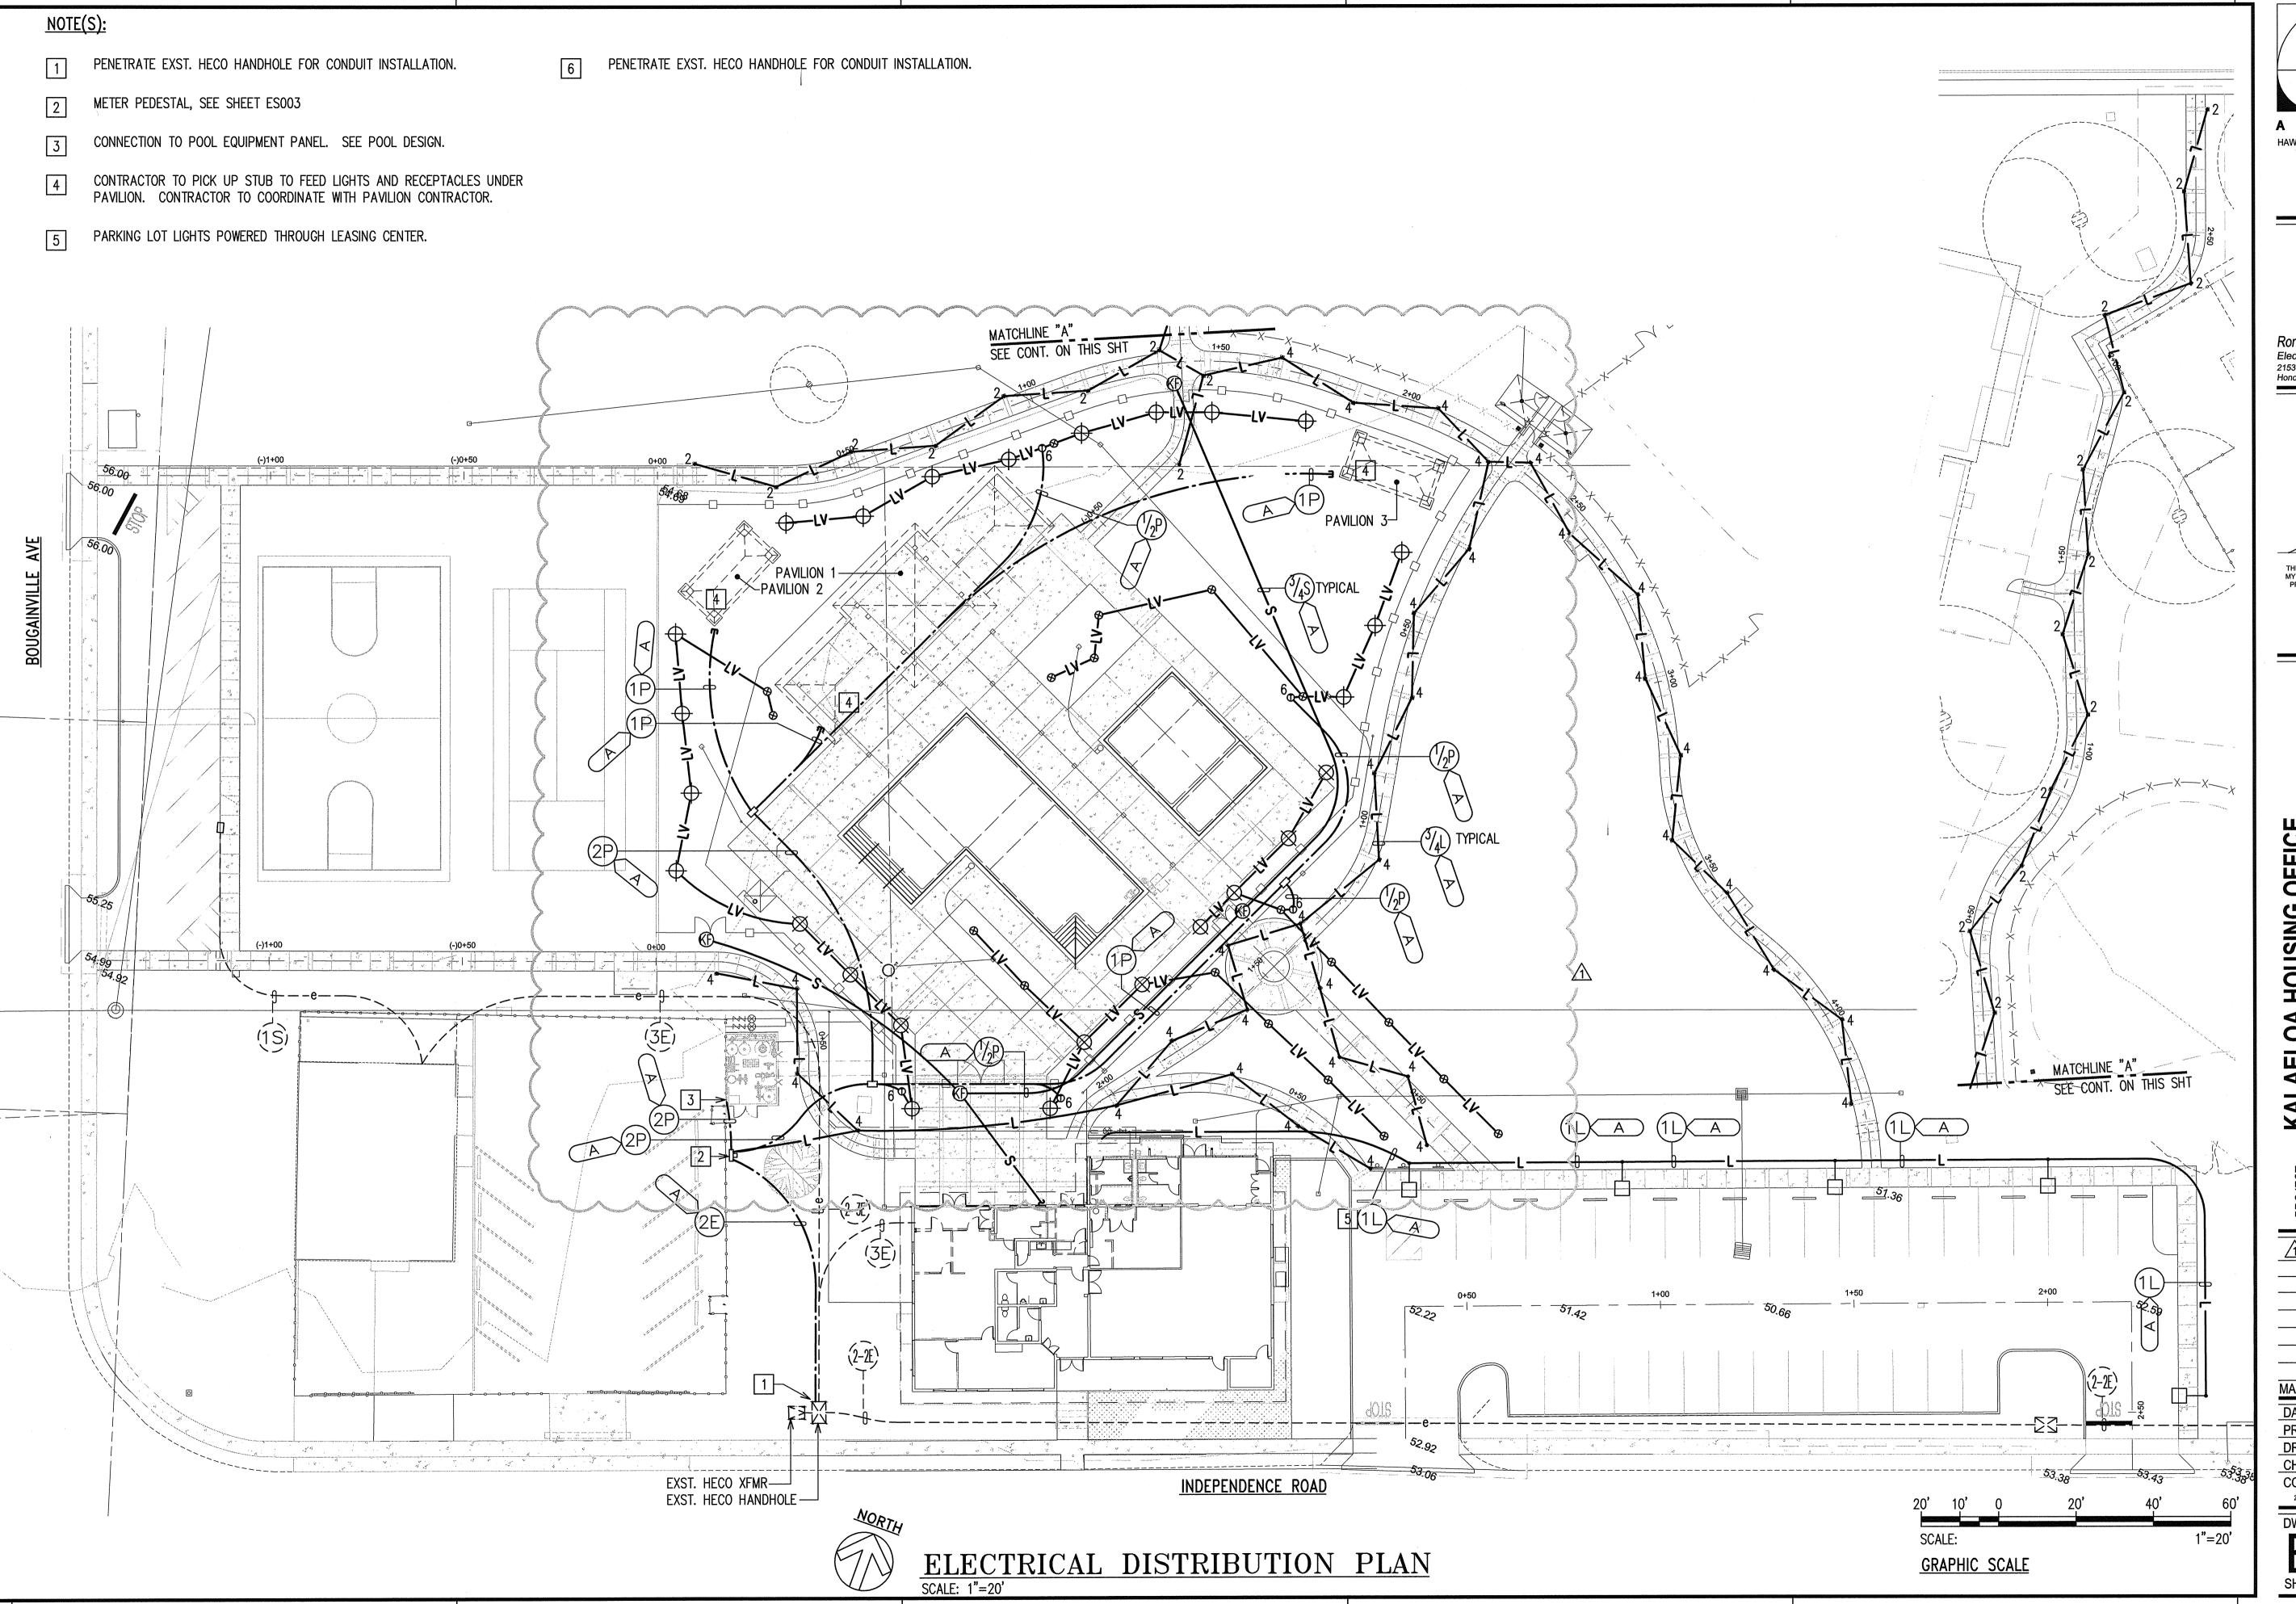
DWG NO:

DRAWING REVIEW

Reviewed for HECO's Facilities Only

Customer Installation Department Hawaiian Electric Company, Inc.

HECO's review of these drawings shall in no way relieve the Customer, its Consultant or anyone acting in the Customer's behalf from the responsibility for engineering design, materials and any other liability associated with this project.







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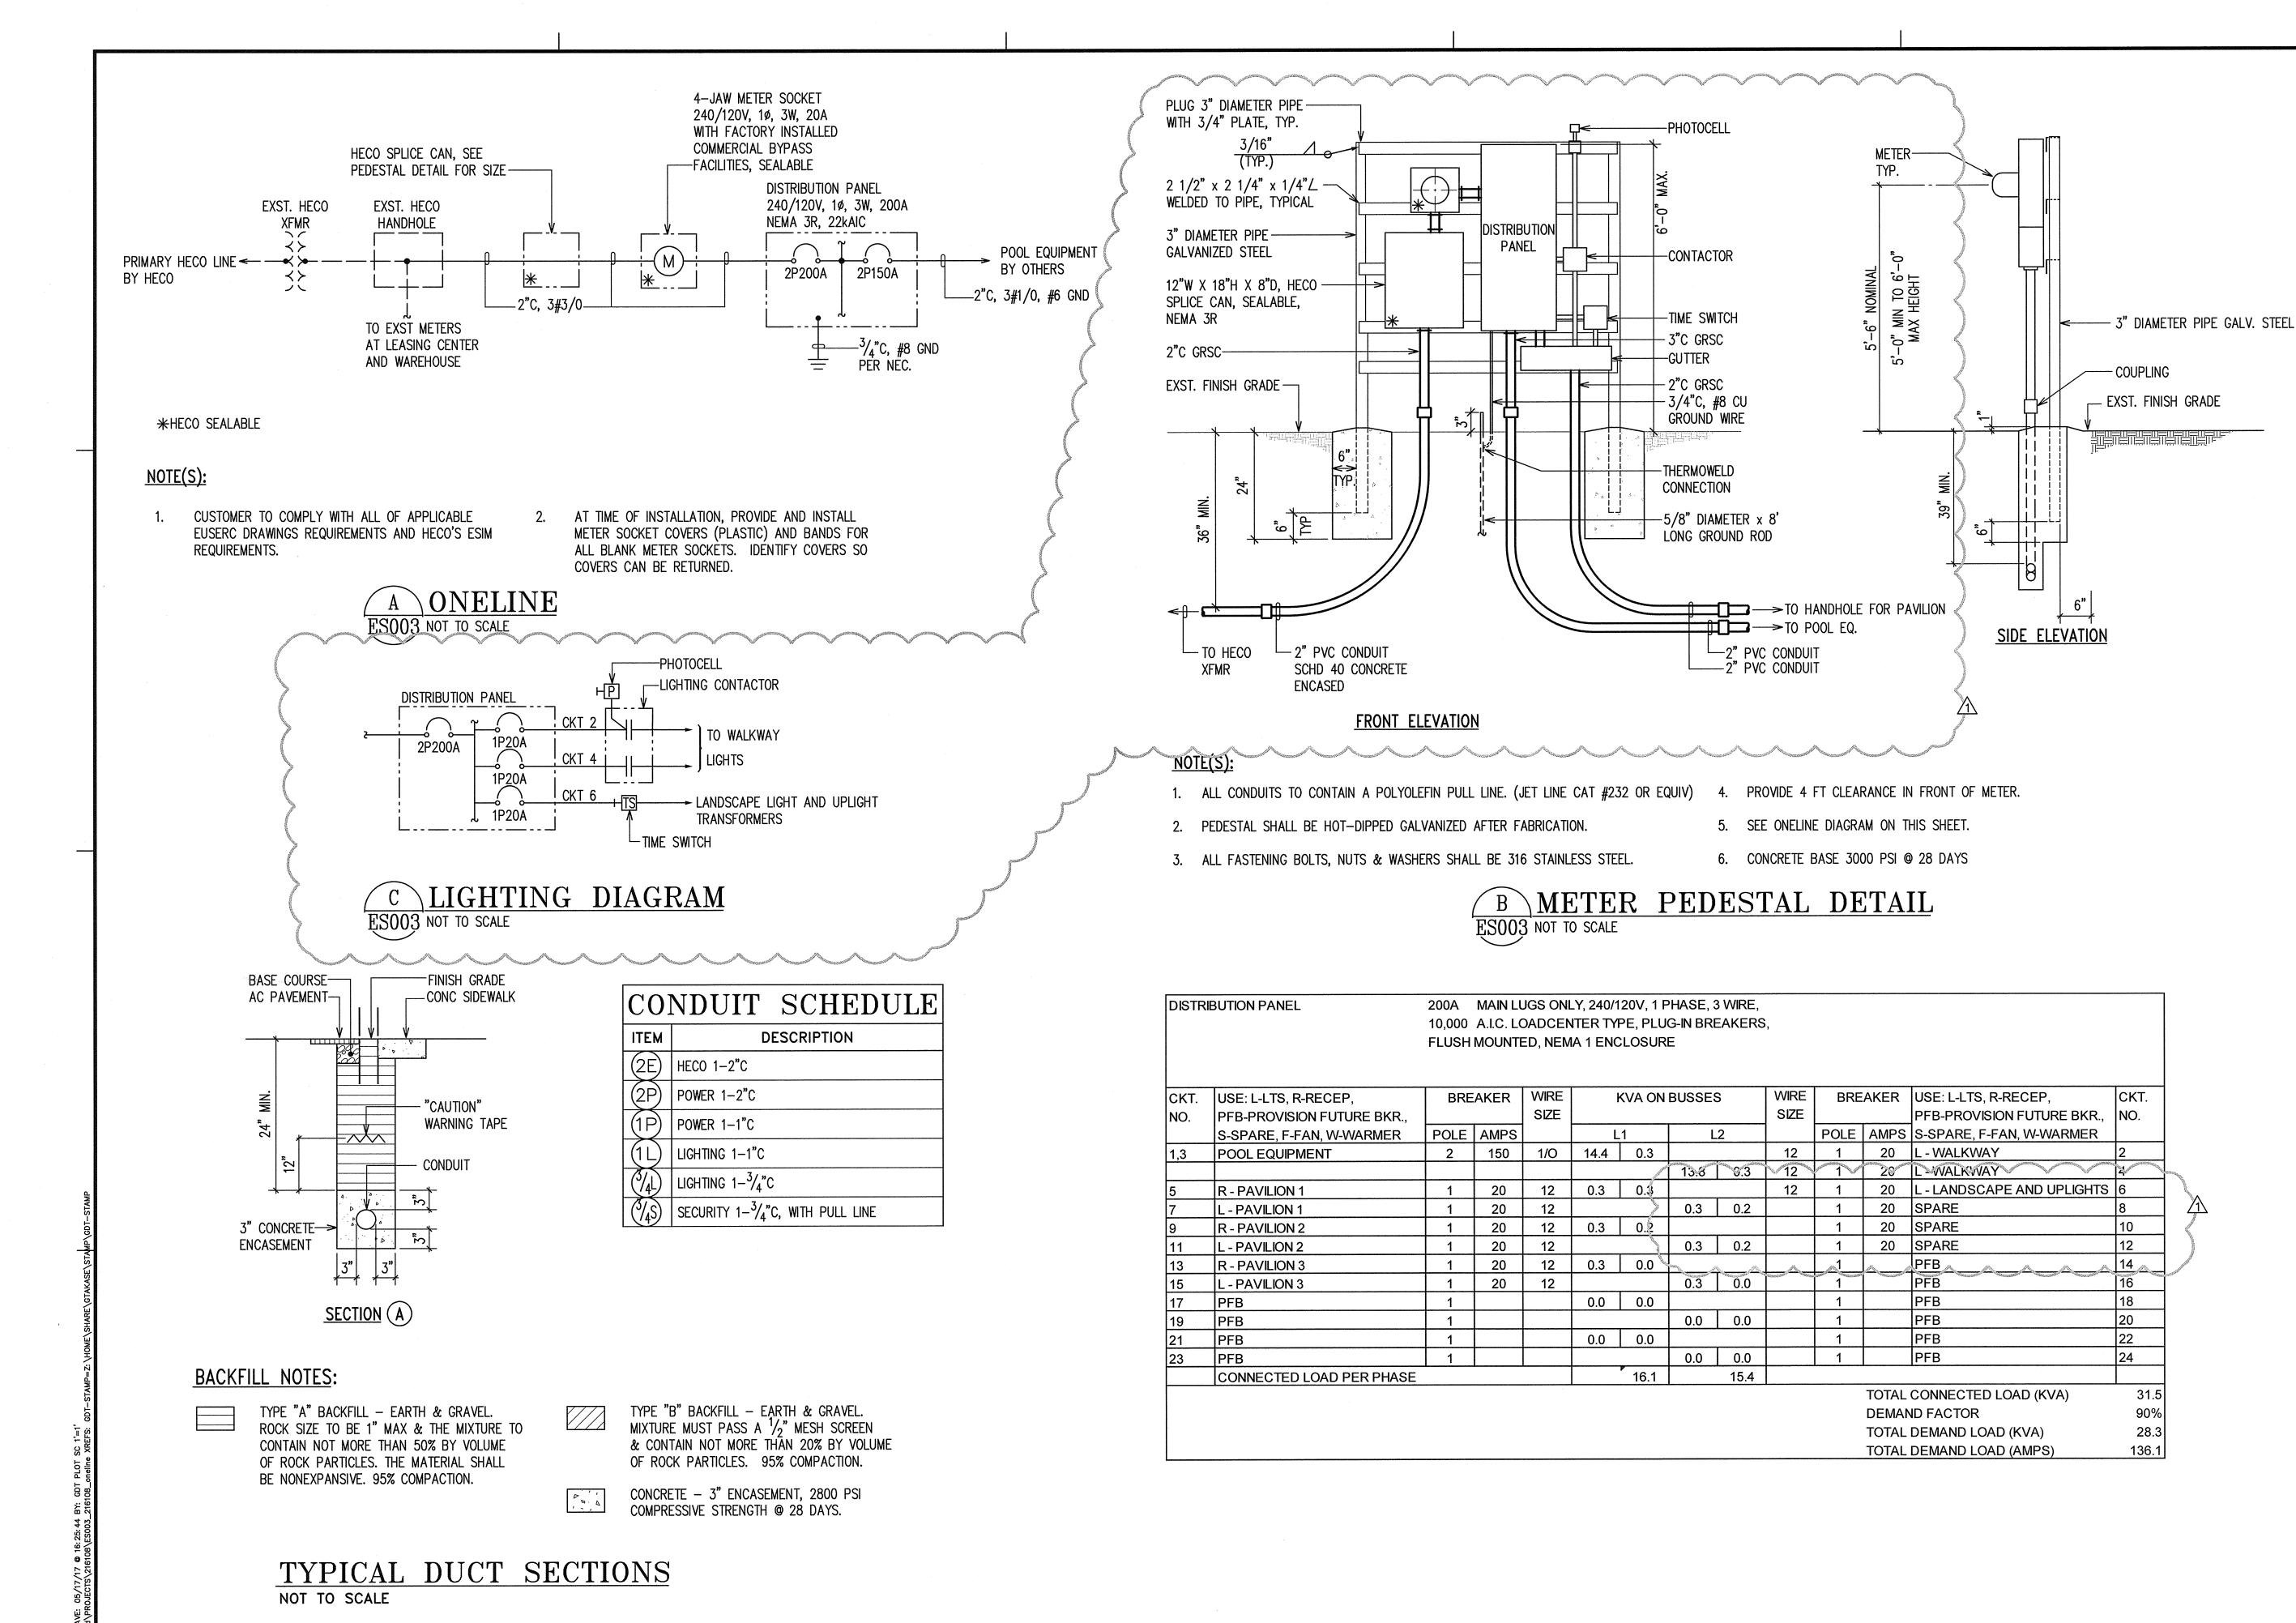
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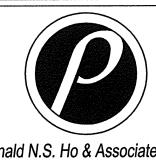
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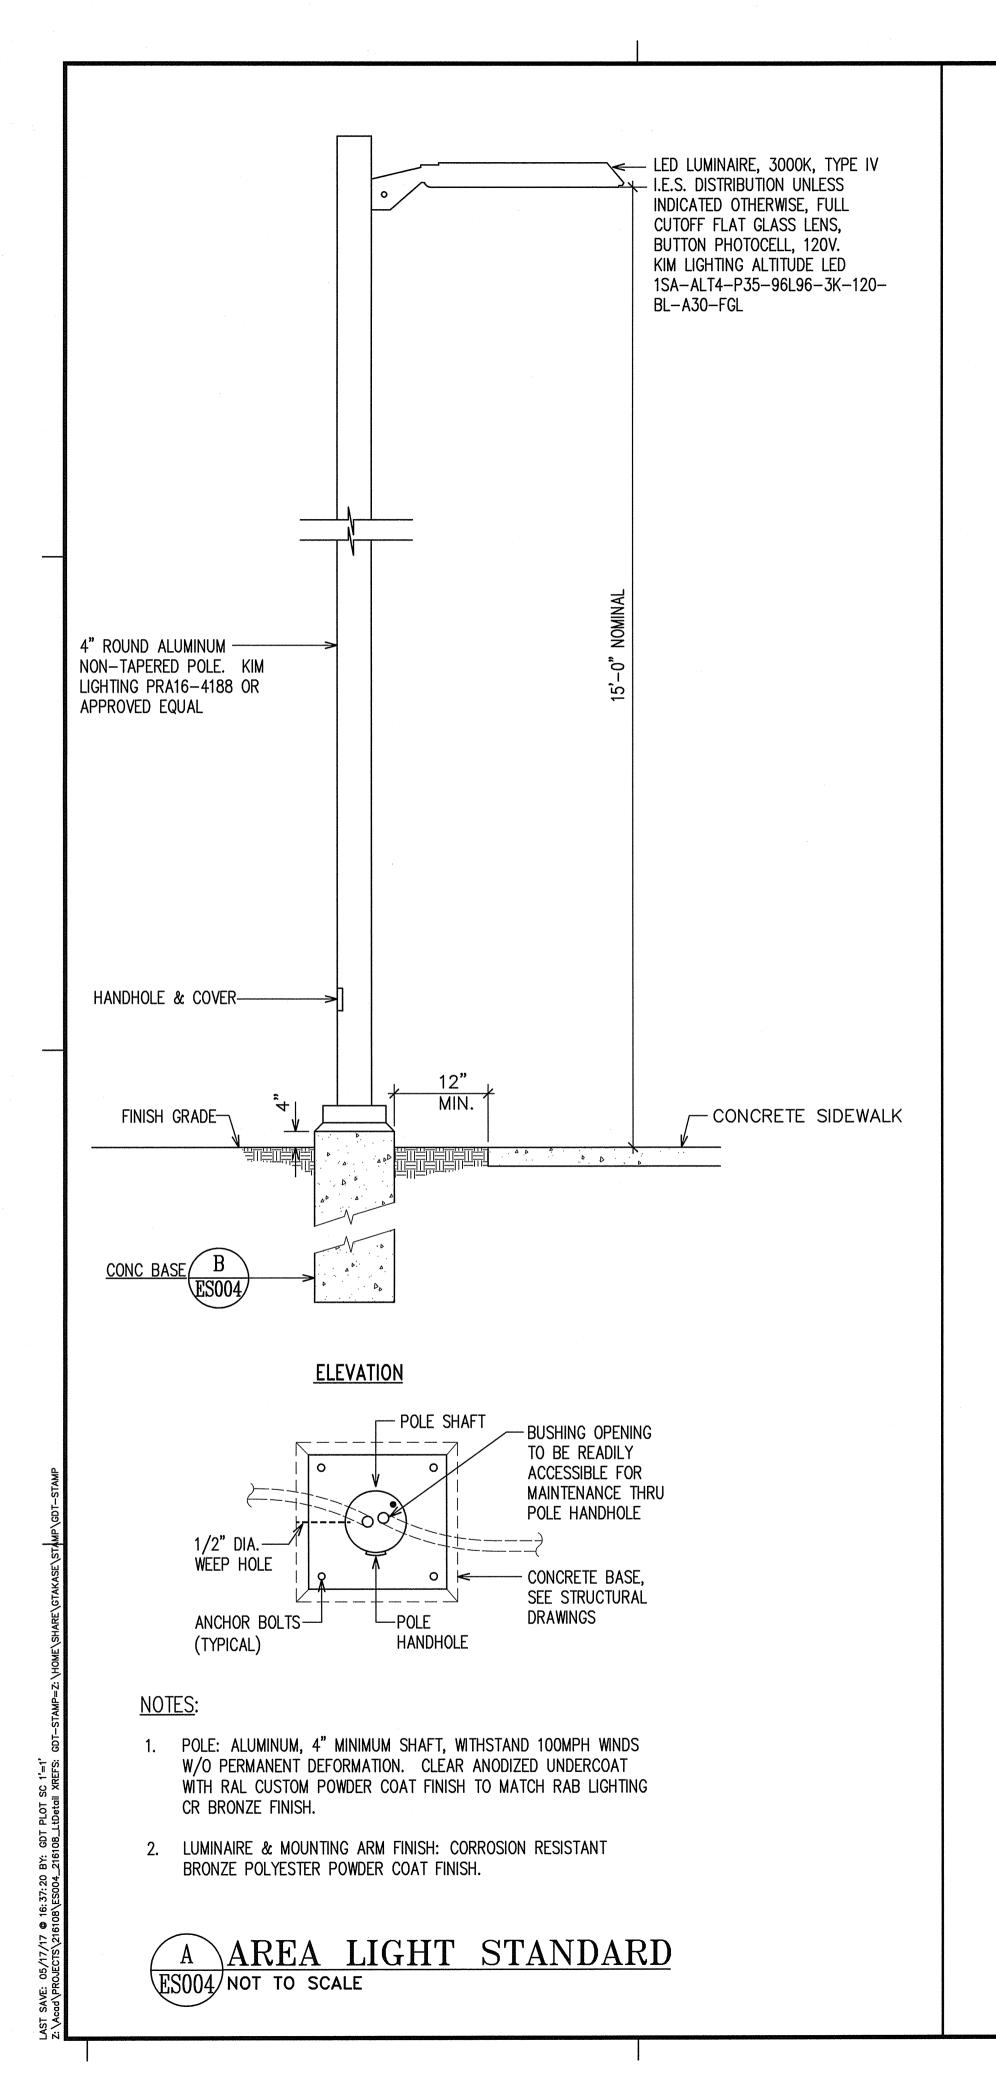
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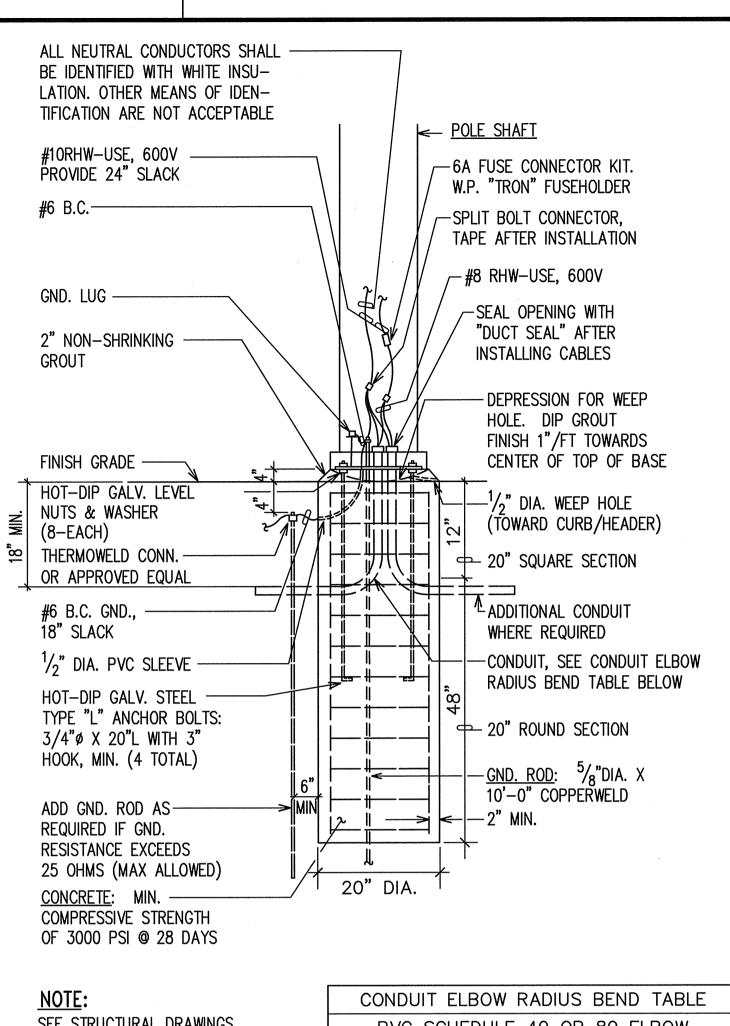
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NOTE:
SEE STRUCTURAL DRAWINGS
FOR CONCRETE BASE
REQUIREMENTS/DETAILS

CONDUIT ELBOW RADIUS BEND TABLE

PVC SCHEDULE 40 OR 80 ELBOW

NOMINAL CONDUIT SIZE $1^{1}/_{4}$ " $1^{1}/_{2}$ " 2"

MINIMUM RADIUS BEND 8" 10" 12"

B CONCRETE BASE ELEVATION
ES004 NOT TO SCALE



A R C H I T E C T S

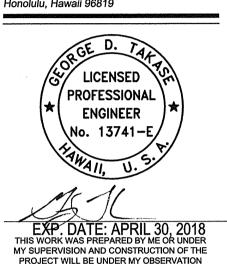
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